

4th Floor San Francisco California 94111

415 788-5216



O PROMETHEUS


401-445 S. B STREET

2/01/2023

## **NOT FOR** CONSTRUCTION

SHEET NAME:
OPEN SPACE DIAGRAM

L0.0

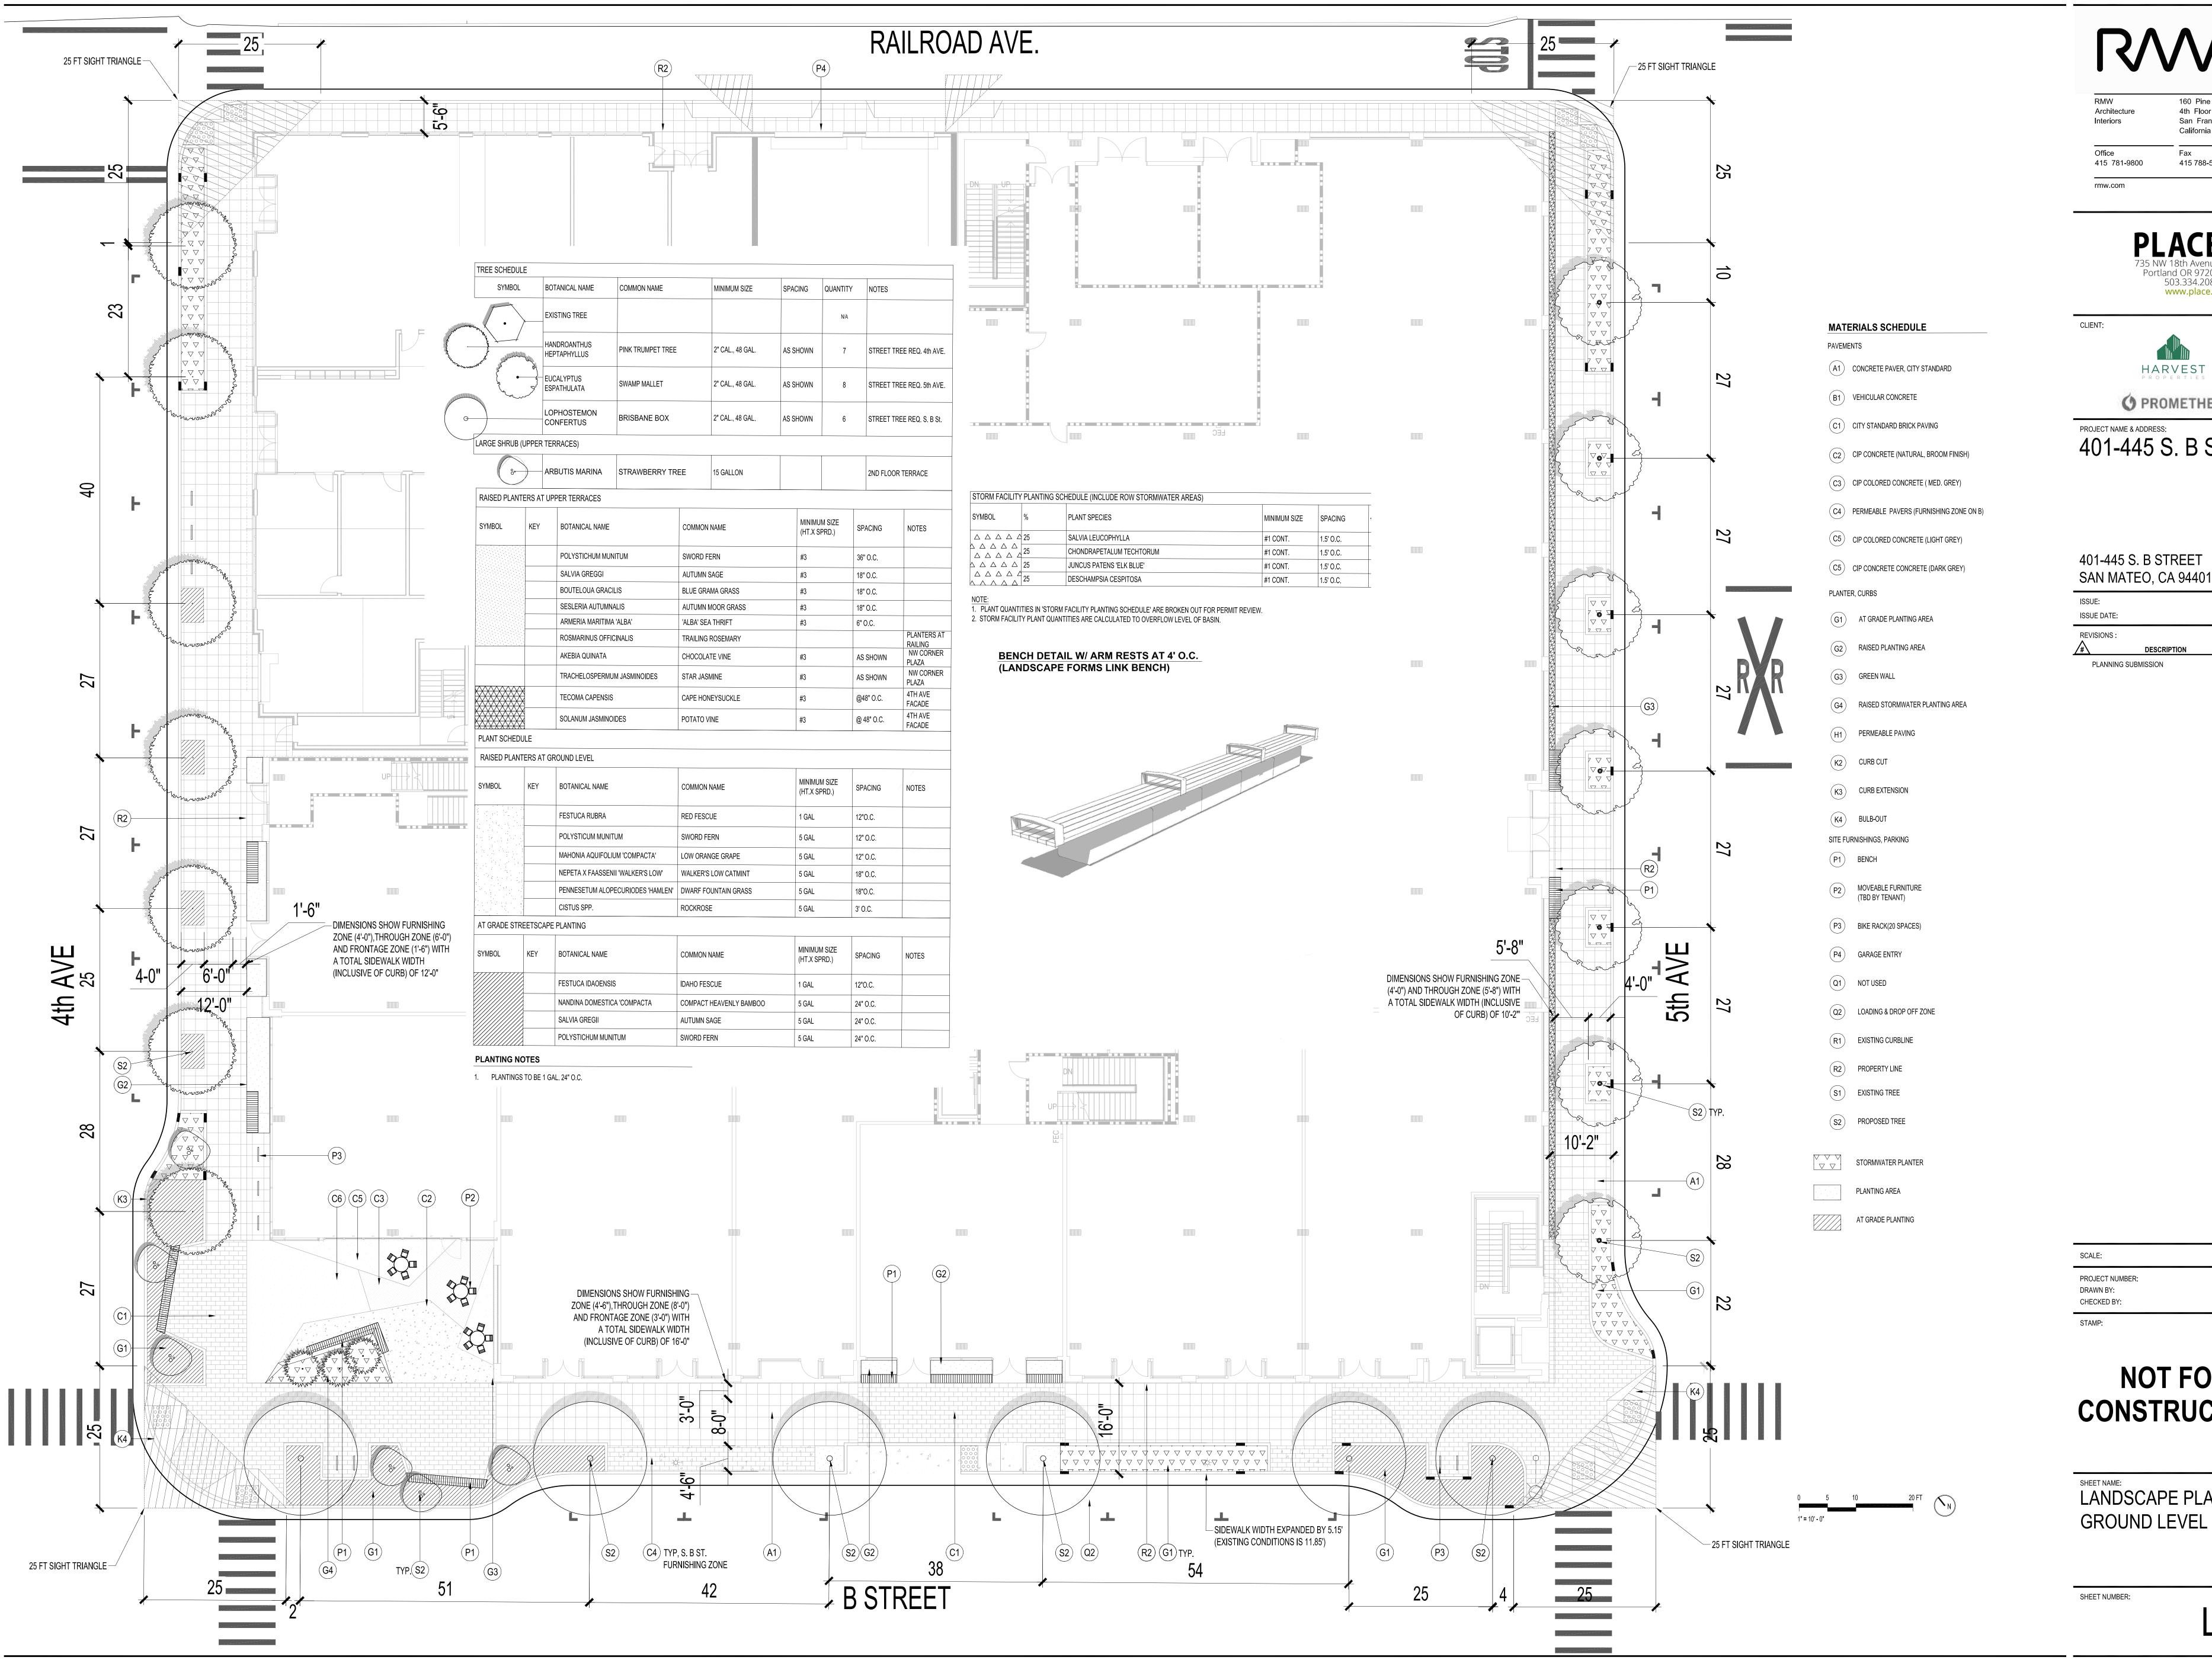

160 Pine Street 4th Floor San Francisco

Fax 415 788-5216





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401-445 S. B STREET

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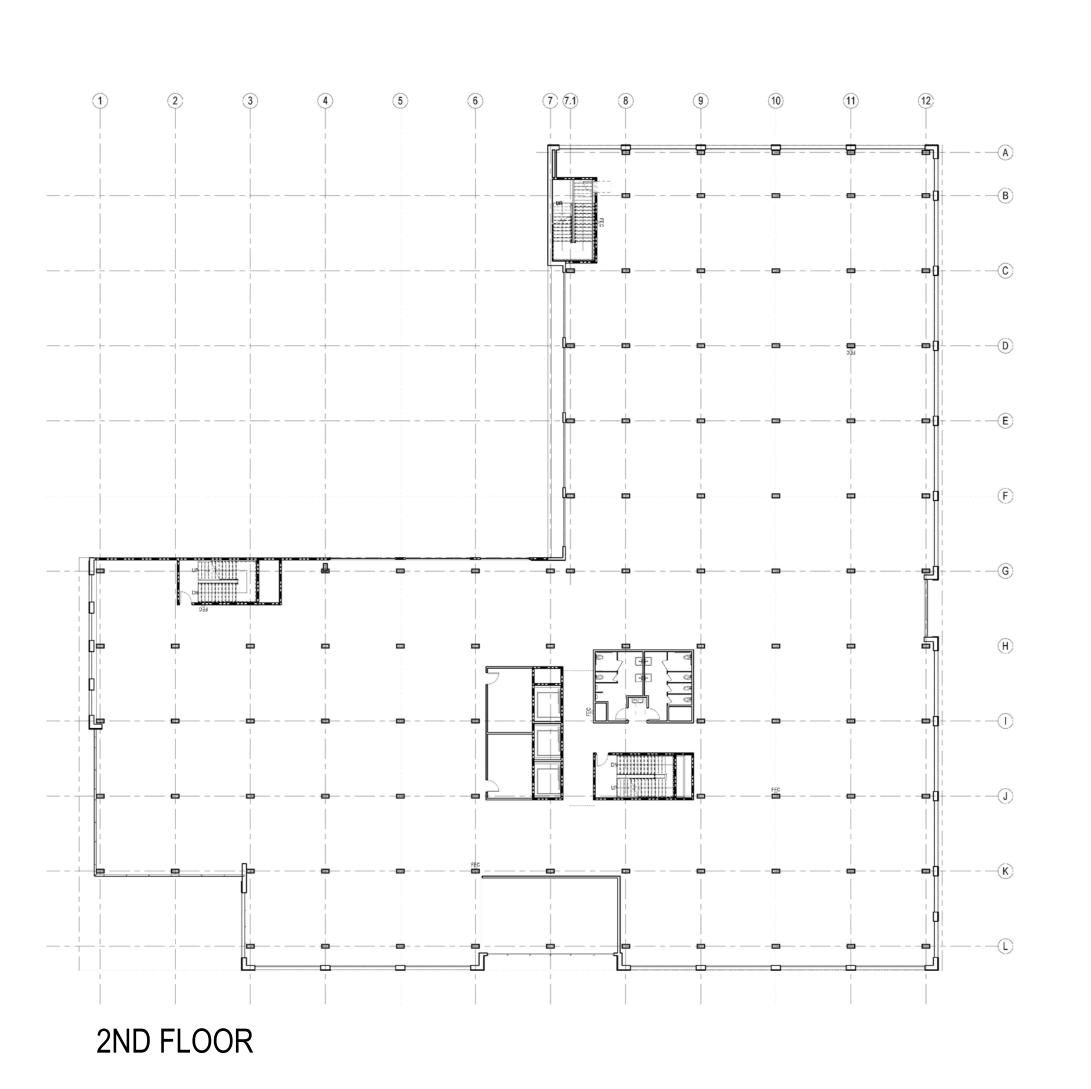
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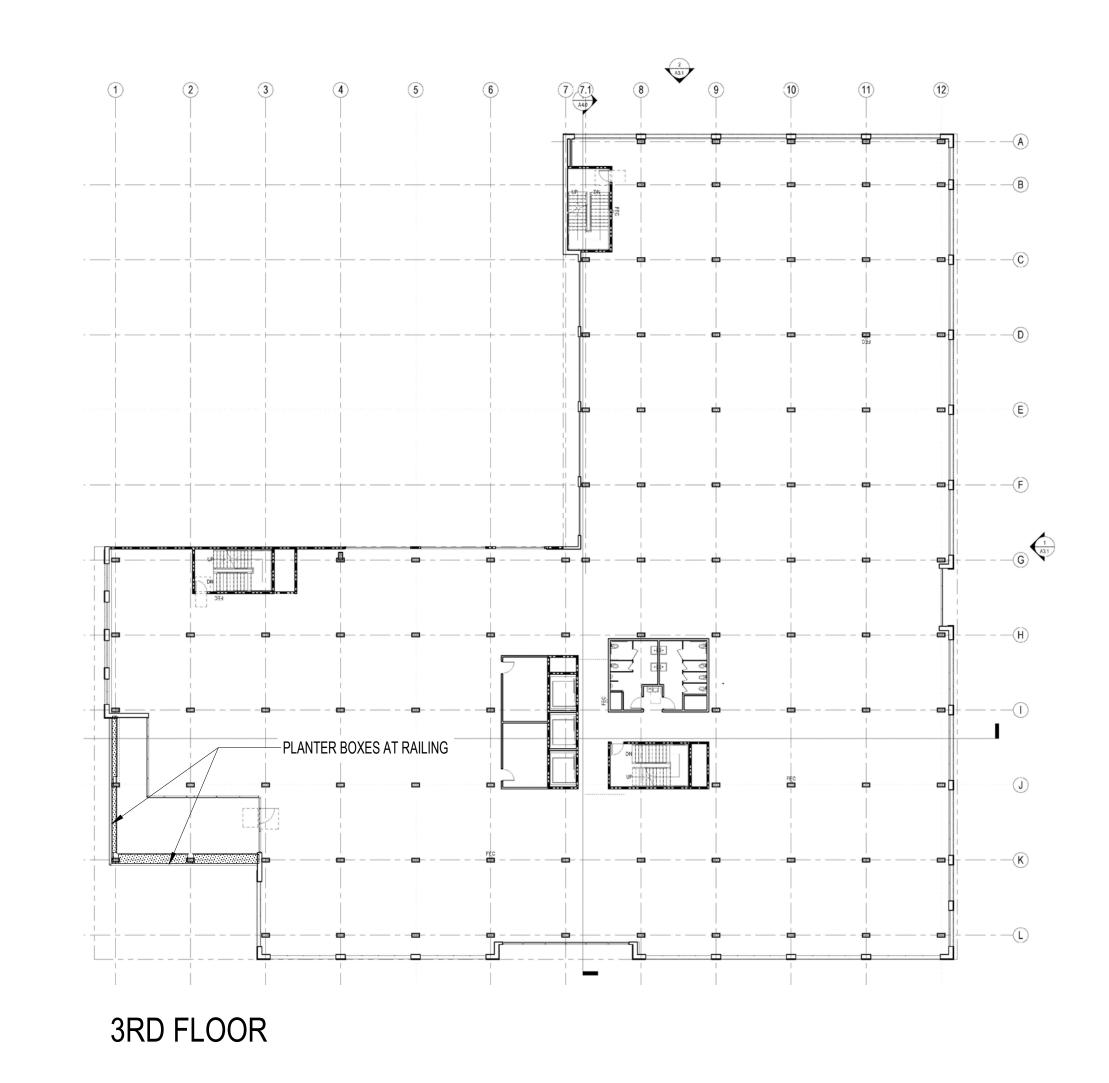
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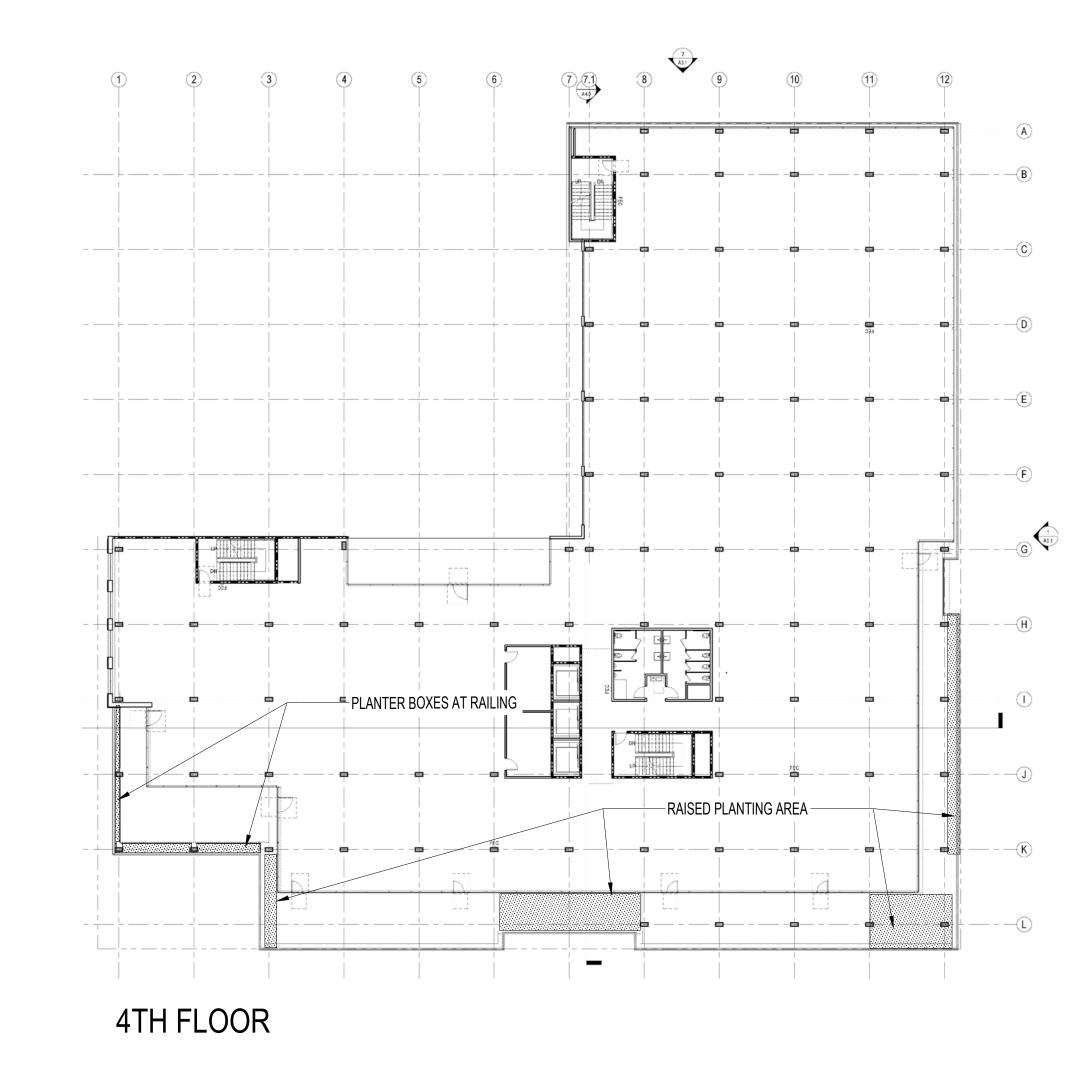
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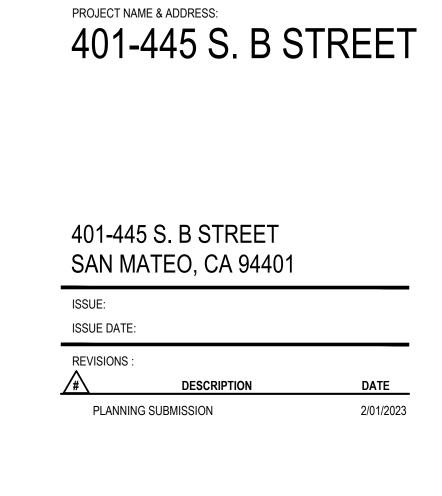
LANDSCAPE PLAN, **GROUND LEVEL** 

L.1.0









160 Pine Street

415 788-5216

PLACE
735 NW 18th Avenue
Portland OR 97209
503.334.2080
www.place.la

O PROMETHEUS

	SYMBOL	BOTANICAL NAME	COMMON NAME	MINIMUM SIZE	SPACING	QUANTITY	NOTES
and the second second	March .	EXISTING TREE				N/A	
A CONTRACTOR OF THE PARTY OF TH	week of the second of the seco	HANDROANTHUS HEPTAPHYLLUS	PINK TRUMPET TREE	2" CAL., 48 GAL.	AS SHOWN	7	STREET TREE REQ. 4th AVE.
		EUCALYPTUS ESPATHULATA	SWAMP MALLET	2" CAL., 48 GAL.	AS SHOWN	8	STREET TREE REQ. S. B ST.
	3	LOPHOSTEMON CONFERTUS	BRISBANE BOX	2" CAL., 48 GAL.	AS SHOWN	6	STREET TREE REQ. 5th AVE.
- m	LARGE SHRUB (UPPER	TERRACES)					
	80	ARBUTIS MARINA	STRAWBERRY TREE	15 GALLON			2ND FLOOR TERRACE

SYMBOL	KEY	BOTANICAL NAME	COMMON NAME	MINIMUM SIZE (HT.X SPRD.)	SPACING	NOTES
		POLYSTICHUM MUNITUM	SWORD FERN	#3	36" O.C.	
		SALVIA GREGGI	AUTUMN SAGE	#3	18" O.C.	
		BOUTELOUA GRACILIS	BLUE GRAMA GRASS	#3	18" O.C.	
		SESLERIA AUTUMNALIS	AUTUMN MOOR GRASS	#3	18" O.C.	
		ARMERIA MARITIMA 'ALBA'	'ALBA' SEA THRIFT	#3	6" O.C.	
		ROSMARINUS OFFICINALIS	TRAILING ROSEMARY			PLANTERS A RAILING
		AKEBIA QUINATA	CHOCOLATE VINE	#3	AS SHOWN	NW CORNE
		TRACHELOSPERMUM JASMINOIDES	STAR JASMINE	#3	AS SHOWN	NW CORNE
	<del>X</del>	TECOMA CAPENSIS	CAPE HONEYSUCKLE	#3	@48" O.C.	4TH AVE FACADE
		SOLANUM JASMINOIDES	POTATO VINE	#3	@ 48" O.C.	4TH AVE FACADE

SYMBOL	KEY	BOTANICAL NAME	COMMON NAME	MINIMUM SIZE	SPACING	NOTES
				(HT.X SPRD.)		
		FESTUCA RUBRA	RED FESCUE	1 GAL	12"O.C.	
		POLYSTICUM MUNITUM	SWORD FERN	5 GAL	12" O.C.	
	:	MAHONIA AQUIFOLIUM 'COMPACTA'	LOW ORANGE GRAPE	5 GAL	12" O.C.	
		NEPETA X FAASSENII 'WALKER'S LOW'	WALKER'S LOW CATMINT	5 GAL	18" O.C.	
		PENNESETUM ALOPECURIODES 'HAMLEN'	DWARF FOUNTAIN GRASS	5 GAL	18"O.C.	
	:	CISTUS SPP.	ROCKROSE	5 GAL	3' O.C.	
AT GRADE ST	REETSCAF	PE PLANTING				•
SYMBOL	KEY	BOTANICAL NAME	COMMON NAME	MINIMUM SIZE (HT.X SPRD.)	SPACING	NOTES
		FESTUCA IDAOENSIS	IDAHO FESCUE	1 GAL	12"O.C.	
		NANDINA DOMESTICA 'COMPACTA	COMPACT HEAVENLY BAMBOO	5 GAL	24" O.C.	
		SALVIA GREGII	AUTUMN SAGE	5 GAL	24" O.C.	
		POLYSTICHUM MUNITUM	SWORD FERN	5 GAL	24" O.C.	


PLANTING	NOTES

TREE SCHEDULE

1.	PLANTINGS TO BE 1 GAL. 24" O.C.

STORM FACILITY	PLANTING SCI	HEDULE (INCLUDE ROW STORMWATER AREAS)			
SYMBOL	%	PLANT SPECIES	MINIMUM SIZE	SPACING	QUANTITY
	25	SALVIA LEUCOPHYLLA	#1 CONT.	1.5' O.C.	
	25	CHONDRAPETALUM TECHTORUM	#1 CONT.	1.5' O.C.	
	25	JUNCUS PATENS 'ELK BLUE'	#1 CONT.	1.5' O.C.	
	25	DESCHAMPSIA CESPITOSA	#1 CONT.	1.5' O.C.	

1. PLANT QUANTITIES IN 'STORM FACILITY PLANTING SCHEDULE' ARE BROKEN OUT FOR PERMIT REVIEW. 2. STORM FACILITY PLANT QUANTITIES ARE CALCULATED TO OVERFLOW LEVEL OF BASIN.

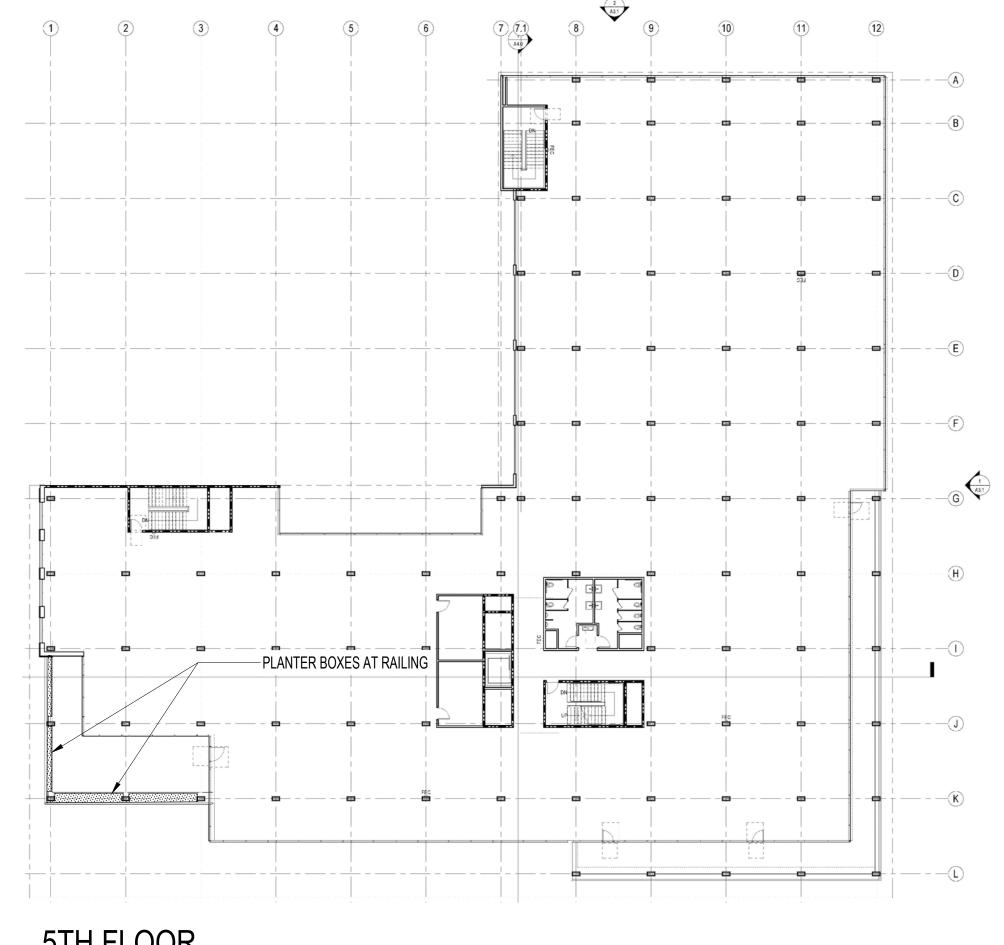

5TH FLOOR

NOT FOR
CONSTRUCTION

SHEET NAME:

LANDSCAPE PLAN-DIAGRAMS, 2ND, 3RD, 4TH & 5TH FLOORS

SHEET NUMBER:


SCALE:

PROJECT NUMBER: DRAWN BY: CHECKED BY:

## FOR ILLUSTRATIVE PURPOSES ONLY



CORNER PLAZA AT 4TH AVE & S. B STREET. GREENWALL ON NORTH FACADE WITH PLANTING AT UPPER TERRACES. PALMS LINK THE LARGE CORNER PLANTER TO THE UPPER LEVELS WITH VEGETATION.

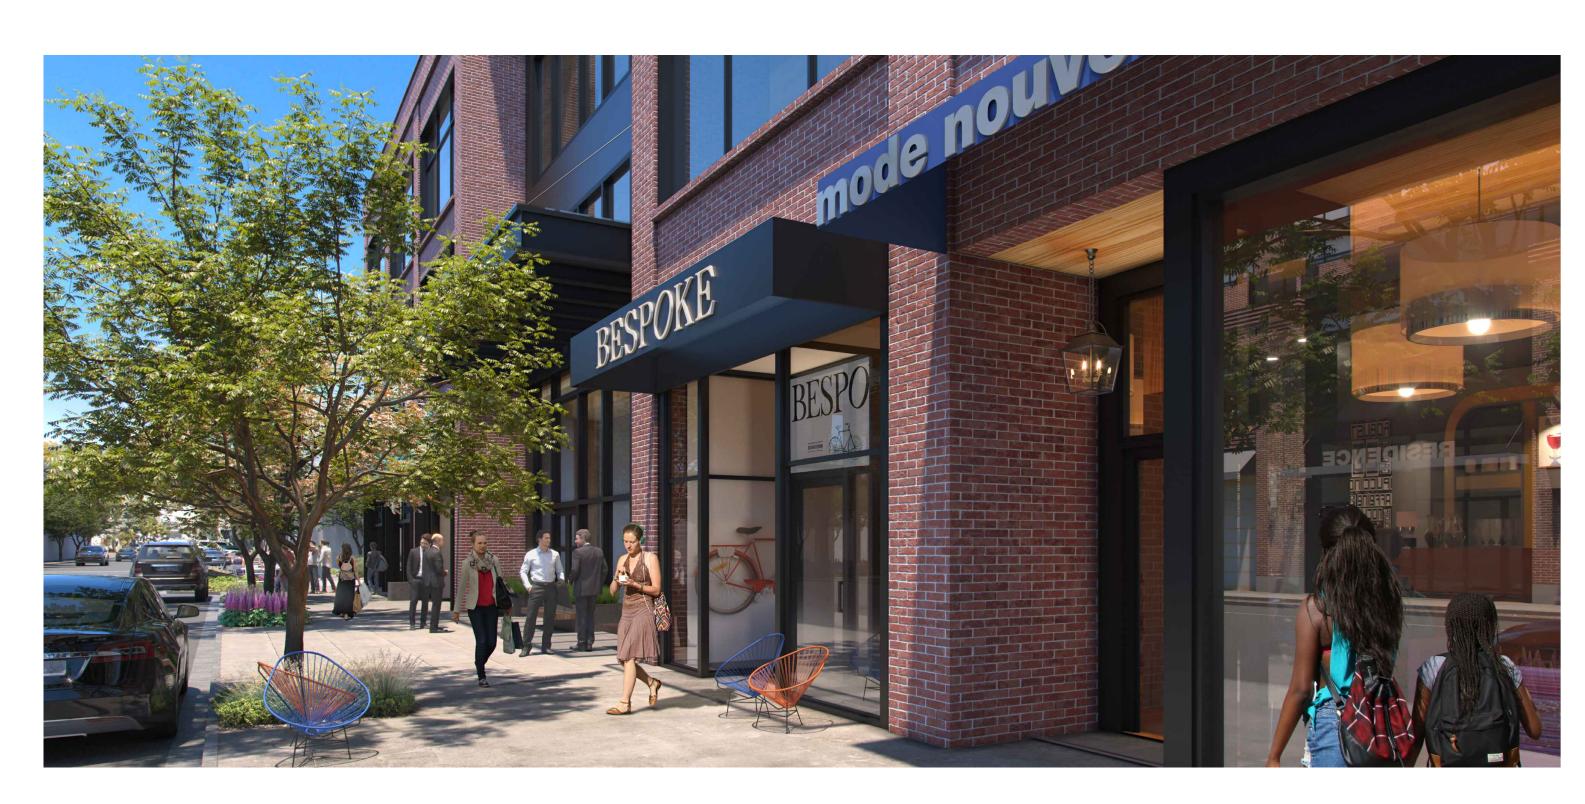

MID BLOCK ENTRY, SHOWING WIDENED SIDEWALK AND SEATING AREAS IN FRONTAGE ZONE.



CORNER PLAZA AT 4TH AVE & S. B STREET. LARGE CORNER PLANTER RECHARGES GROUNDWATER. BULBOUT AND CURB EXTENSIONS ALLOW FOR ENHANCED PLANTING AND ALCOVES FOR SEATING. (BIRDSEYE)



GROUND LEVEL PLANTING AREAS BRIDGE TO THE UPPER LEVELS VIA PALMS AND GREEN WALL FEATURE. LOOKING DIAGONALLY FROM THE NORTHEAST CORNER OF 4TH AVE AND S. B STREET.

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RMW	160 Pine Stree
Architecture	4th Floor
Interiors	San Francisco
	San Francisco California 9411



CLIENT:



O PROMETHEUS

PROJECT NAME & ADDRESS:
401-445 S. B STREET

401-445 S. B STREET

SAN MATEO, CA 94401

ISSUE:
ISSUE DATE:

REVISIONS:

DESCRIPTION

PLANNING SUBMISSION 2/01/2023

SCALE:

PROJECT NUMBER: 2202017.0

DRAWN BY: TH


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# NOT FOR CONSTRUCTION

ILLUSTRATIVE RENDERINGS

SHEET NUMBER:

L2.0

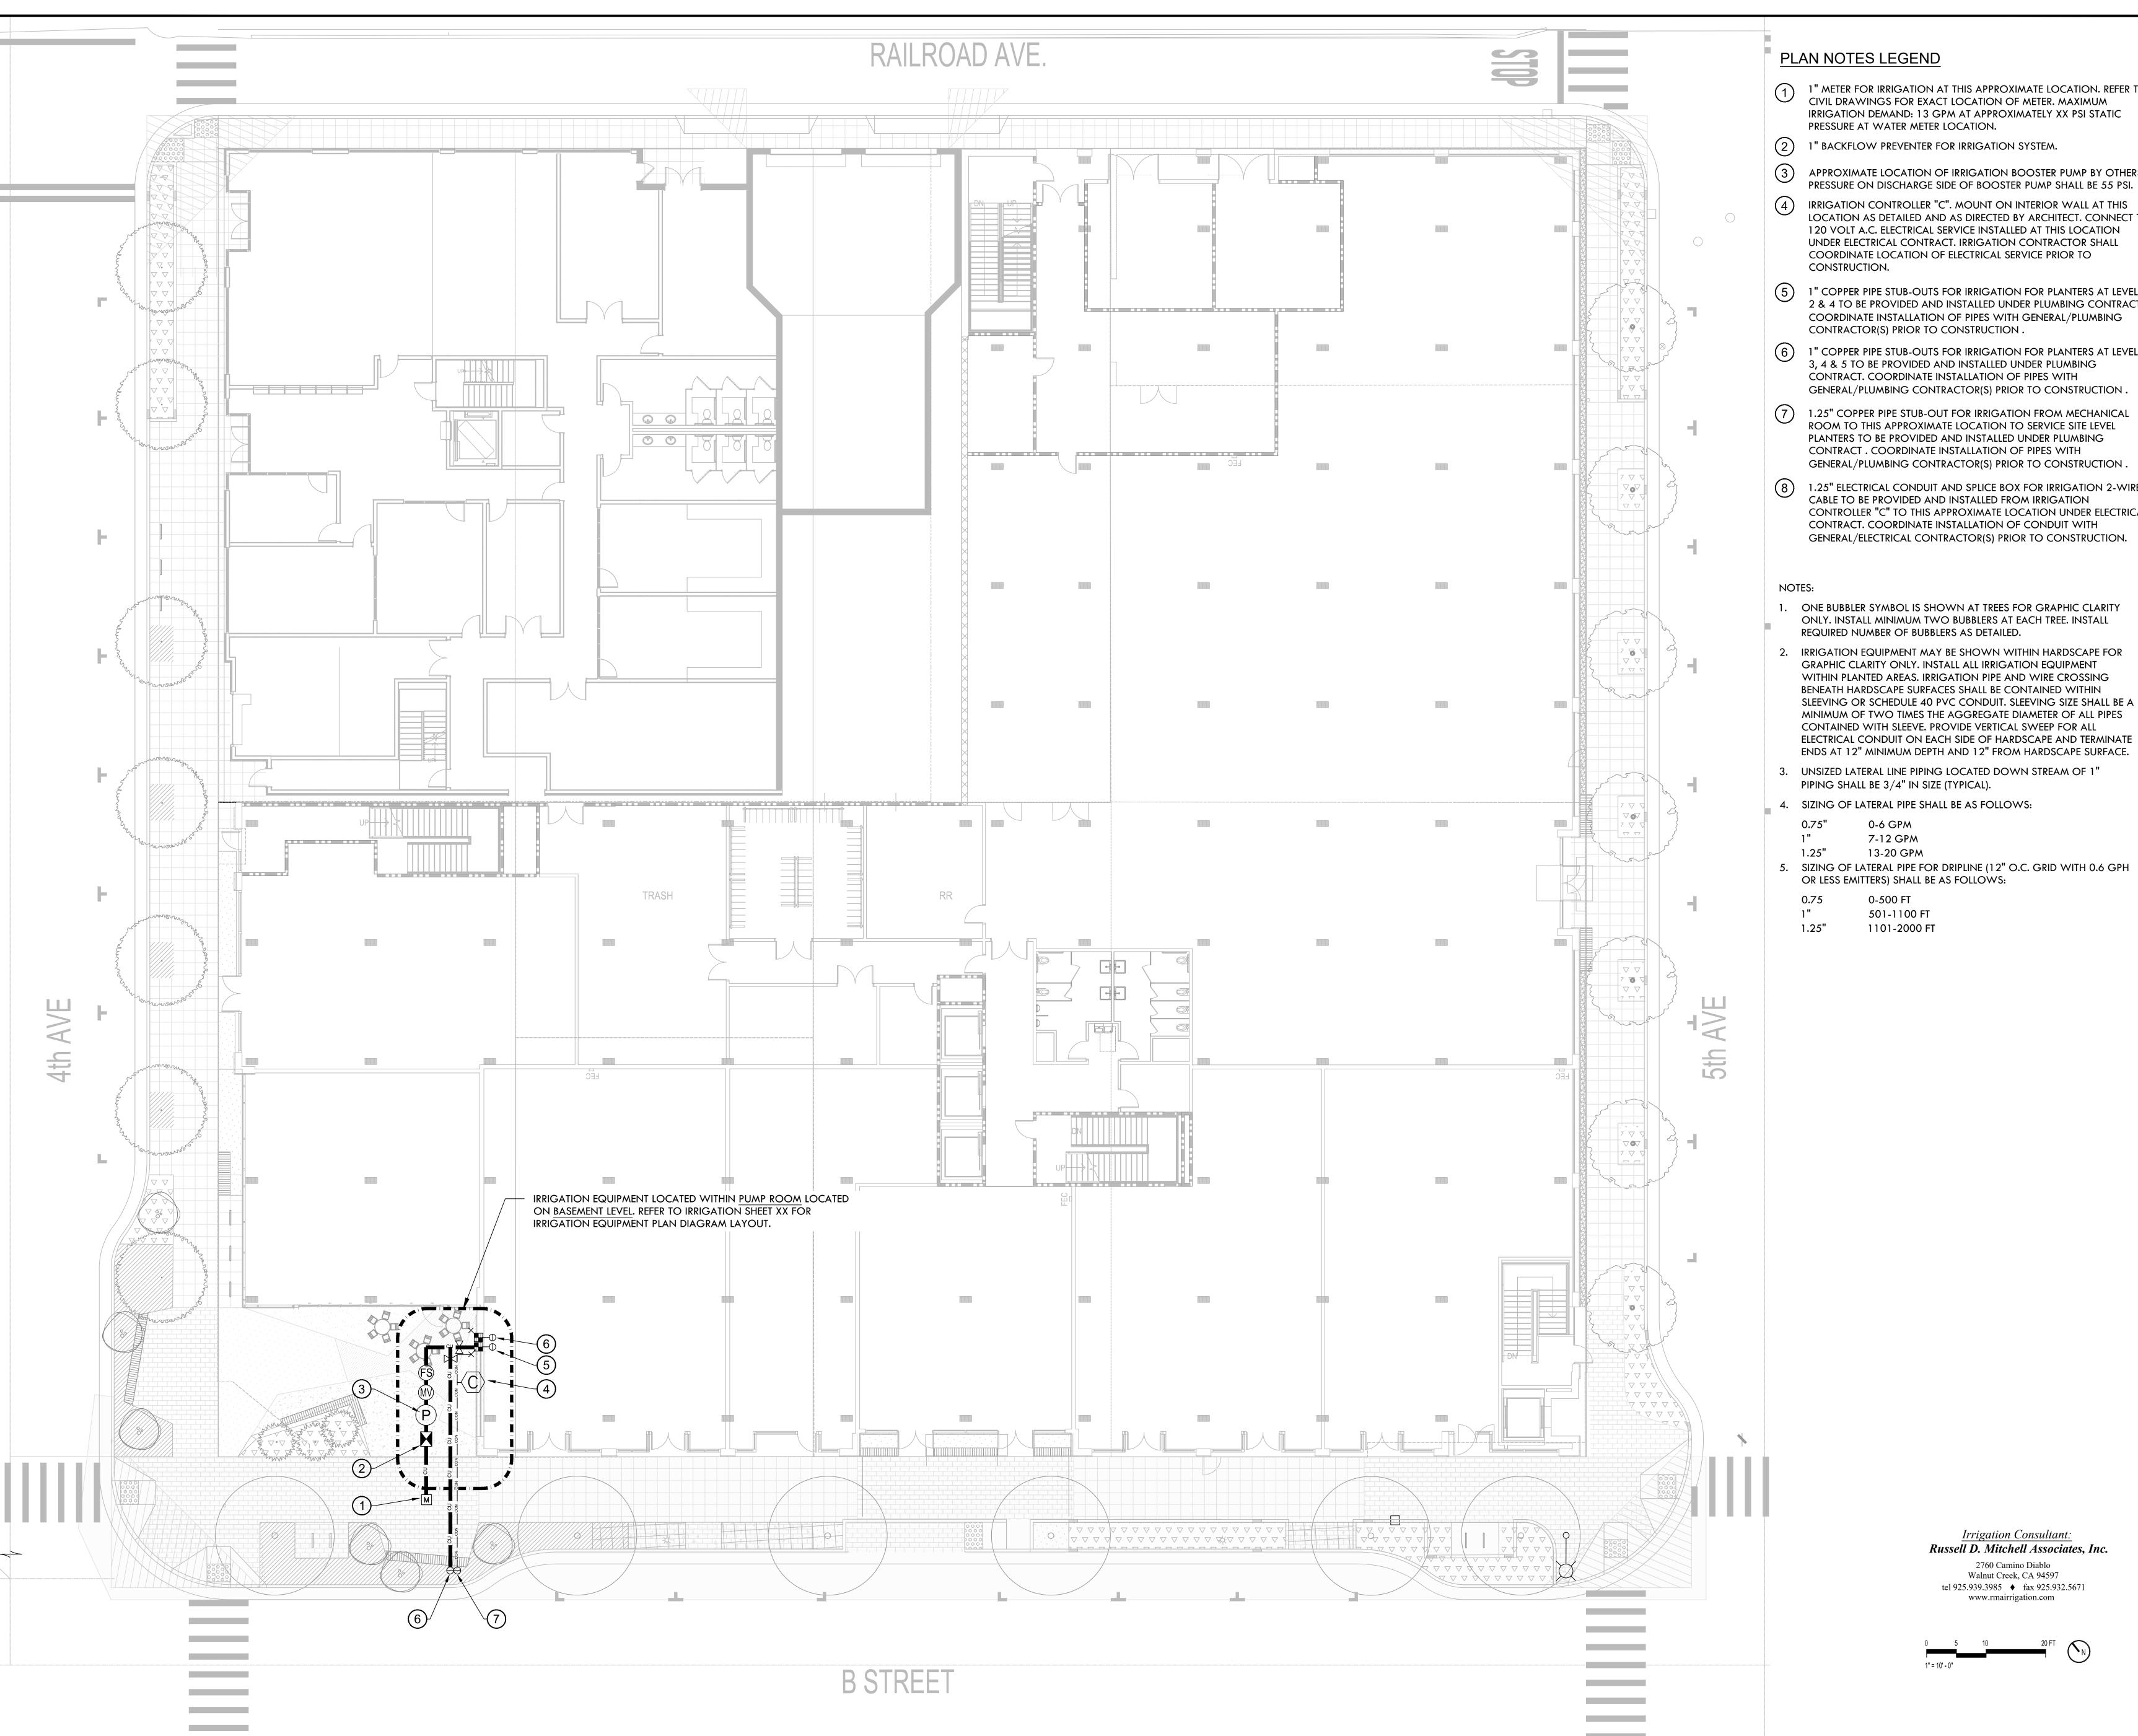

- 1" METER FOR IRRIGATION AT THIS APPROXIMATE LOCATION. REFER TO CIVIL DRAWINGS FOR EXACT LOCATION OF METER. MAXIMUM IRRIGATION DEMAND: 13 GPM AT APPROXIMATELY XX PSI STATIC PRESSURE AT WATER METER LOCATION.
- 3 APPROXIMATE LOCATION OF IRRIGATION BOOSTER PUMP BY OTHERS. PRESSURE ON DISCHARGE SIDE OF BOOSTER PUMP SHALL BE 55 PSI.
- 4 IRRIGATION CONTROLLER "C". MOUNT ON INTERIOR WALL AT THIS LOCATION AS DETAILED AND AS DIRECTED BY ARCHITECT. CONNECT TO 120 VOLT A.C. ELECTRICAL SERVICE INSTALLED AT THIS LOCATION UNDER ELECTRICAL CONTRACT. IRRIGATION CONTRACTOR SHALL COORDINATE LOCATION OF ELECTRICAL SERVICE PRIOR TO
- 1" COPPER PIPE STUB-OUTS FOR IRRIGATION FOR PLANTERS AT LEVELS 2 & 4 TO BE PROVIDED AND INSTALLED UNDER PLUMBING CONTRACT. COORDINATE INSTALLATION OF PIPES WITH GENERAL/PLUMBING CONTRACTOR(S) PRIOR TO CONSTRUCTION.
- 1" COPPER PIPE STUB-OUTS FOR IRRIGATION FOR PLANTERS AT LEVELS CLIENT: 3, 4 & 5 TO BE PROVIDED AND INSTALLED UNDER PLUMBING CONTRACT. COORDINATE INSTALLATION OF PIPES WITH
- 1.25" COPPER PIPE STUB-OUT FOR IRRIGATION FROM MECHANICAL ROOM TO THIS APPROXIMATE LOCATION TO SERVICE SITE LEVEL PLANTERS TO BE PROVIDED AND INSTALLED UNDER PLUMBING CONTRACT. COORDINATE INSTALLATION OF PIPES WITH GENERAL/PLUMBING CONTRACTOR(S) PRIOR TO CONSTRUCTION.
- 1.25" ELECTRICAL CONDUIT AND SPLICE BOX FOR IRRIGATION 2-WIRE CABLE TO BE PROVIDED AND INSTALLED FROM IRRIGATION CONTROLLER "C" TO THIS APPROXIMATE LOCATION UNDER ELECTRICAL CONTRACT. COORDINATE INSTALLATION OF CONDUIT WITH GENERAL/ELECTRICAL CONTRACTOR(S) PRIOR TO CONSTRUCTION.
- 1. ONE BUBBLER SYMBOL IS SHOWN AT TREES FOR GRAPHIC CLARITY ONLY. INSTALL MINIMUM TWO BUBBLERS AT EACH TREE. INSTALL REQUIRED NUMBER OF BUBBLERS AS DETAILED.
- 2. IRRIGATION EQUIPMENT MAY BE SHOWN WITHIN HARDSCAPE FOR GRAPHIC CLARITY ONLY. INSTALL ALL IRRIGATION EQUIPMENT WITHIN PLANTED AREAS. IRRIGATION PIPE AND WIRE CROSSING BENEATH HARDSCAPE SURFACES SHALL BE CONTAINED WITHIN SLEEVING OR SCHEDULE 40 PVC CONDUIT. SLEEVING SIZE SHALL BE A MINIMUM OF TWO TIMES THE AGGREGATE DIAMETER OF ALL PIPES CONTAINED WITH SLEEVE, PROVIDE VERTICAL SWEEP FOR ALL ELECTRICAL CONDUIT ON EACH SIDE OF HARDSCAPE AND TERMINATE ENDS AT 12" MINIMUM DEPTH AND 12" FROM HARDSCAPE SURFACE.
- 3. UNSIZED LATERAL LINE PIPING LOCATED DOWN STREAM OF 1" PIPING SHALL BE 3/4" IN SIZE (TYPICAL).
- 4. SIZING OF LATERAL PIPE SHALL BE AS FOLLOWS:

0-6 GPM 7-12 GPM

13-20 GPM

0-500 FT 501-1100 FT RVV

RMW 160 Pine Street Architecture 4th Floor San Francisco

California 94111 Office Fax 415 788-5216

415 781-9800

Portland OR 97209 503.334.2080

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HARVEST

() PROMETHEUS

PROJECT NAME & ADDRESS: BESPOKE

401-445 S. B STREET SAN MATEO, CA 94401

ISSUE: ISSUE DATE:

**REVISIONS:** DESCRIPTION PRE-APPLICATION 2 PRE-APPLICATION RESUBMISSION

6/10/2022

PROJECT NUMBER: CHECKED BY:

## NOT FOR CONSTRUCTION


Irrigation Consultant: Russell D. Mitchell Associates, Inc. 2760 Camino Diablo Walnut Creek, CA 94597 tel 925.939.3985 ♦ fax 925.932.5671 www.rmairrigation.com







SHEET NUMBER:

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## PROJECT NAME & ADDRESS: BESPOKE 401-445 S. B STREET SAN MATEO, CA 94401 ISSUE: ISSUE DATE: **REVISIONS:** 6/10/2022
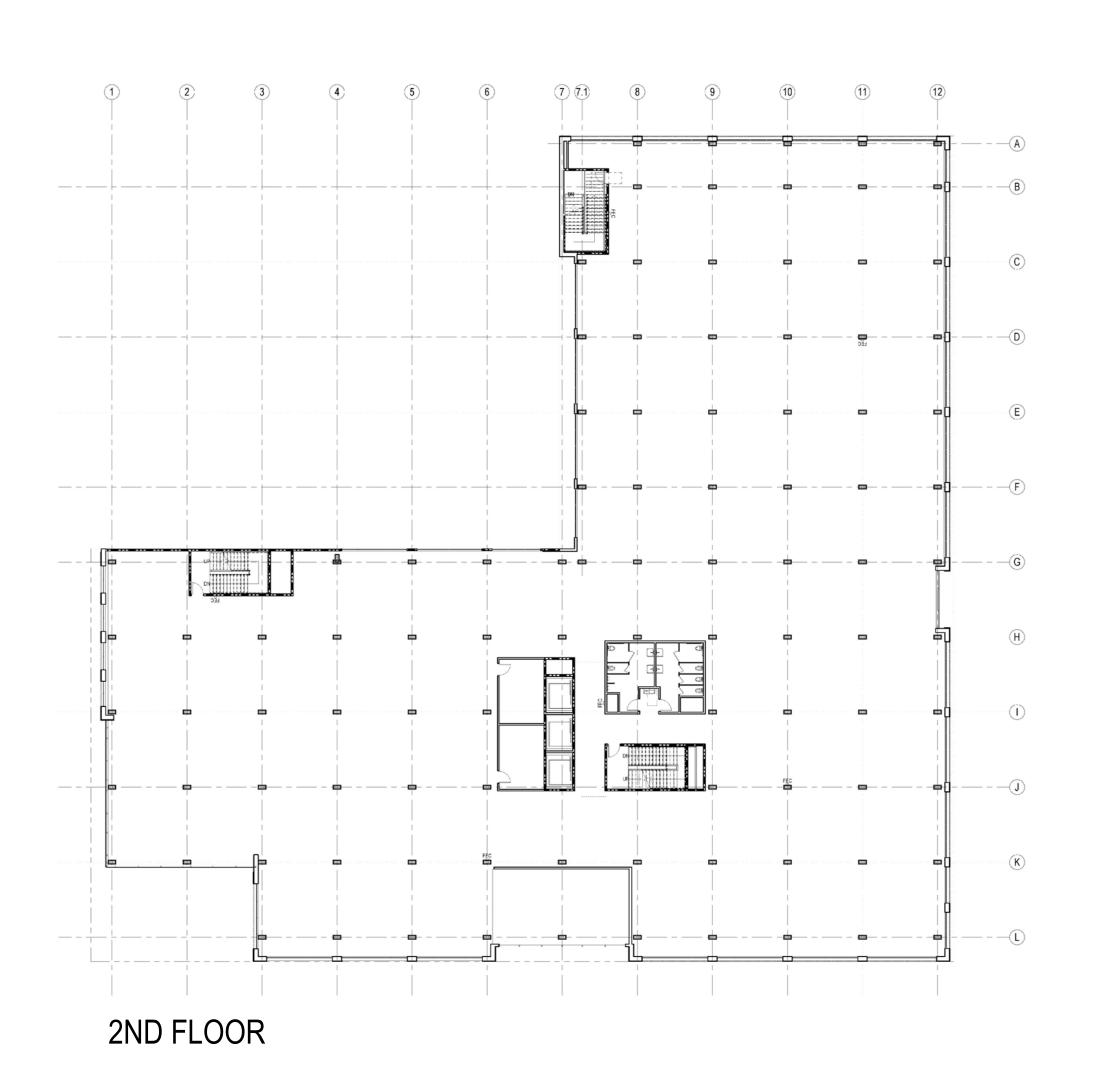
### PLAN NOTES LEGEND

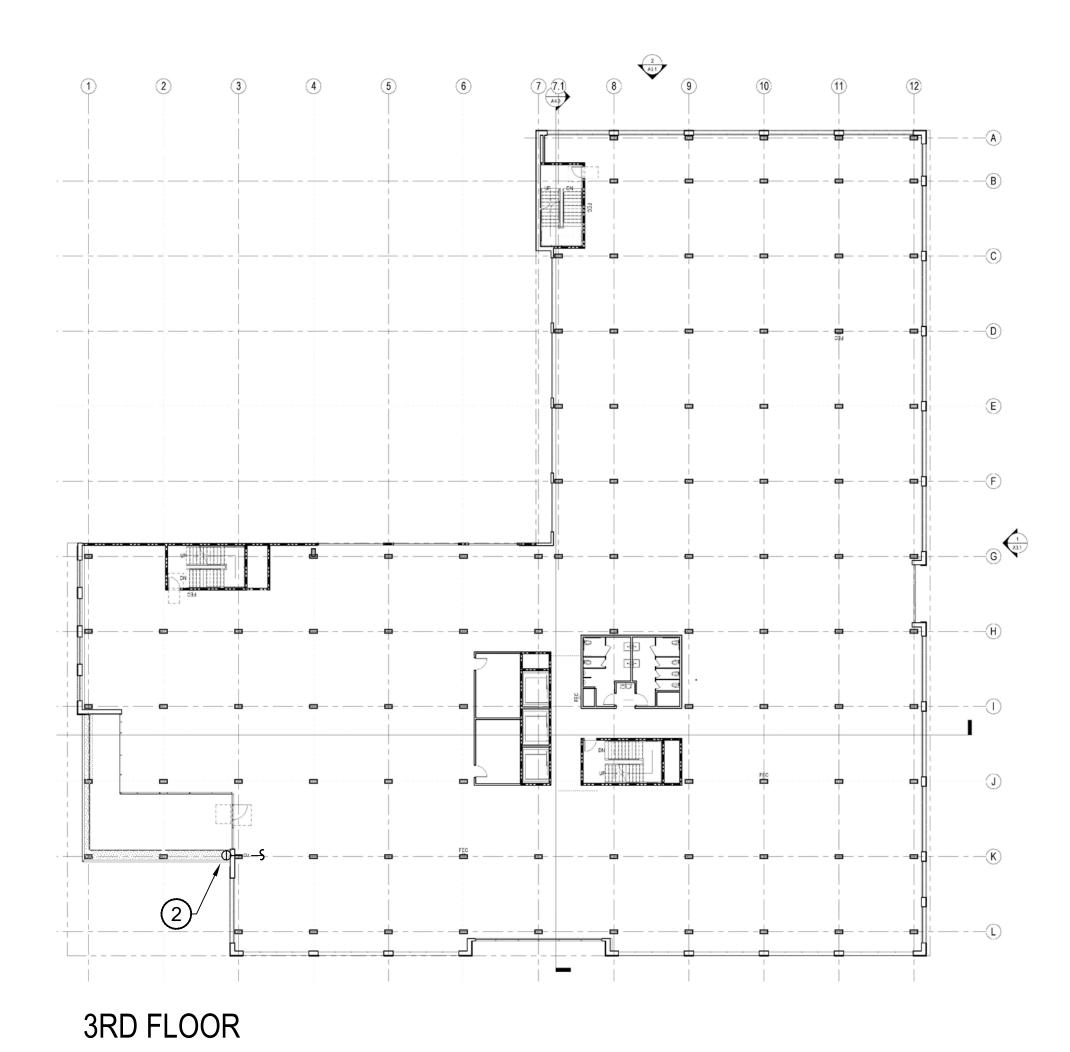- 1" COPPER PIPE STUB-OUTS FOR IRRIGATION FROM REMOTE CONTROL VALVE XX LOCATED INSIDE MECHANICAL ROOM AT BASEMENT LEVEL TO THIS APPROXIMATE LOCATION TO BE PROVIDED AND INSTALLED UNDER PLUMBING CONTRACT. COORDINATE INSTALLATION OF PIPES WITH GENERAL/PLUMBING CONTRACTOR(S) PRIOR TO CONSTRUCTION.
- 1" COPPER PIPE STUB-OUTS FOR IRRIGATION FROM REMOTE CONTROL VALVE XX LOCATED INSIDE MECHANICAL ROOM AT BASEMENT LEVEL TO THIS APPROXIMATE LOCATION TO BE PROVIDED AND INSTALLED UNDER PLUMBING CONTRACT. COORDINATE INSTALLATION OF PIPES WITH GENERAL/PLUMBING CONTRACTOR(S) PRIOR TO CONSTRUCTION.
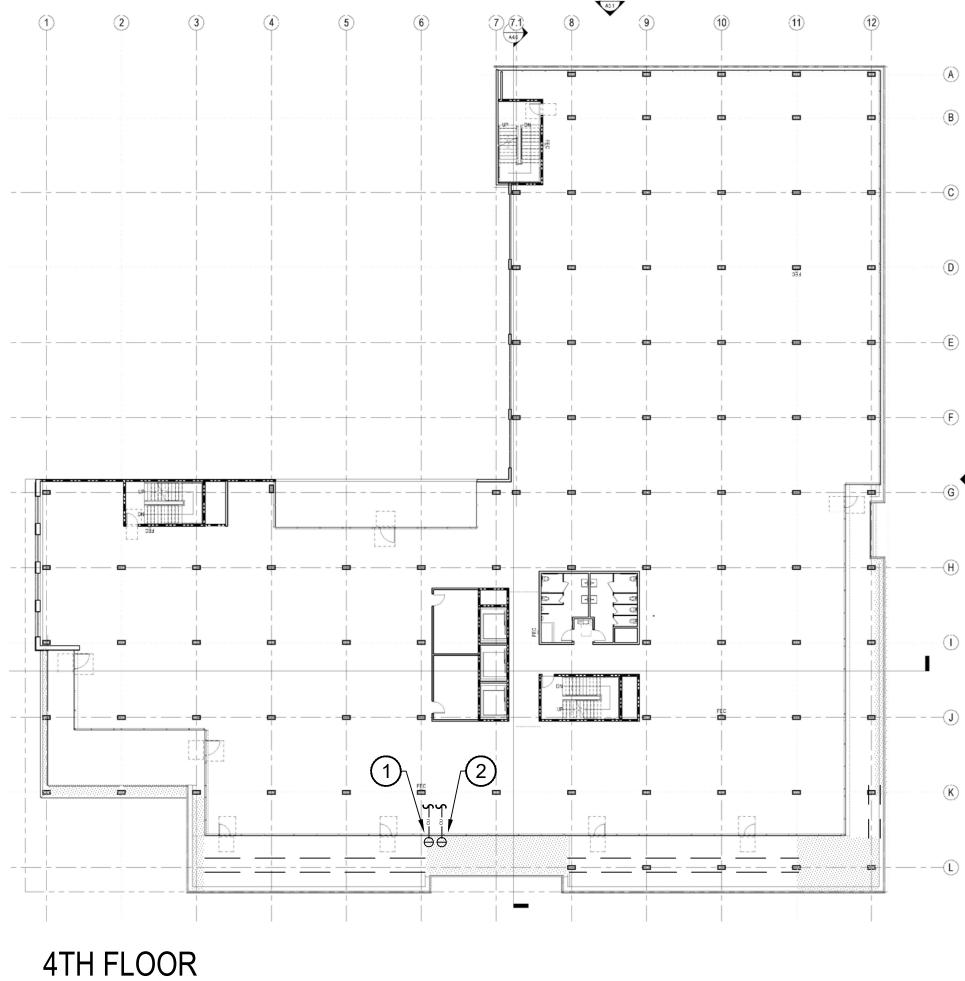
#### NOTES:


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- 3. UNSIZED LATERAL LINE PIPING LOCATED DOWN STREAM OF 1" PIPING SHALL BE 3/4" IN SIZE (TYPICAL).
- 4. SIZING OF LATERAL PIPE SHALL BE AS FOLLOWS:

0-6 GPM 7-12 GPM

13-20 GPM

5. SIZING OF LATERAL PIPE FOR DRIPLINE (12" O.C. GRID WITH 0.6 GPH OR LESS EMITTERS) SHALL BE AS FOLLOWS:

0-500 FT 501-1100 FT 1.25" 1101-2000 FT

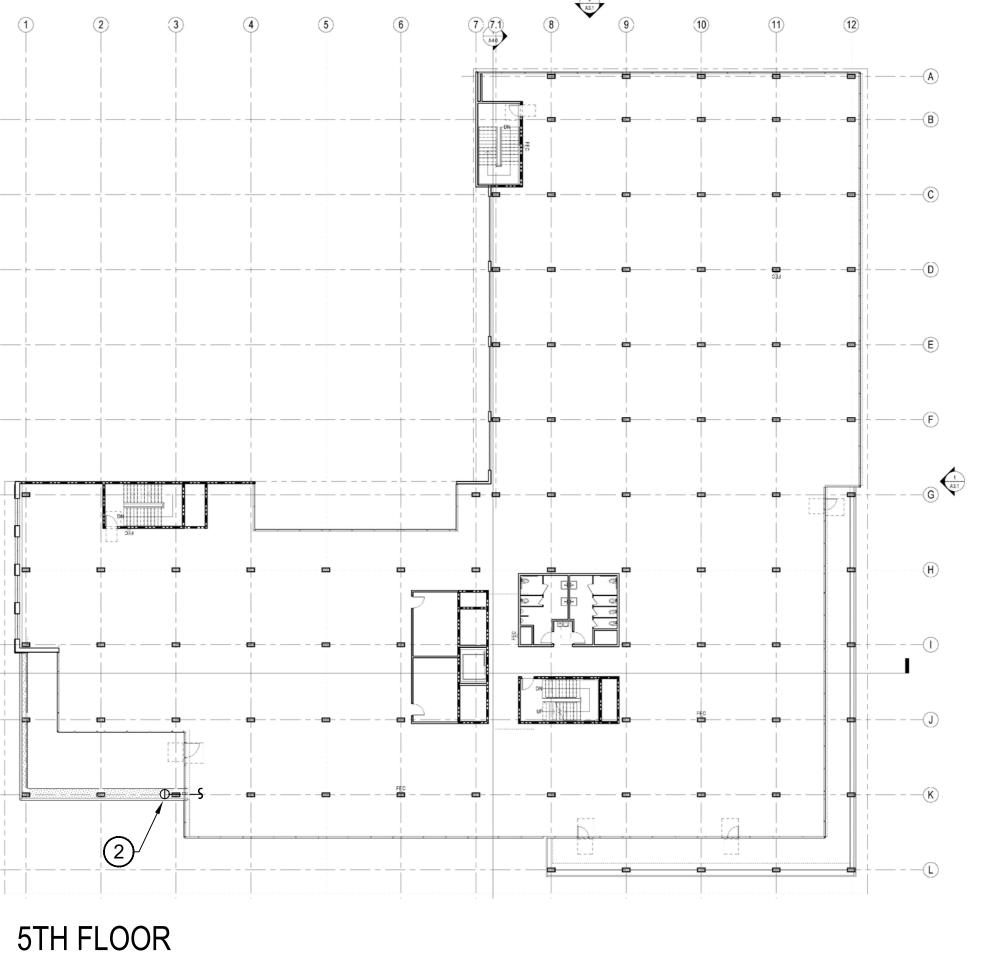

Irrigation Consultant: Russell D. Mitchell Associates, Inc. 2760 Camino Diablo Walnut Creek, CA 94597 

www.rmairrigation.com

160 Pine Street

415 781-9800 415 788-5216





() PROMETHEUS

2 PRE-APPLICATION RESUBMISSION

SCALE: PROJECT NUMBER: 2202017.00 DRAWN BY: CHECKED BY:

## NOT FOR CONSTRUCTION

SHEET NAME:
IRRIGATION PLAN-DIAGRAMS, 2ND, 3RD, 4TH & 5TH FLOORS

SHEET NUMBER:

STAMP:

#### **IRRIGATION NOTES**

- 1. THESE IRRIGATION DRAWINGS ARE DIAGRAMMATIC AND INDICATIVE OF THE WORK TO BE INSTALLED. ALL PIPING, VALVES, AND OTHER IRRIGATION COMPONENTS MAY BE SHOWN WITHIN PAVED AREAS FOR GRAPHIC CLARITY ONLY AND ARE TO BE INSTALLED WITHIN PLANTING AREAS. DUE TO THE SCALE OF THE DRAWINGS, IT IS NOT POSSIBLE TO INDICATE ALL OFFSETS. FITTINGS, SLEEVES, CONDUIT, AND OTHER ITEMS WHICH MAY BE REQUIRED. INVESTIGATE THE STRUCTURAL AND FINISHED CONDITION AFFECTING THE CONTRACT WORK INCLUDING OBSTRUCTIONS, GRADE DIFFERENCES OR AREA DIMENSIONAL DIFFERENCES. IN THE EVENT OF FIELD DISCREPANCY WITH CONTRACT DOCUMENTS, PLAN THE INSTALLATION WORK ACCORDINGLY BY NOTIFICATION AND APPROVAL OF THE OWNER'S AUTHORIZED REPRESENTATIVE AND ACCORDING TO THE CONTRACT SPECIFICATIONS. NOTIFY AND COORDINATE IRRIGATION CONTRACT WORK WITH APPLICABLE CONTRACTORS FOR THE LOCATION AND INSTALLATION OF PIPE, CONDUIT OR SLEEVES THROUGH OR UNDER WALLS, ROADWAYS, PAVING AND STRUCTURES BEFORE CONSTRUCTION. IN THE EVENT THESE NOTIFICATIONS ARE NOT PERFORMED, THE CONTRACTOR ASSUMES FULL RESPONSIBILITY FOR REQUIRED REVISIONS.
- 2. THE CONTRACTOR SHALL COMPLY WITH ALL APPLICABLE CODES, STANDARDS, AND REGULATIONS. ALL WORK AND MATERIALS SHALL BE IN FULL ACCORDANCE WITH THE LATEST RULES AND REGULATIONS OF THE NATIONAL ELECTRIC CODE; THE UNIFORM PLUMBING CODE, PUBLISHED BY THE WESTERN PLUMBING OFFICIALS ASSOCIATION; AND OTHER STATE OR LOCAL LAWS OR REGULATIONS. NOTHING IN THESE DRAWINGS IS TO BE CONSTRUED TO PERMIT WORK NOT CONFORMING TO THESE CODES OR REGULATIONS. THE CONTRACTOR SHALL FURNISH WITHOUT ANY EXTRA CHARGE, ANY ADDITIONAL MATERIAL AND LABOR WHEN REQUIRED BY THE COMPLIANCE WITH THESE CODES AND REGULATIONS.
- 3. THE CONTRACTOR SHALL COORDINATE INSTALLATION OF IRRIGATION SYSTEM WITH LAYOUT AND INSTALLATION OF THE PLANT MATERIALS TO INSURE THAT THERE WILL BE COMPLETE AND UNIFORM IRRIGATION COVERAGE OF PLANTING IN ACCORDANCE WITH THESE DRAWINGS, AND CONTRACT DOCUMENTS. THE IRRIGATION LAYOUT SHALL BE CHECKED BY THE CONTRACTOR AND OWNER'S AUTHORIZED REPRESENTATIVE PRIOR TO CONSTRUCTION TO DETERMINE IF ANY CHANGES, DELETIONS, OR ADDITIONS ARE REQUIRED. IRRIGATION SYSTEM SHALL BE INSTALLED AND TESTED PRIOR TO INSTALLATION OF PLANT MATERIAL.
- 4. THE INTENT OF THIS IRRIGATION SYSTEM IS TO PROVIDE THE MINIMUM AMOUNT OF WATER REQUIRED TO SUSTAIN GOOD PLANT HEALTH.
- 5. IT IS THE RESPONSIBILITY OF THE MAINTENANCE CONTRACTOR AND/OR OWNER TO PROGRAM THE IRRIGATION CONTROLLER(S) TO PROVIDE THE MINIMUM AMOUNT OF WATER NEEDED TO SUSTAIN GOOD PLANT HEALTH. THIS INCLUDES MAKING ADJUSTMENTS TO THE PROGRAM FOR SEASONAL WEATHER CHANGES, PLANT MATERIAL, WATER REQUIREMENTS, MOUNDS, SLOPES, SUN, SHADE AND WIND EXPOSURE.
- 6. IT IS THE RESPONSIBILITY OF A LICENSED ELECTRICAL CONTRACTOR TO PROVIDE 120 VOLT A.C. (2.5 AMP DEMAND PER CONTROLLER) ELECTRICAL SERVICE TO THE CONTROLLER LOCATION(S). IT IS THE RESPONSIBILITY OF THE IRRIGATION CONTRACTOR TO COORDINATE THE ELECTRICAL SERVICE STUB-OUT TO THE CONTROLLER(S). PROVIDE PROPER GROUNDING PER CONTROLLER MANUFACTURER'S INSTRUCTIONS AND IN ACCORDANCE WITH LOCAL CODES.
- 7. INSTALL NEW BATTERIES IN THE IRRIGATION CONTROLLER(S) TO RETAIN PROGRAM IN MEMORY DURING TEMPORARY POWER FAILURES. USE QUANTITY, TYPE AND SIZE REQUIRED AS PER CONTROLLER MANUFACTURER'S INSTRUCTIONS.
- 8. SCHEDULE A MEETING WHICH INCLUDES REPRESENTATIVES OF THE IRRIGATION CONTROLLER MANUFACTURER, THE MAINTENANCE CONTRACTOR, THE OWNER AND THE IRRIGATION CONTRACTOR AT THE SITE FOR INSTRUCTION ON THE PROPER PROGRAMMING AND OPERATION OF THE IRRIGATION CONTROLLER.
- 9. INSTALL 3" DETECTABLE TAPE ABOVE ALL PRESSURIZED MAIN LINES AS DETAILED. USE CHRISTY MODEL #TA-DT-3-BIRR FOR POTABLE IRRIGATION SYSTEMS.
- 10. INSTALL 2-WIRE CABLE ALONG THE MAIN LINE. CONTACT CONTROLLER REPRESENTATIVE FOR A PRE-CONSTRUCTION MEETING.
- 11. INSTALL 2-WIRE CABLE WITHIN 1.25" CONDUIT WITH LONG SWEEPS IN AND OUT OF EACH VALVE BOX. SEAL ALL CONDUIT OPENINGS WITH WATERPROOF FOAM.
- 12. INSTALL A 14"X19" GREY ELECTRICAL PULL BOX EVERY 200' AND AT EVERY CHANGE IN DIRECTION. ONLY SPLICE TWO WIRE CABLE AT THREE WAY WIRE CONNECTIONS.
- 13. IRRIGATION CONTROL WIRES: SOLID COPPER WITH U.L. APPROVAL FOR DIRECT BURIAL IN GROUND. SIZE #14AWG WIRE WITH A JACKETED 2-CONDUCTOR. PREFERRED WIRE MAKE AND MODEL IS TW-CAB-14. ALL SPLICING SHALL BE MADE WITH 3-M DBR/Y-6 WATERPROOF SPLICE KIT.
- 14. DECODER GROUNDING SHALL BE PROVIDED EVERY 600 FEET, AT THE CONTROLLER AND AT THE LAST DECODER OR AT THE END OF THE 2 WIRE PATH. GROUND WITH A 5/8" X 8' COPPER CLAD GROUNDING ROD. #6 COPPER WIRE TO SURGE DEVICE/DECODER. INCLUDE A SURGE ARRESTOR AT EACH GROUNDING LOCATION. A SPLIT BOLT CONNECTION TO BE USED TO CONNECT THE SURGE DEVICE TO THE GROUND WIRE WITH A DBR/Y-6 WATERPROOF CONNECTOR.
- 15. SPLICING OF JACKETED 2-WIRE IS PERMITTED IN VALVE BOXES ONLY. LEAVE A 24" LONG COIL OF WIRE AT EACH SPLICE AND A 24" LONG EXPANSION LOOP IN ALL PULL BOXES.
- 16. INSTALL BLACK PLASTIC VALVE BOXES WITH BOLT DOWN, NON HINGED COVER MARKED "IRRIGATION CONTROL VALVE". BOX BODY SHALL HAVE KNOCK OUTS. ACCEPTABLE VALVE BOX MANUFACTURER'S INCLUDE NDS, CARSON OR APPROVED EQUAL.

- 17. INSTALL REMOTE CONTROL VALVE BOXES 12" FROM WALK, CURB, BUILDING OR LANDSCAPE FEATURE. AT MULTIPLE VALVE BOX GROUPS, INSTALL EACH BOX AN EQUAL DISTANCE FROM THE WALK, CURB, BUILDING OR LANDSCAPE FEATURE AND PROVIDE 12" BETWEEN BOX TOPS. ALIGN THE SHORT SIDE OF RECTANGULAR VALVE BOXES PARALLEL TO WALK, CURB, BUILDING OR LANDSCAPE FEATURE.
- 18. VALVE LOCATIONS SHOWN ARE DIAGRAMMATIC. INSTALL IN GROUND COVER/SHRUB AREAS (AVOID LAWN AREAS WHERE POSSIBLE).
- 19. THE CONTRACTOR SHALL LABEL CONTROL LINE WIRE AT EACH REMOTE CONTROL VALVE WITH A 2 1/4" X 2 3/4" POLYURETHANE I.D. TAG, INDICATING IDENTIFICATION NUMBER OF VALVE (CONTROLLER AND STATION NUMBER). ATTACH LABEL TO CONTROL WIRE. THE CONTRACTOR SHALL PERMANENTLY STAMP ALL VALVE BOX LIDS WITH APPROPRIATE IDENTIFICATION AS NOTED IN CONSTRUCTION DETAILS.
- 20. FLUSH AND ADJUST IRRIGATION OUTLETS AND NOZZLES FOR OPTIMUM PERFORMANCE AND TO PREVENT OVER SPRAY ONTO WALKS, ROADWAYS, AND/OR BUILDINGS. SELECT THE BEST DEGREE OF THE ARC AND RADIUS TO FIT THE EXISTING SITE CONDITIONS AND THROTTLE THE FLOW CONTROL AT EACH VALVE TO OBTAIN THE OPTIMUM OPERATING PRESSURE FOR EACH CONTROL ZONE.
- 21. SET SPRINKLER HEADS PERPENDICULAR TO FINISH GRADE.
- 22. LOCATE BUBBLERS ON UPHILL SIDE OF PLANT OR TREE.
- 23. INSTALL A HUNTER HCV SERIES, KBI CV SERIES, OR APPROVED EQUAL SPRING LOADED CHECK VALVE IN SPRINKLER RISER ASSEMBLIES WHERE LOW OUTLET DRAINAGE WILL CAUSE EROSION AND/OR EXCESS WATER.
- 24. WHERE IT IS NECESSARY TO EXCAVATE ADJACENT TO EXISTING TREES, USE CAUTION TO AVOID INJURY TO TREES AND TREE ROOTS. EXCAVATE BY HAND IN AREAS WHERE TWO (2) INCH AND LARGER ROOTS OCCUR. BACK FILL TRENCHES ADJACENT TO TREE WITHIN TWENTY-FOUR (24) HOURS. WHERE THIS IS NOT POSSIBLE, SHADE THE SIDE OF THE TRENCH ADJACENT TO THE TREE WITH WET BURLAP OR CANVAS.
- 25. NOTIFY LOCAL JURISDICTIONS FOR INSPECTION AND TESTING OF INSTALLED BACKFLOW PREVENTION DEVICE.
- 26. THE IRRIGATION SYSTEM DESIGN IS BASED ON THE MINIMUM OPERATING PRESSURE SHOWN ON THE IRRIGATION DRAWINGS. VERIFY WATER PRESSURE PRIOR TO CONSTRUCTION. REPORT ANY DIFFERENCE BETWEEN THE WATER PRESSURE INDICATED ON THE DRAWINGS AND THE ACTUAL PRESSURE READING AT THE IRRIGATION POINT OF CONNECTION TO THE OWNER'S AUTHORIZED REPRESENTATIVE.

#### 27. IRRIGATION DEMAND: REFER TO PLANS.

- 28. THE EXISTING MAIN LINE SHOWN ON THE DRAWINGS IS
  DIAGRAMMATIC. VERIFY AND LOCATE EXISTING MAIN LINE IN FIELD.
  REPORT TO ARCHITECT IN WRITING ANY DEVIATION OF EXISTING
  MAIN LINE LOCATION FROM THAT SHOWN ON THE DRAWINGS.
- 29. PIPE SIZING SHOWN ON THE DRAWINGS IS TYPICAL. AS CHANGES IN LAYOUT OCCUR DURING STAKING AND CONSTRUCTION THE SIZE MAY NEED TO BE ADJUSTED ACCORDINGLY.
- 30. PIPE THREAD SEALANT COMPOUND SHALL BE RECTOR SEAL #5.
- CHANGES IN THE IRRIGATION LAYOUT DUE TO OBSTRUCTIONS NOT SHOWN ON THE IRRIGATION DRAWINGS SUCH AS LIGHTS, FIRE HYDRANTS, SIGNS, ELECTRICAL ENCLOSURES, ETC.

31. THE LANDSCAPE CONTRACTOR SHALL BE RESPONSIBLE FOR MINOR

- 32. THE LANDSCAPE CONTRACTOR SHALL BE RESPONSIBLE FOR CHANGES IN THE IRRIGATION LAYOUT AND VALVE ZONING DUE TO VARIATIONS IN THE EXISTING SITE CONDITIONS SUCH AS EXPOSURE FROM BUILDINGS, TRELLISES, TREES, ETC., AS WELL AS SLOPE AND SOIL CONDITIONS. THE CONTRACTOR SHALL NOTIFY THE LANDSCAPE ARCHITECT AND IRRIGATION CONSULTANT OF THE PROPOSED CHANGES PRIOR TO INSTALLATION FOR APPROVAL.
- 33. THE LANDSCAPE CONTRACTOR IS RESPONSIBLE FOR ADJUSTING THE IRRIGATION SYSTEM DESIGN IF THE PLANTING DESIGN CHANGES FROM THE ORIGINAL PLAN AND NEEDS TO ADAPT TO THE NEW PLANTING DESIGN. THE LANDSCAPE CONTRACTOR NEEDS TO NOTIFY THE LANDSCAPE ARCHITECT AND IRRIGATION CONSULTANT OF PROPOSED CHANGES PRIOR TO INSTALLATION FOR APPROVAL.
- 34. WHEN WORK OF THIS SECTION HAS BEEN COMPLETED AND SUCH OTHER TIMES AS MAY BE DIRECTED, REMOVE ALL TRASH, DEBRIS, SURPLUS MATERIALS AND EQUIPMENT FROM SITE.
- 35. CONTRACTOR SHALL BE RESPONSIBLE FOR SUPPLEMENTAL HAND WATERING OF ALL PLANT MATERIAL WITHIN DRIPLINE AREAS UNTIL THE PLANTS ARE SUFFICIENTLY ESTABLISHED.
- 36. VERIFY LOCATIONS OF ALL IRRIGATION COMPONENTS INSTALLED WITHIN A VALVE BOX WITH LANDSCAPE ARCHITECT PRIOR TO INSTALLATION. DO NOT INSTALL UNTIL LANDSCAPE ARCHITECT PROVIDES ACCEPTABLE LOCATIONS.

#### IRRIGATION COORDINATION NOTES

- 1. PLUMBING CONTRACTOR SHALL PROVIDE AND INSTALL ALL PIPING WITHIN THE STRUCTURE. PIPE MATERIAL SHALL BE APPROVED FOR USE WITHIN A STRUCTURE PER PLUMBING CODE. REFER TO MEP OR PLUMBING DRAWING FOR EXACT ROUTING THOUGH THE STRUCTURE. REFER TO IRRIGATION PLANS FOR APPROXIMATE LOCATION OF STUB OUT LOCATIONS. EXIT OF PIPE TO BE WITHIN PLANTERS WHERE POSSIBLE. ALL PENETRATION POINTS SHALL BE WATERPROOFED AS REQUIRED.
- 2. IRRIGATION SLEEVES OR CONDUITS WITHIN PRECAST OR POURED IN PLACE PLANTERS SHALL BE COORDINATED AND INSTALLED PRIOR TO THE CONSTRUCTION. ALL PENETRATION POINTS SHALL BE WATERPROOFED AS REQUIRED.
- 3. ELECTRICAL CONTRACTOR SHALL PROVIDE CONDUIT, PULL BOXES AND WIRE IN STRUCTURE. THE DRAWINGS INDICATE REQUIRED CONDUIT SIZE AND TYPE OF LOW VOLTAGE CABLE. FINAL CONNECTION OR WIRING TO REMOTE CONTROL VALVES AND CONTROLLER SHALL BE COMPLETED BY IRRIGATION CONTRACTOR.

#### IRRIGATION WATER USE CALCULATIONS

		_	h and Ra									
WATER TYPE	POTABLE											
SITE ETO=	42.7											
REGULAR LANDSCAPE	AREAS											
HYDROZONE #	HYDROZONE NAME	PLANT WATER USE TYPE	PLANT FACTOR (PF)	IRRIGATION METHOD	IRRIGATION EFFICIENCY	ETAF (PF/IE)	AREA (SQ. FT (HA)	ETAF X AREA (HA)	ETWU (GAL/YR)	ACRE FEET/ YEAR	HCF/ YEAR	PERCENTAGE C LANDSCAPE
1	SHRUBS/GC	LOW	0.2	DRIP	0.81	0.247	575	142	3,759	0.01	5.02	14%
2	RAISED PLANTERS STREET	LOW	0.2	DRIP	0.81	0.247	181	45	1,183	0.00	1.58	4%
3	RAISED PLANTERS LEVELS	MOD	0.5	DRIP	0.81	0.617	450	278	7,354	0.02	9.83	11%
4	BIORETENTION	LOW	0.2	DRIP	0.81	0.247	1,223	302	7,994	0.02	10.69	30%
5	TREES	MOD	0.5	BUBBLER	0.81	0.617	1,680	1,037	27,455	0.08	36.70	41%
			0.0	DODDELIK		TOTALS	4,109	1,803	47,745	0.15	63.83	100%
					-							
SPECIAL LANDSCAPE	AREAS	_										
HYDROZONE #	HYDROZONE NAME											
						1						0%
						TOTALS	0					0%
	GALLONS/Y		48,952 MANYA FORMULA			I FORMUL A						
MAWA	ACRE FEET/	YK	0.15			J FORMULA						
	HCF/YR		65.44	MAXIMUM APPLIED WATER ALLOWANCE (MAWA)  GALLONS PER YEAR  ESTIMATED TOTAL WATER USE (ETWU)  YEAR			O) GALLONS FE					
					MAWA = (E	To)(0.62)[(LA x 0.45	) + (0.55 x SLA)]			ETWU= ((ET	O)(.62)(ETAF	x LA))
	GALLONS/Y	R	47,745		ETo = REFER	ENCE EVAPOTRAN	ISPIRATION		ETo = REF	ERENCE EVA	POTRANSPI	RATION
ETWU	ACRE FEET/	YR	0.15		0.55= ET ADJU	USTMENT FACTOR			PF = PLAN	T FACTOR FO	OR HYDROZO	ONES
	HCF/YR		63.83		LA=LANDSCA	PED AREA (SQUAF	RE FEET)		HA = HYDR	OZONE ARE	A (SQ.FT)	
					0.62 = CONVE	RSION FACTOR (G	ALLONS/SQ.FT/Y	(R)	0.62 = CON	WERSION FA	CTOR (GALL	ONS/SQ.FT/YR
SITE IRRIGATION EFFICIENCY	SITE PLANT FACTOR	MAWA COMPLIANT										BUBBLER/DRIP
68.6%	0.29	YES							IE = IRRIGA	ATION EFFICIE	ENCY (0.75)-F	ROTORS/SPRA
ETAF	Calculations											
REGULAR LANDSC												
TOTAL ETAF x AREA												
TOTAL AREA	4,109											
AVG. ETAF	43.89%											

#### IRRIGATION DESIGN NARRATIVE

THE PROPOSED IRRIGATION SYSTEM FOR THIS SITE WILL BE DESIGNED WITH THE LATEST TECHNOLOGY IN WATER CONSERVATION AND EFFICIENCY. THE SYSTEM WILL CONSIST OF THE FOLLOWING TYPES OF IRRIGATION METHODS AND EQUIPMENT COMPLYING WITH THE STATE WATER ORDINANCE. ALL SMALL PLANTING BEDS WILL BE IRRIGATED WITH WATER CONSERVING AND HIGHLY EFFICIENT INLINE DRIP. ALL BIORETENTION WILL BE IRRIGATED WITH INLINE DRIP SPACED AT 12" O.C. SINCE BIORETENTION AREAS ARE LESS THAN 10 FT WIDE. THE CONTROLLER THAT WILL MANAGE THIS SYSTEM USES LOCAL WEATHER TO ADJUST THE RUN TIMES OF THE VALVES BASED ON DAILY WEATHER CONDITIONS. UTILIZING THIS TYPE OF WEATHER-BASED SYSTEM WILL HELP THE LANDSCAPE MANAGER SAVE 25% MORE WATER THAN WITH A CONVENTIONAL CONTROLLER.

#### IRRIGATION ZONES

- 1. LOW AND MODERATE WATER-USE SHRUBS/GROUNDCOVER/FLOWERING PLANTS: TO BE IRRIGATED WITH INLINE DRIP
- 2. LARGE SHRUBS AND TREES: TO BE IRRIGATED USING POINT SOURCE BUBBLERS.

  3. STORMWATER TREATMENT: TO BE IRRIGATED WITH INLINE DRIP SPACED AT 12" O.C.

## I HAVE COMPLIED WITH THE CRITERIA OF THE WATER CONSERVATION IN LANDSCAPING ORDINANCE AND APPLIED THEM FOR THE EFFICIENT USE OF

WATER IN THE LANDSCAPE AND IRRIGATION DESIGN PLANS.

#### IRRIGATION LEGEND

SYMBOL	MODEL NUMBER	DESCRIPTION		NOZZLE GPM	OPERATING PSI	OPERATING RADIUS (FEET)
$\bigcirc$	570Z-12P-XF-COM/ MP1000-360-HT	TORO POP-UP S SPRINKLER WITH	H MP	0.75	40	12-14
		ROTATOR NOZZ (GRASSES)				
$\bigvee  \nabla$	570Z-12P-XF-COM/ MP1000-90-HT	TORO POP-UP S SPRINKLER WITH ROTATOR NOZZ (GRASSES)	H MP	0.37,0.19	40	12-14
•	570Z-12P-PRX-COM/ MP1000-360-HT	TORO POP-UP S SPRINKLER WITH MP ROTATOR N (GRASSES)	H HUNTER	0.65	30	10-12
▼	570Z-12P-PRX-COM/ MP1000-90-HT	TORO POP-UP S SPRINKLER WITH MP ROTATOR N (GRASSES)	H HUNTER	0.32,0.16	30	10-12
<b>(</b>	DB-15-PC-CV	TORO BUBBLER,	1 PER	0.25	30	TRICKLE
•	DB-15-PC-CV	SHRUB TORO BUBBLER, TREE. REFER TO DETAIL FOR QUA BUBBLERS PER T	BUBBLER ANTITY OF	0.25	30	TRICKLE
<b>●►</b> <b>●</b> +	T-YD-500-34 WLT-0500-T	TORO DRIPLINE NDS SCH 40 BA			, ,	
	570-DRIP-IND	TORO POP-UP I				
•	P-220-26 SERIES	TORO REMOTE	CONTROL VA	LVE		
•	DZK-700-MF	TORO DRIP ZON VALVE, PRESSUR				E CONTROL
+=	220-27-04/	TORO BRASS RE	MOTE CONTR	OL VALVE W		REGULATOR
CV	T-ALFS10150-S KC OR KSC	(40 PSI) AND A			FLOW DIRECT	TION OR KC
(CV)	NC OK NOC	SERIES SPRING (				
H	T113-K SERIES	NIBCO BRASS G	· ·	•	N. C. S. C. C.	-11000
•	33-DRC	RAIN BIRD 3/4" LOCKING RUBBI		UICK COUPLI	NG VALVE (YI	ELLOW
$\bowtie$	T-FP600A-LF-1"	NIBCO 1" BRASS	S BALL VALVE			
	975XL2SEU-1"	WILKINS REDUC	ED PRESSURE	BACKFLOW A	ASSEMBLY WIT	TH FREEZE
(MV) (FS)	3100100	SUPERIOR MAST	ER VALVE-1" (	NORMALLY C	OPEN)	
	QS200-10	FLOMEC 1" PVC			:	<b></b> /
(C)	EGP-TW-S/ EGP-ICENTRAL	RAIN MASTER I-0	CLUDES I-CARI CENTRAL SERV	D, CELL COM/ ICE.	MUNICATION I	Steel Pedestal Kit and five Year:
_	TW-D-1	RAIN MASTER SI		•	•	PETHAN 1 OR
		MORE VALVES A	ARE CLUSTERED	) TOGETHER)		
_	TW-LA-1	RAIN MASTER LIG REFER TO DETAIL		•		ALONG MAIN)
R	NOT SHOWN ON PLANS	SIZE #14AWG Y MAKE AND MOI DBR/Y-6 WATER CABLE WITHIN 1	WIRE WITH A DEL IS TW-CAI RPROOF SPLIC 1.25" SCH 40 I 7 200' NO SPL INSTALLATION	JACKETED 2-0 B-14. ALL SPLI E KITS OR AP ELECTRICAL C ICES ARE ALLO I INSTRUCTIO	CONDUCTOR. ICING SHALL E PROVED EQUA ONDUIT. PULL OWED BETWE	CONTROL VALVES. PREFERRED WIRE BE MADE WITH 3-M AL. INSTALL 2 WIRE BOXES SHALL BE EN VALVES. REFER
	KO-1000	CONTROLLER A				
	/	REMOTE CONTR				
• •	•	FLOW (GPM)				
• •	<u> </u>	WATER USE CLA			A C	
		APPLICATION RA	AIE (IN/HR) or	DKIPLINE SPA	ACING	
r <b>9</b>		AREA (SQ. FT.) ASSOCIATED RE	MOTE CONTE	OI VAIVE		
	CU CU	MAIN LINE:	MOTE CONTR 1.5" AND S/			
			TYPE 'K' CO SHOWN FO FOR ROUTIN	PPER PIPE WI OR REFERENCE NG THROUGH	TH WROUGH ONLY, SEE PL STRUCTURE.	T FITTINGS. .UMBING PLANS
<del></del> ,		MAIN LINE:		DULE 40 PVC 40 PVC SOLV	PLASTIC PIPE 'ENT WELD FIT'	
		LATERAL LINE:		DULE 40 PVC 40 PVC SOLV	PLASTIC PIPE 'ENT WELD FIT	
		DRIPLINE LATERAL LINE:		DULE 40 PVC 40 PVC SOLV	PLASTIC PIPE '	
==	======	SLEEVING:	SCHEDULE 4	40 PVC PLAST	TIC PIPE. COVE TIONS OR AS I	
.CON	CONCON	ELECTRICAL CONDUIT:			ONLY, SEE EL	ECTRICAL PLANS
STATION	\# <b>₽</b> <	— DRIPLINE REMOT			J. J	
PVC LAT		— DRIP ZONE: TORO DL2000 S			00 INSERT FITT	INGS, PART
IXX		#RGP-212. TUB	ING TO BE INS	STALLED 4" BE	LOW GRADE	IN A 12" O.C.
SUPPLY		1": 0-10 GPM, 1	.25": 11-20 G	PM. ALL EXH	AUST HEADERS	S SHALL BE 1"
HEADER	HEADEK—	SCH 40 PVC OR WELD FITTINGS	EXTEND PVC	HEADERS TO	THE ENDS OF	ALL DRIP
		ZONES TO BALA INFORMATION.	AINCE FLOW IF	KEQUIKED. S	EE DETAILS FO	rK FUKIHEK
COLOR HAT OF ZONE -	DRIP ZONE EXTENTS					
- STATION		— DRIPLINE REMO	TE CONTROL \	/ALVE		
PVC LATI	ERAL	— APPROXIMATE ( PVC SUPPLY WI				

PVC SUPPLY WHEN DRIP ZONE IS LESS THAN 3 GPM AND NO PVC SUPPLY/EXHUST HEADERS ARE NEEDED. REFER TO DRIPLINE TUBING

CONNECTION DETAIL FOR MORE INFORMATION.

DRIP ZONE

**EXTENTS** 

COLOR HATCH/

OF ZONE —



RMW 160 Pine Street
Architecture 4th Floor
Interiors San Francisco
California 94111

Office Fax
415 781-9800 415 788-5216



CLIENT:



PROMETHEUS

PROJECT NAME & ADDRESS:

**BESPOKE** 

401-445 S. B STREET SAN MATEO, CA 94401

SAN MATEO, CA 94401

ISSUE:
ISSUE DATE:

REVISIONS:

DESCRIPTION
PRE-APPLICATION
1/31/2022
PRE-APPLICATION RESUBMISSION
6/10/2022

SCALE:

PROJECT NUMBER: 2202017.00

DRAWN BY: TH

CHECKED BY: CB

STAMP:

## NOT FOR CONSTRUCTION

IRRIGATION NOTES
AND LEGEND

SHEET NUMBER:

L.3.2

## 4TH & RAILROAD - AFFORDABLE HOUSING PROJECT

### ARCHITECTURE 934 Howard Street San Francisco, CA P. (415) 677-0966

() PROMETHEUS

**4TH & RAILROAD** 

**4TH & RAILROAD** 

San Mateo, CA

Project Status

02/01/2023


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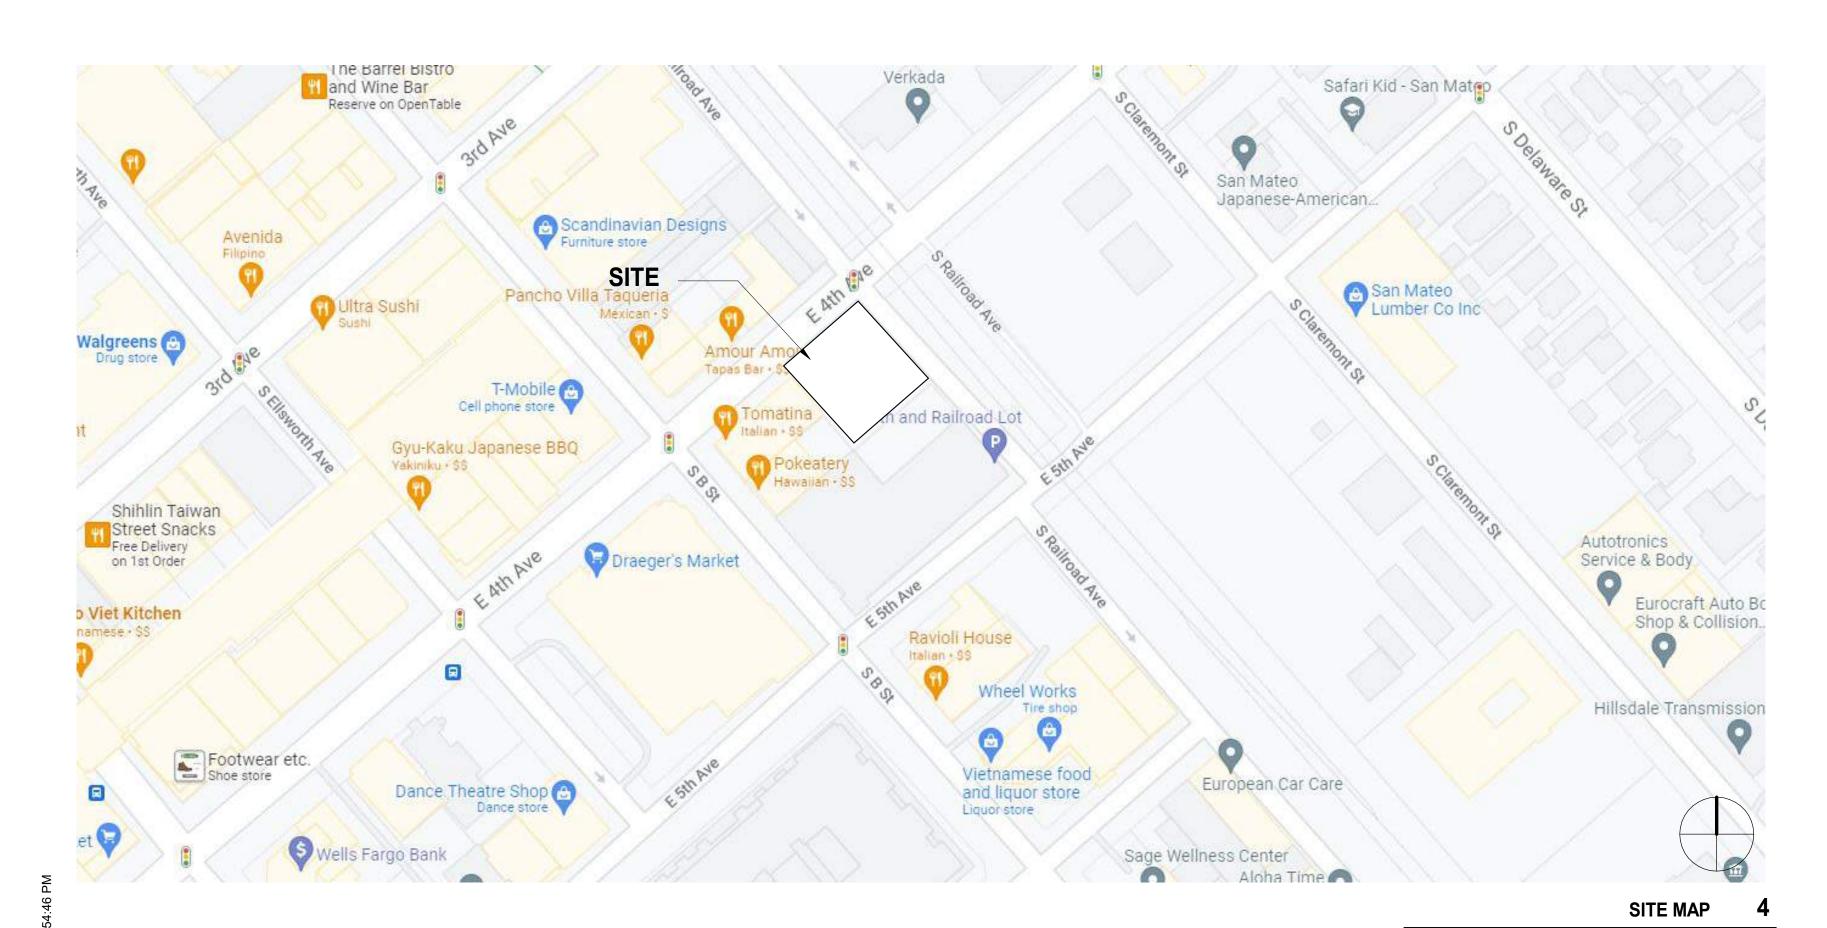
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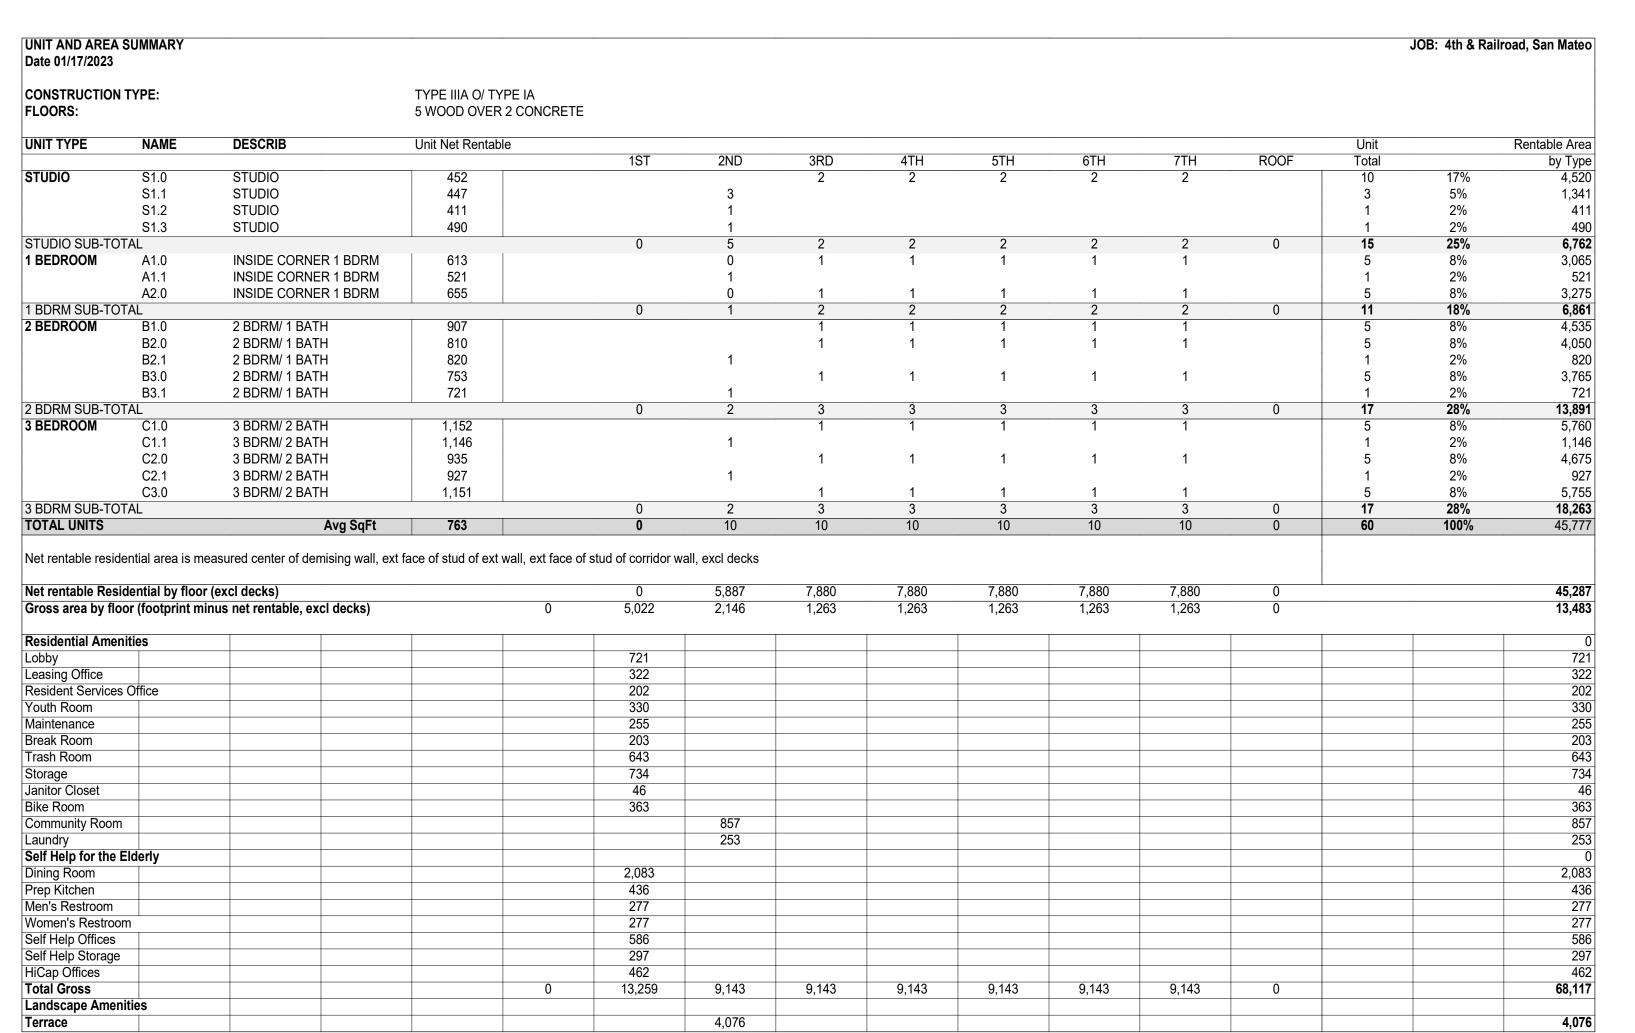
ISSUE DATE:

**REVISIONS:** 


## 4TH AVENUE & SOUTH RAILROAD AVENUE SAN MATEO, CA 94401





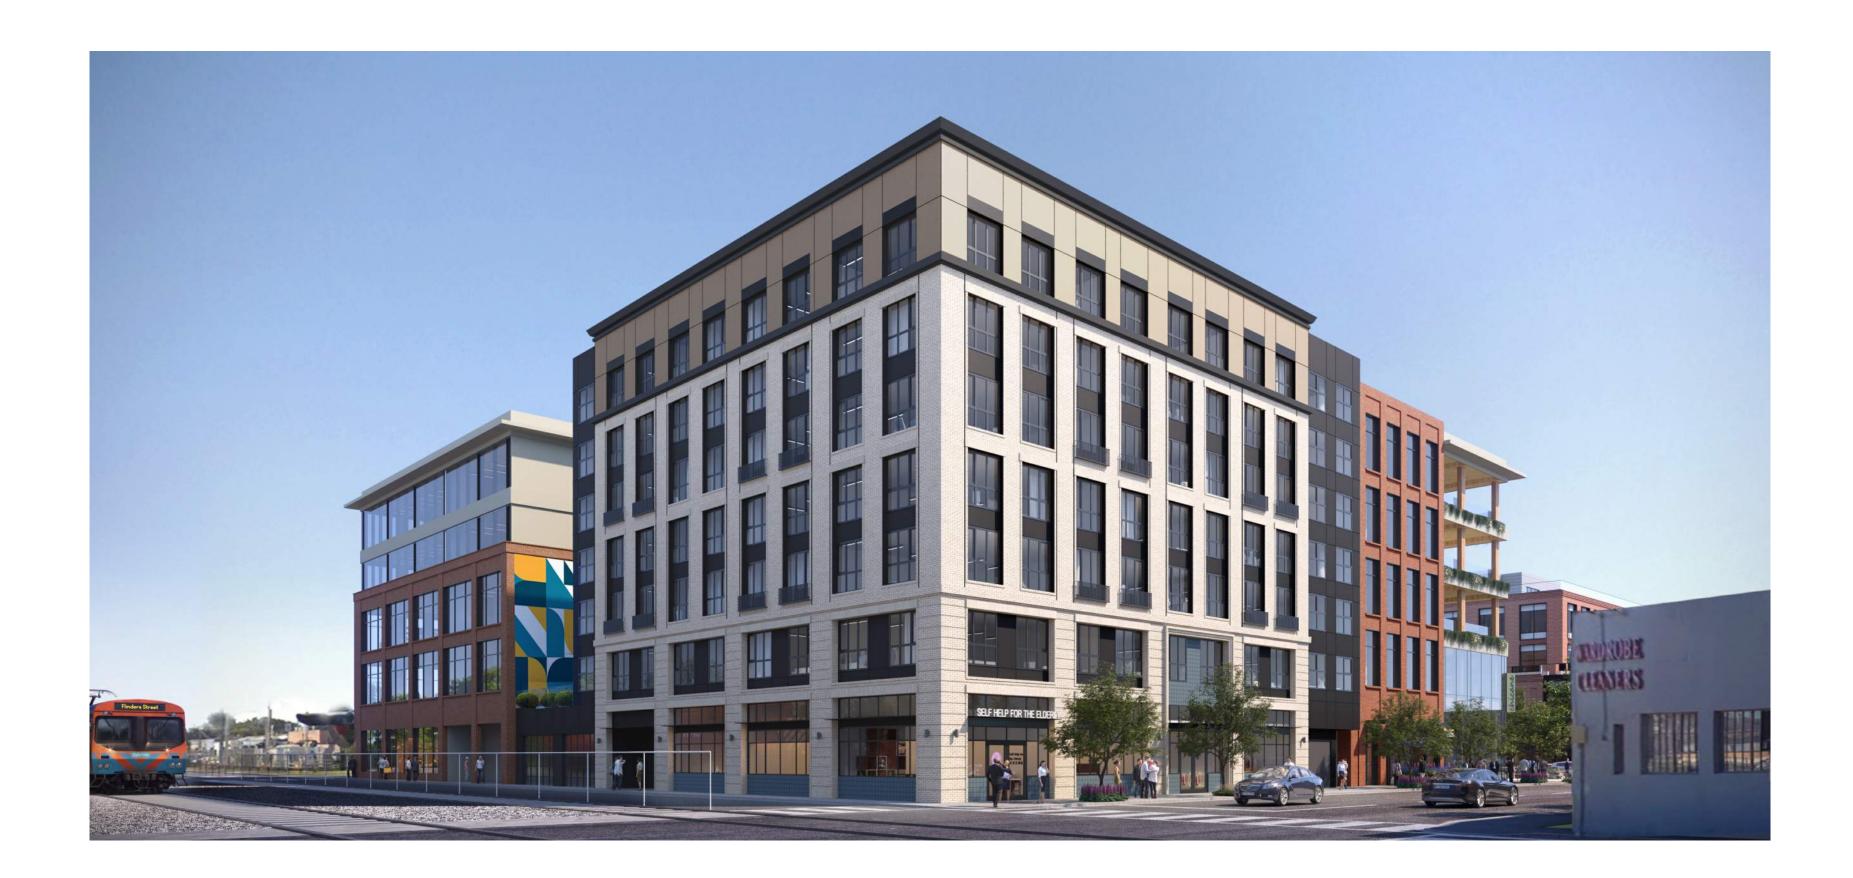

SHORT TERM			
STUDIOS05 PER UNIT	15 UNITS		1 SPACE
1 BEDROOM05 PER UNIT	11 UNITS		1 SPACE
2 BEDROOM10 PER UNIT	17 UNITS		2 SPACE
3 BEDROOM10 PER UNIT	17 UNITS		2 SPACES
		TOTAL:	6 SPACES
LONG TERM			
STUDIOS - 1 PER UNIT UNIT	15 UNITS		15 SPACE
1 BEDROOM - 1 PER UNIT	11 UNITS		11 SPACE
2 BEDROOM - 1.25 PER UNIT	17 UNITS		22 SPACE
3 BEDROOM - 1.5 PER UNIT	17 UNITS		26 SPACES

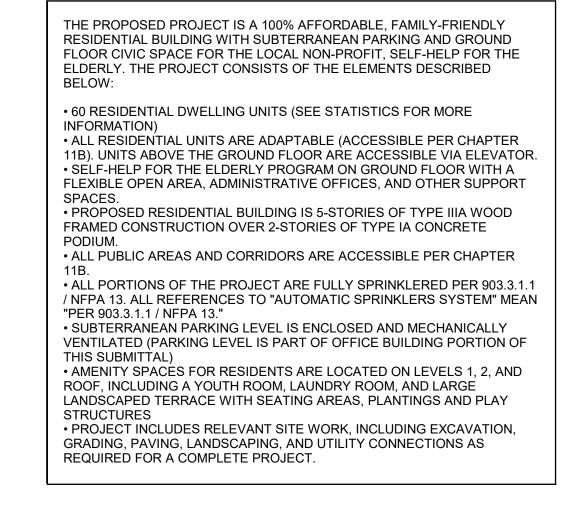

PROJECT DESCRIPTION

1" = 1'-0"

APPLICANT / OWNER: DTSM TALBOTS VENTURE, LLC 180 GRAND AVENUE, SUITE 1400 OAKLAND, CA 94612	LANDSCAPE ARCHITECT: PLACE 735 NW 18TH AVENUE PORTLAND, OR 97209	
CONTACT: PRESTON O'CONNELL (510) 466-1485	CONTACT: CHARLES BRUCKER (503) 334 - 2080	AR0.01 AR1.00 AR2.01
ARCHITECT: BDE ARCHITECTURE 934 HOWARD STREET SAN FRANCISCO, CA 94103	HOUSING: ALTA HOUSING 3460 W BAYSHORE RD SUITE 104 PALO ALTO, CA 94303	AR2.02 AR2.03 AR2.04 AR3.00 AR3.01
<u>CONTACT:</u> NATALIE SHOVLIN (330) 283 - 3662	CONTACT: JENNIFER WONG (650) 219 - 2687	AR3.02 AR3.10 AR3.20 AR3.21

**PROJECT TEAM** 

CONTACT: JENNIFER WONG (650) 219 - 2687	AR3.10 AR3.20 AR3.21	MATERIAL BOARD BUILDING SECTIONS STREET WALL SECTION EXHIBITS	

PROJECT INFORMATION

FLOOR 1

FLOOR 2

FLOORS 3-7

**ROOF PLAN** 

BLOCK ELEVATIONS


**BUILDING ELEVATIONS** PERSPECTIVE VIEWS

SHEET INDEX

PROJECT NUMBER: DRAWN BY: CHECKED BY: STAMP:	21
STAMP:	
STAMP	

SHEET NAME:	
PROJECT INFORMATION	

1" = 1'-0" **SHEET SIZE**: 30 x 42 SHEET NUMBER:

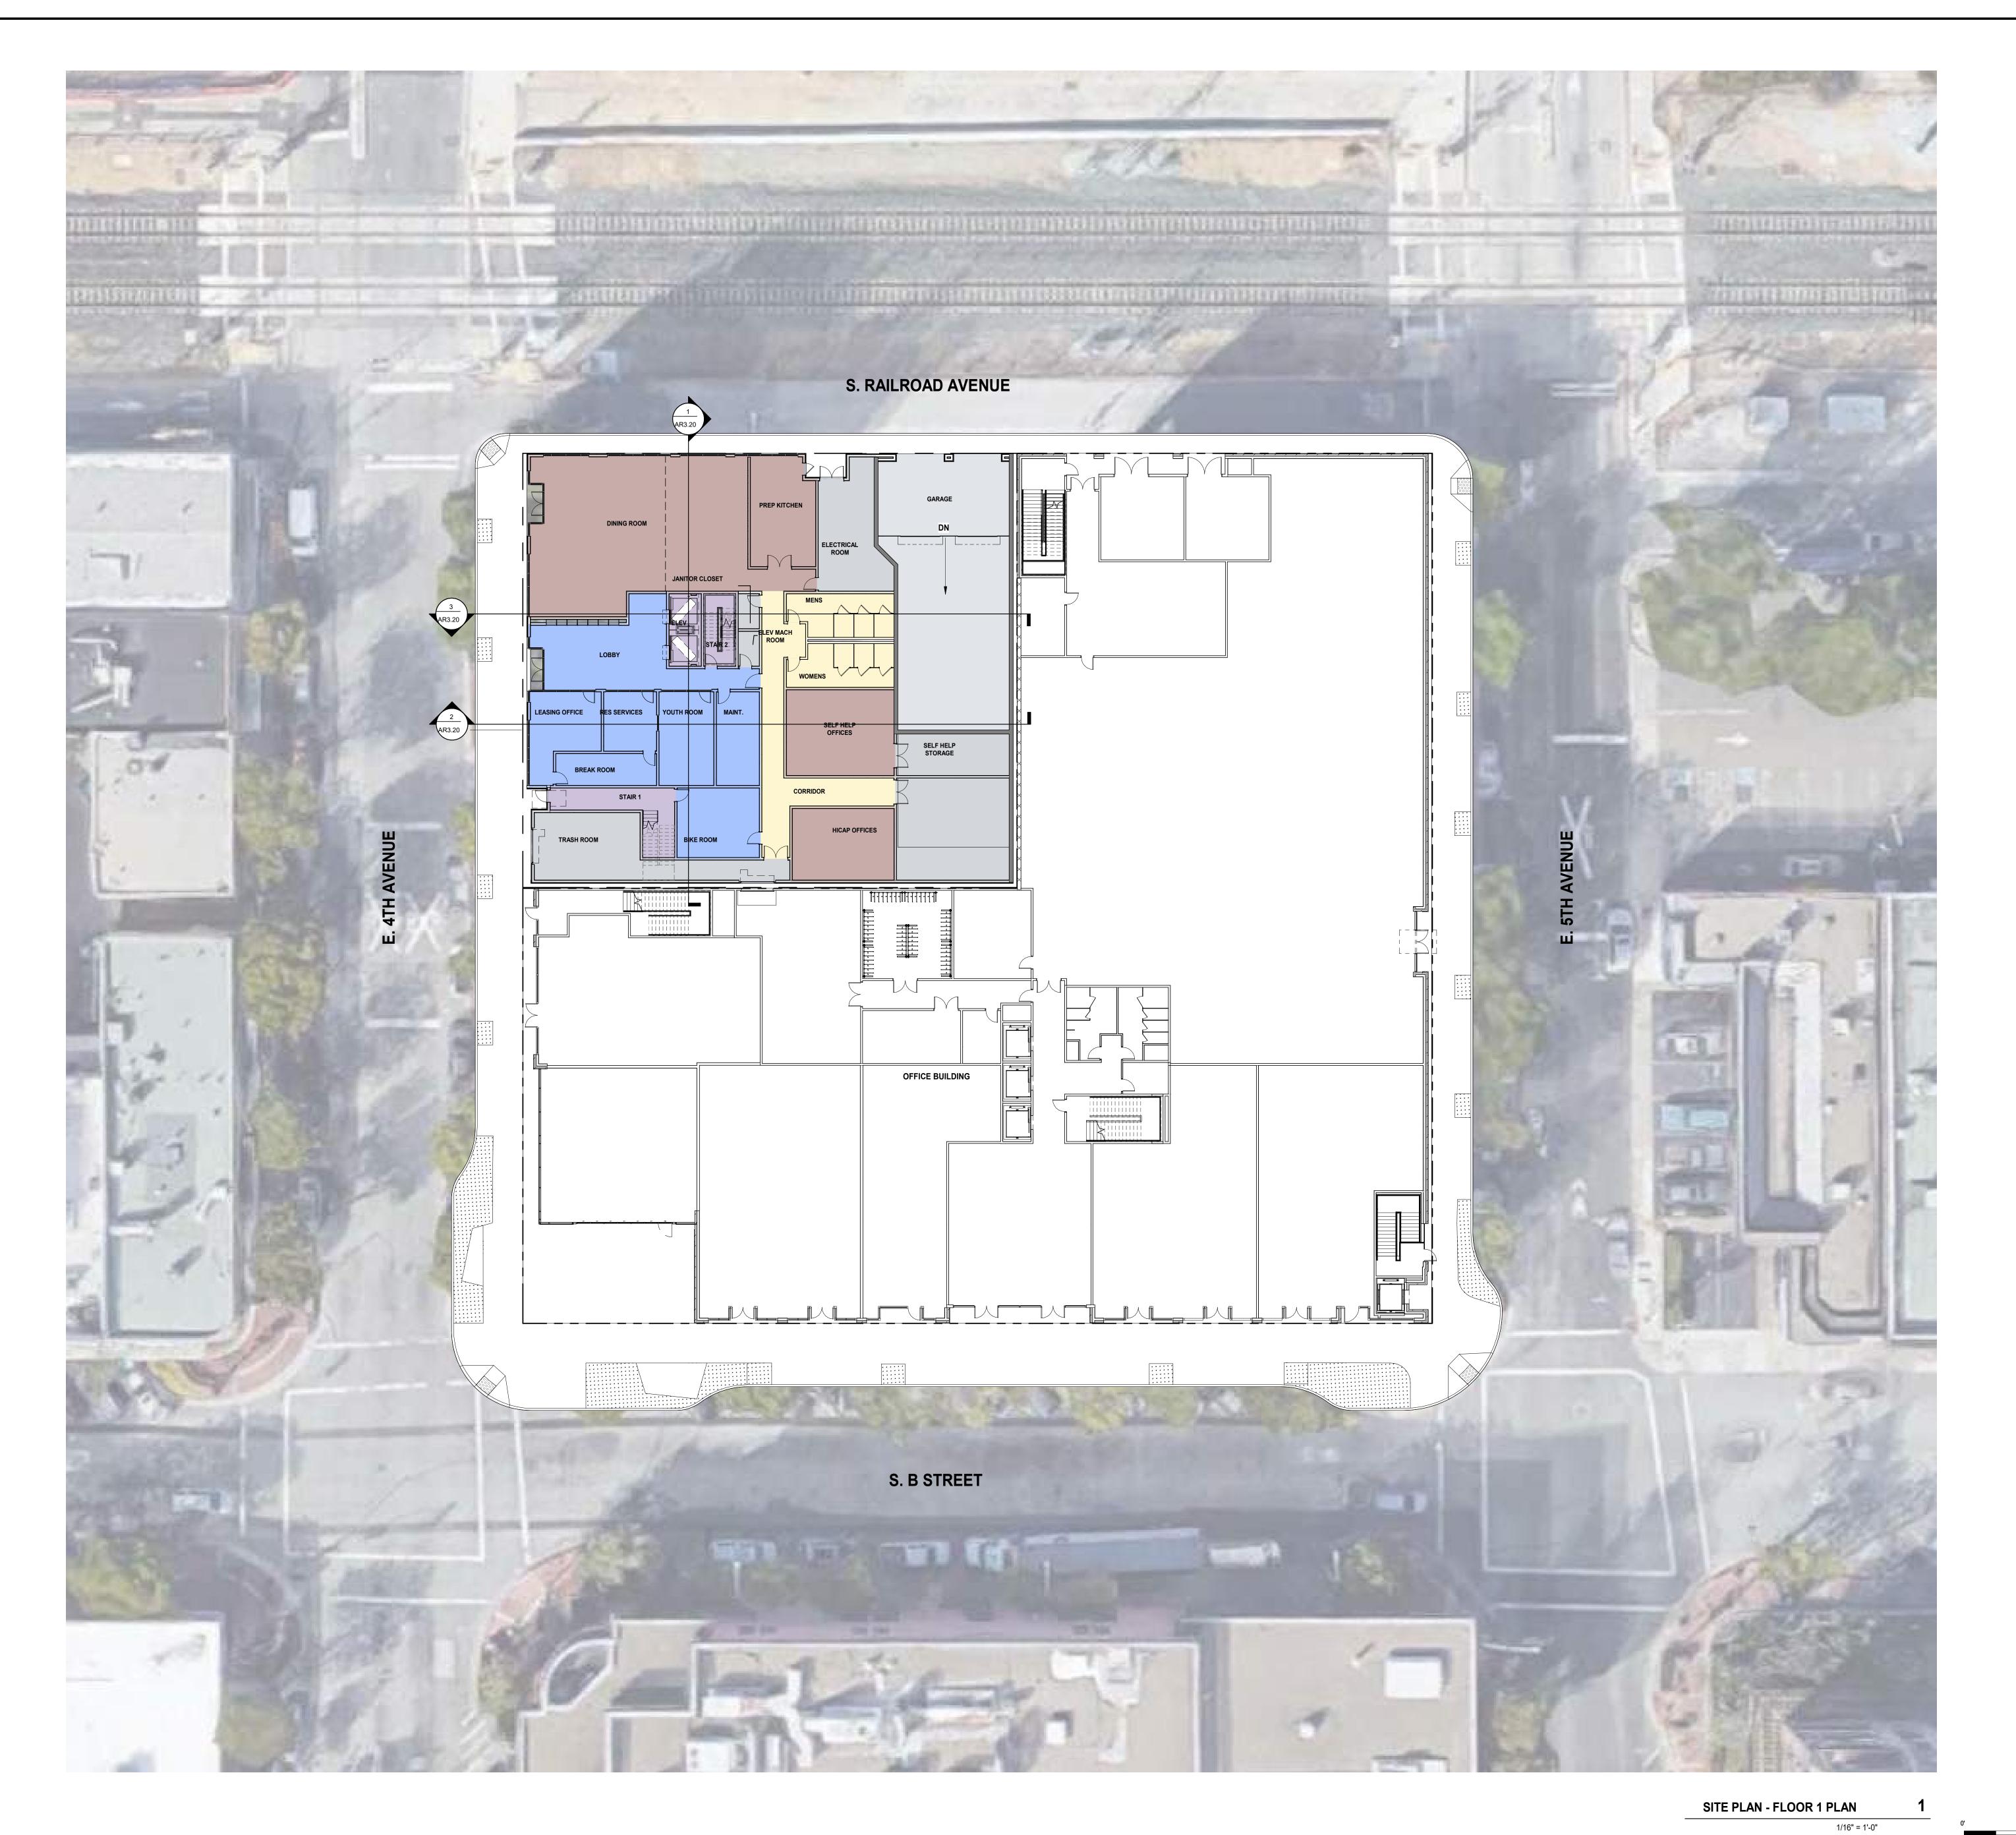

ARCHITECTURE

934 Howard Street
San Francisco, CA
94103

P. (415) 677-0966

CLIENT:

ALTA HARVES

O PROMETHEUS

PROJECT NAME & ADDRESS:

4TH & RAILROAD

#### 4TH & RAILROAD San Mateo, CA

ISSUE:		Project Status
ISSUE DATE:		Issue Date
REVISIONS :		
#	DESCRIPTION	DATE
PLANNING	APPLICATION	02/01/202


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DRAWN BY: NS
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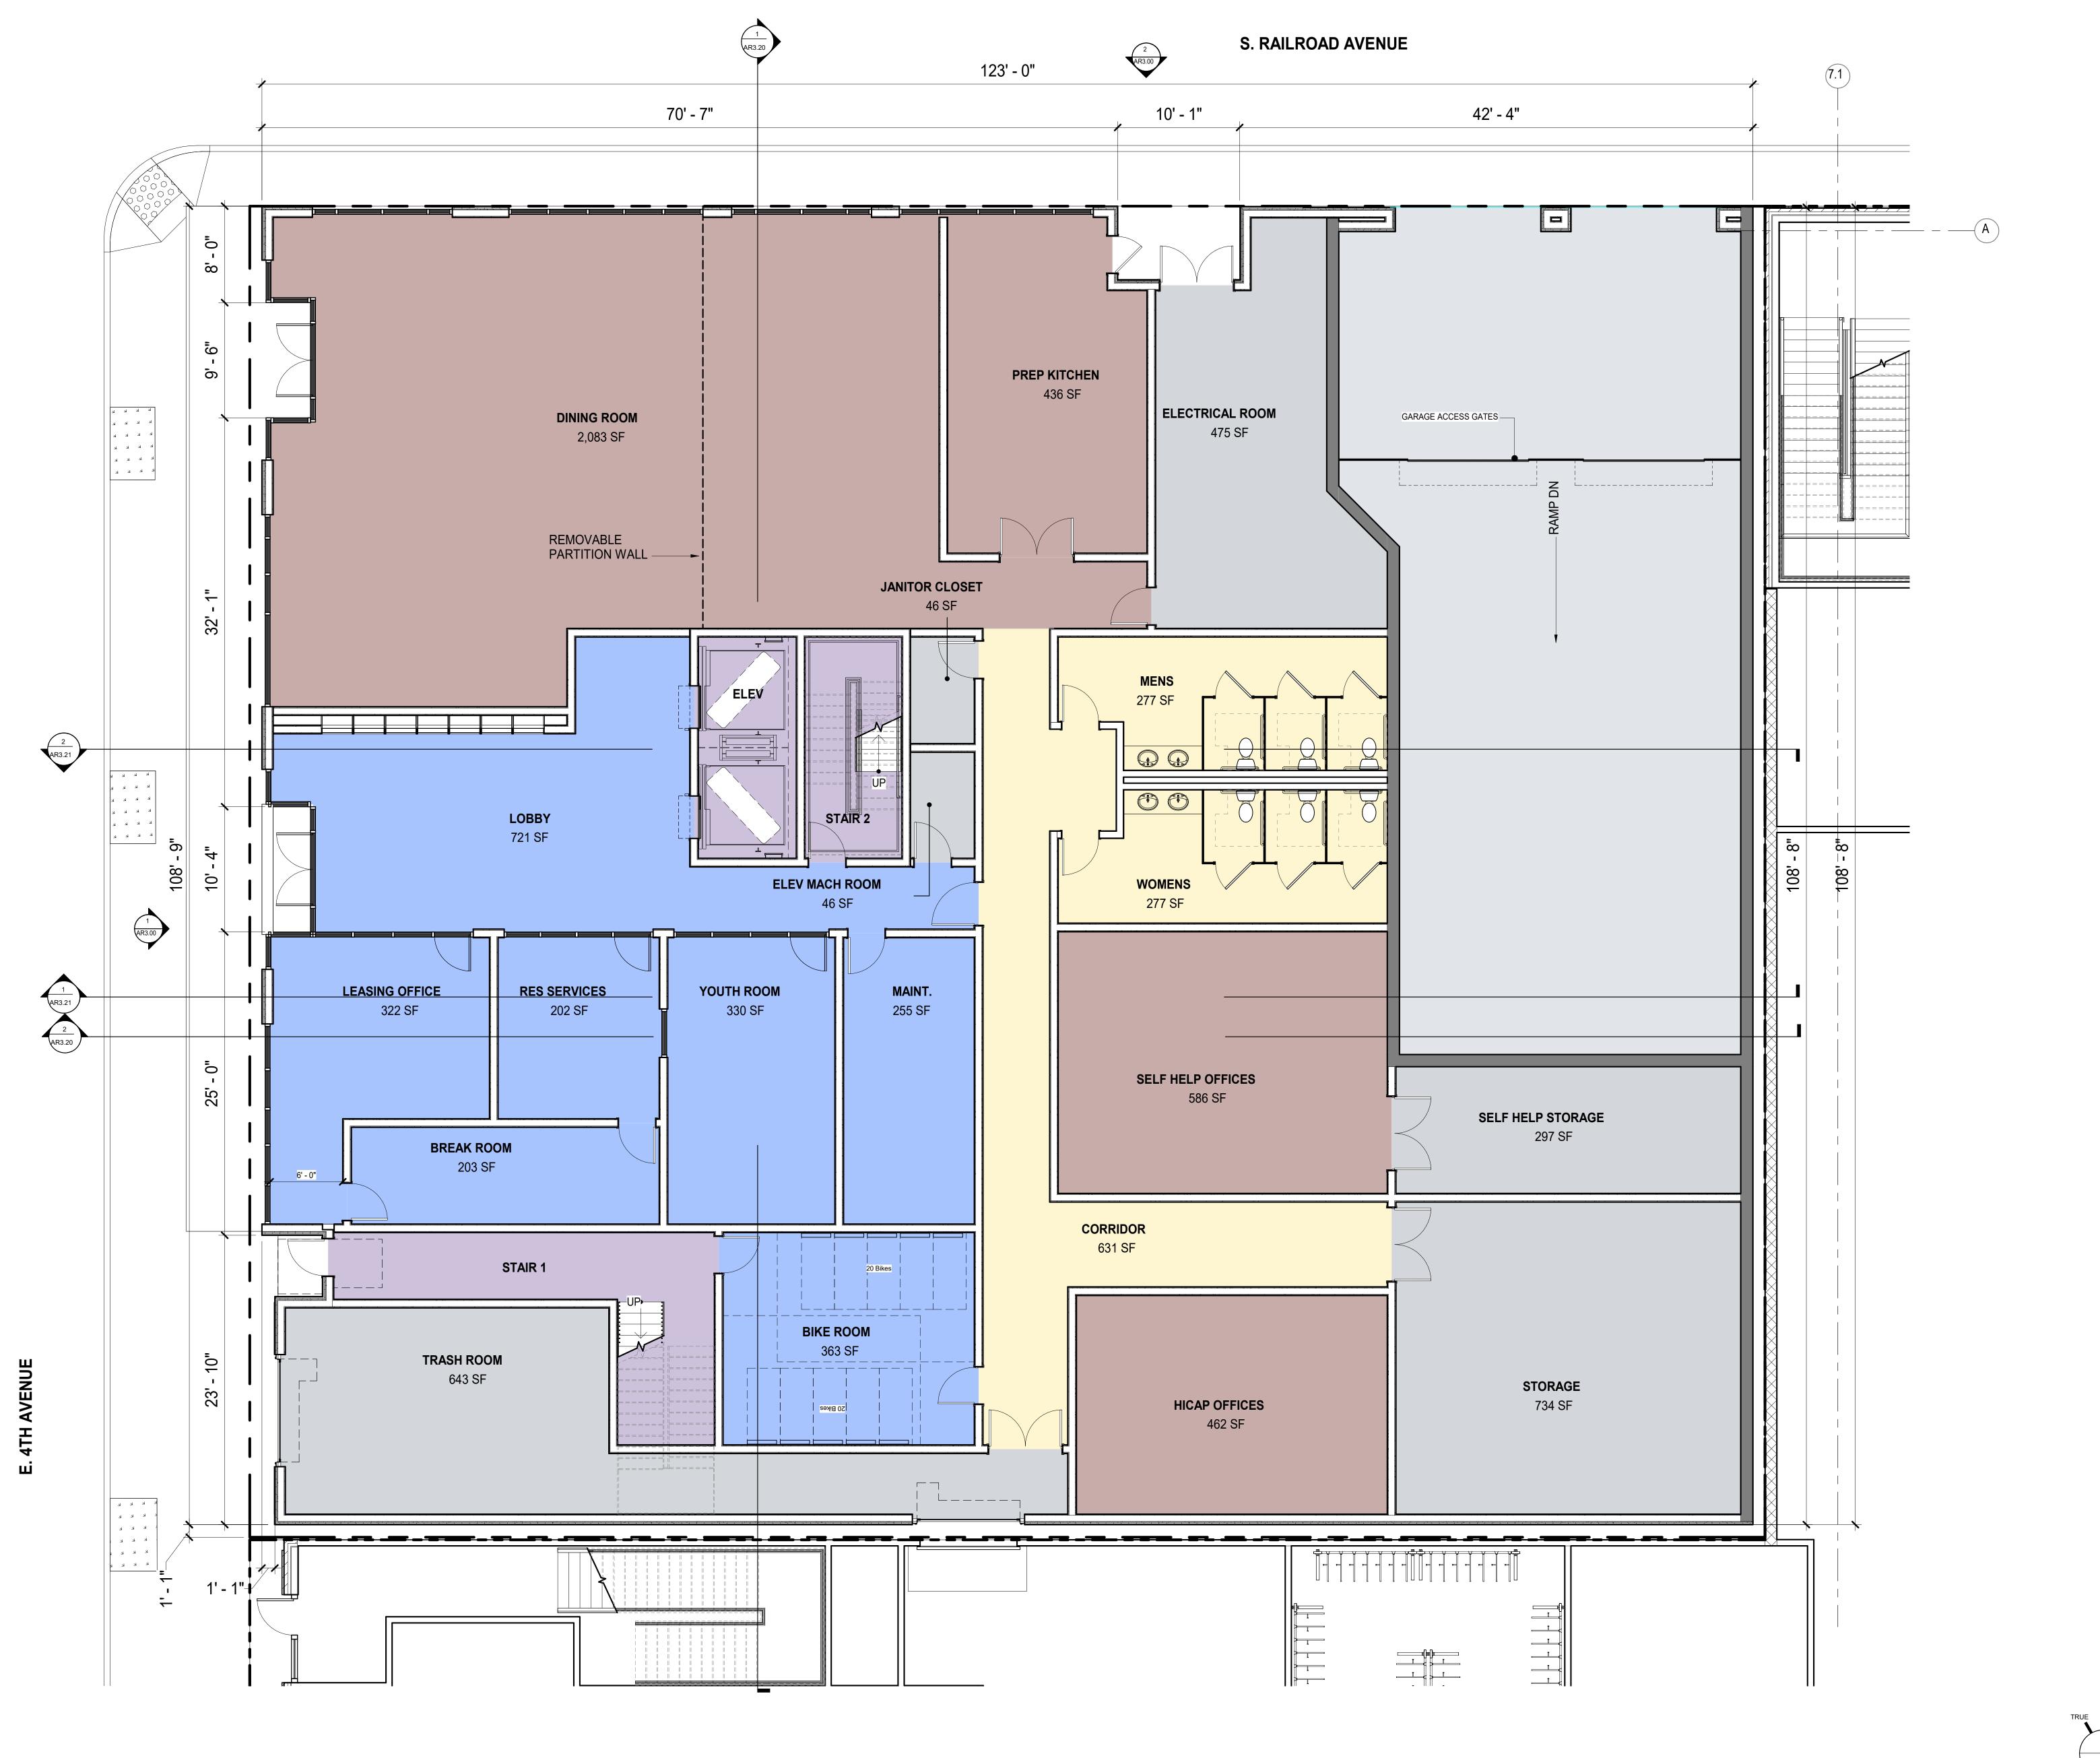
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ALL DRAWINGS AND WRITTEN MATERIA
APPEARING HEREIN CONSTITUTE ORIGINAL
AND UNPUBLISHED WORK OF TH
ARCHITECT AND MAY NOT BE DUPLICATEE
USED OR DISCLOSED WITHOUT TH
WRITTEN CONSENT OF THE ARCHITECT

SHEET NAME:
SITE PLAN



SCALE: 1/16" = 1'-0" SHEET SIZE: 30 x 42

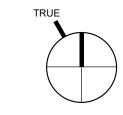

ARCHITECTURE 934 Howard Street San Francisco, CA 94103

P. (415) 677-0966

O PROMETHEUS

PROJECT NAME & ADDRESS: **4TH & RAILROAD** 

#### 4TH & RAILROAD San Mateo, CA

ISSUE: Project Status ISSUE DATE: Issue Date REVISIONS: **DATE** 02/01/2023

PROJECT NUMBER: CHECKED BY: STAMP:

SHEET NAME: FLOOR 1

SHEET NUMBER: **AR2.01** 

PLANNING - BUILDING PLAN - FLOOR 1

3/16" = 1'-0"



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P. (415) 677-0966

O PROMETHEUS

PROJECT NAME & ADDRESS: **4TH & RAILROAD** 

4TH & RAILROAD

San Mateo, CA


ISSUE: Project Status ISSUE DATE: Issue Date REVISIONS: **DATE** 02/01/2023

PROJECT NUMBER: CHECKED BY:

SHEET NAME: FLOOR 2


SHEET NUMBER:

**AR2.02** 

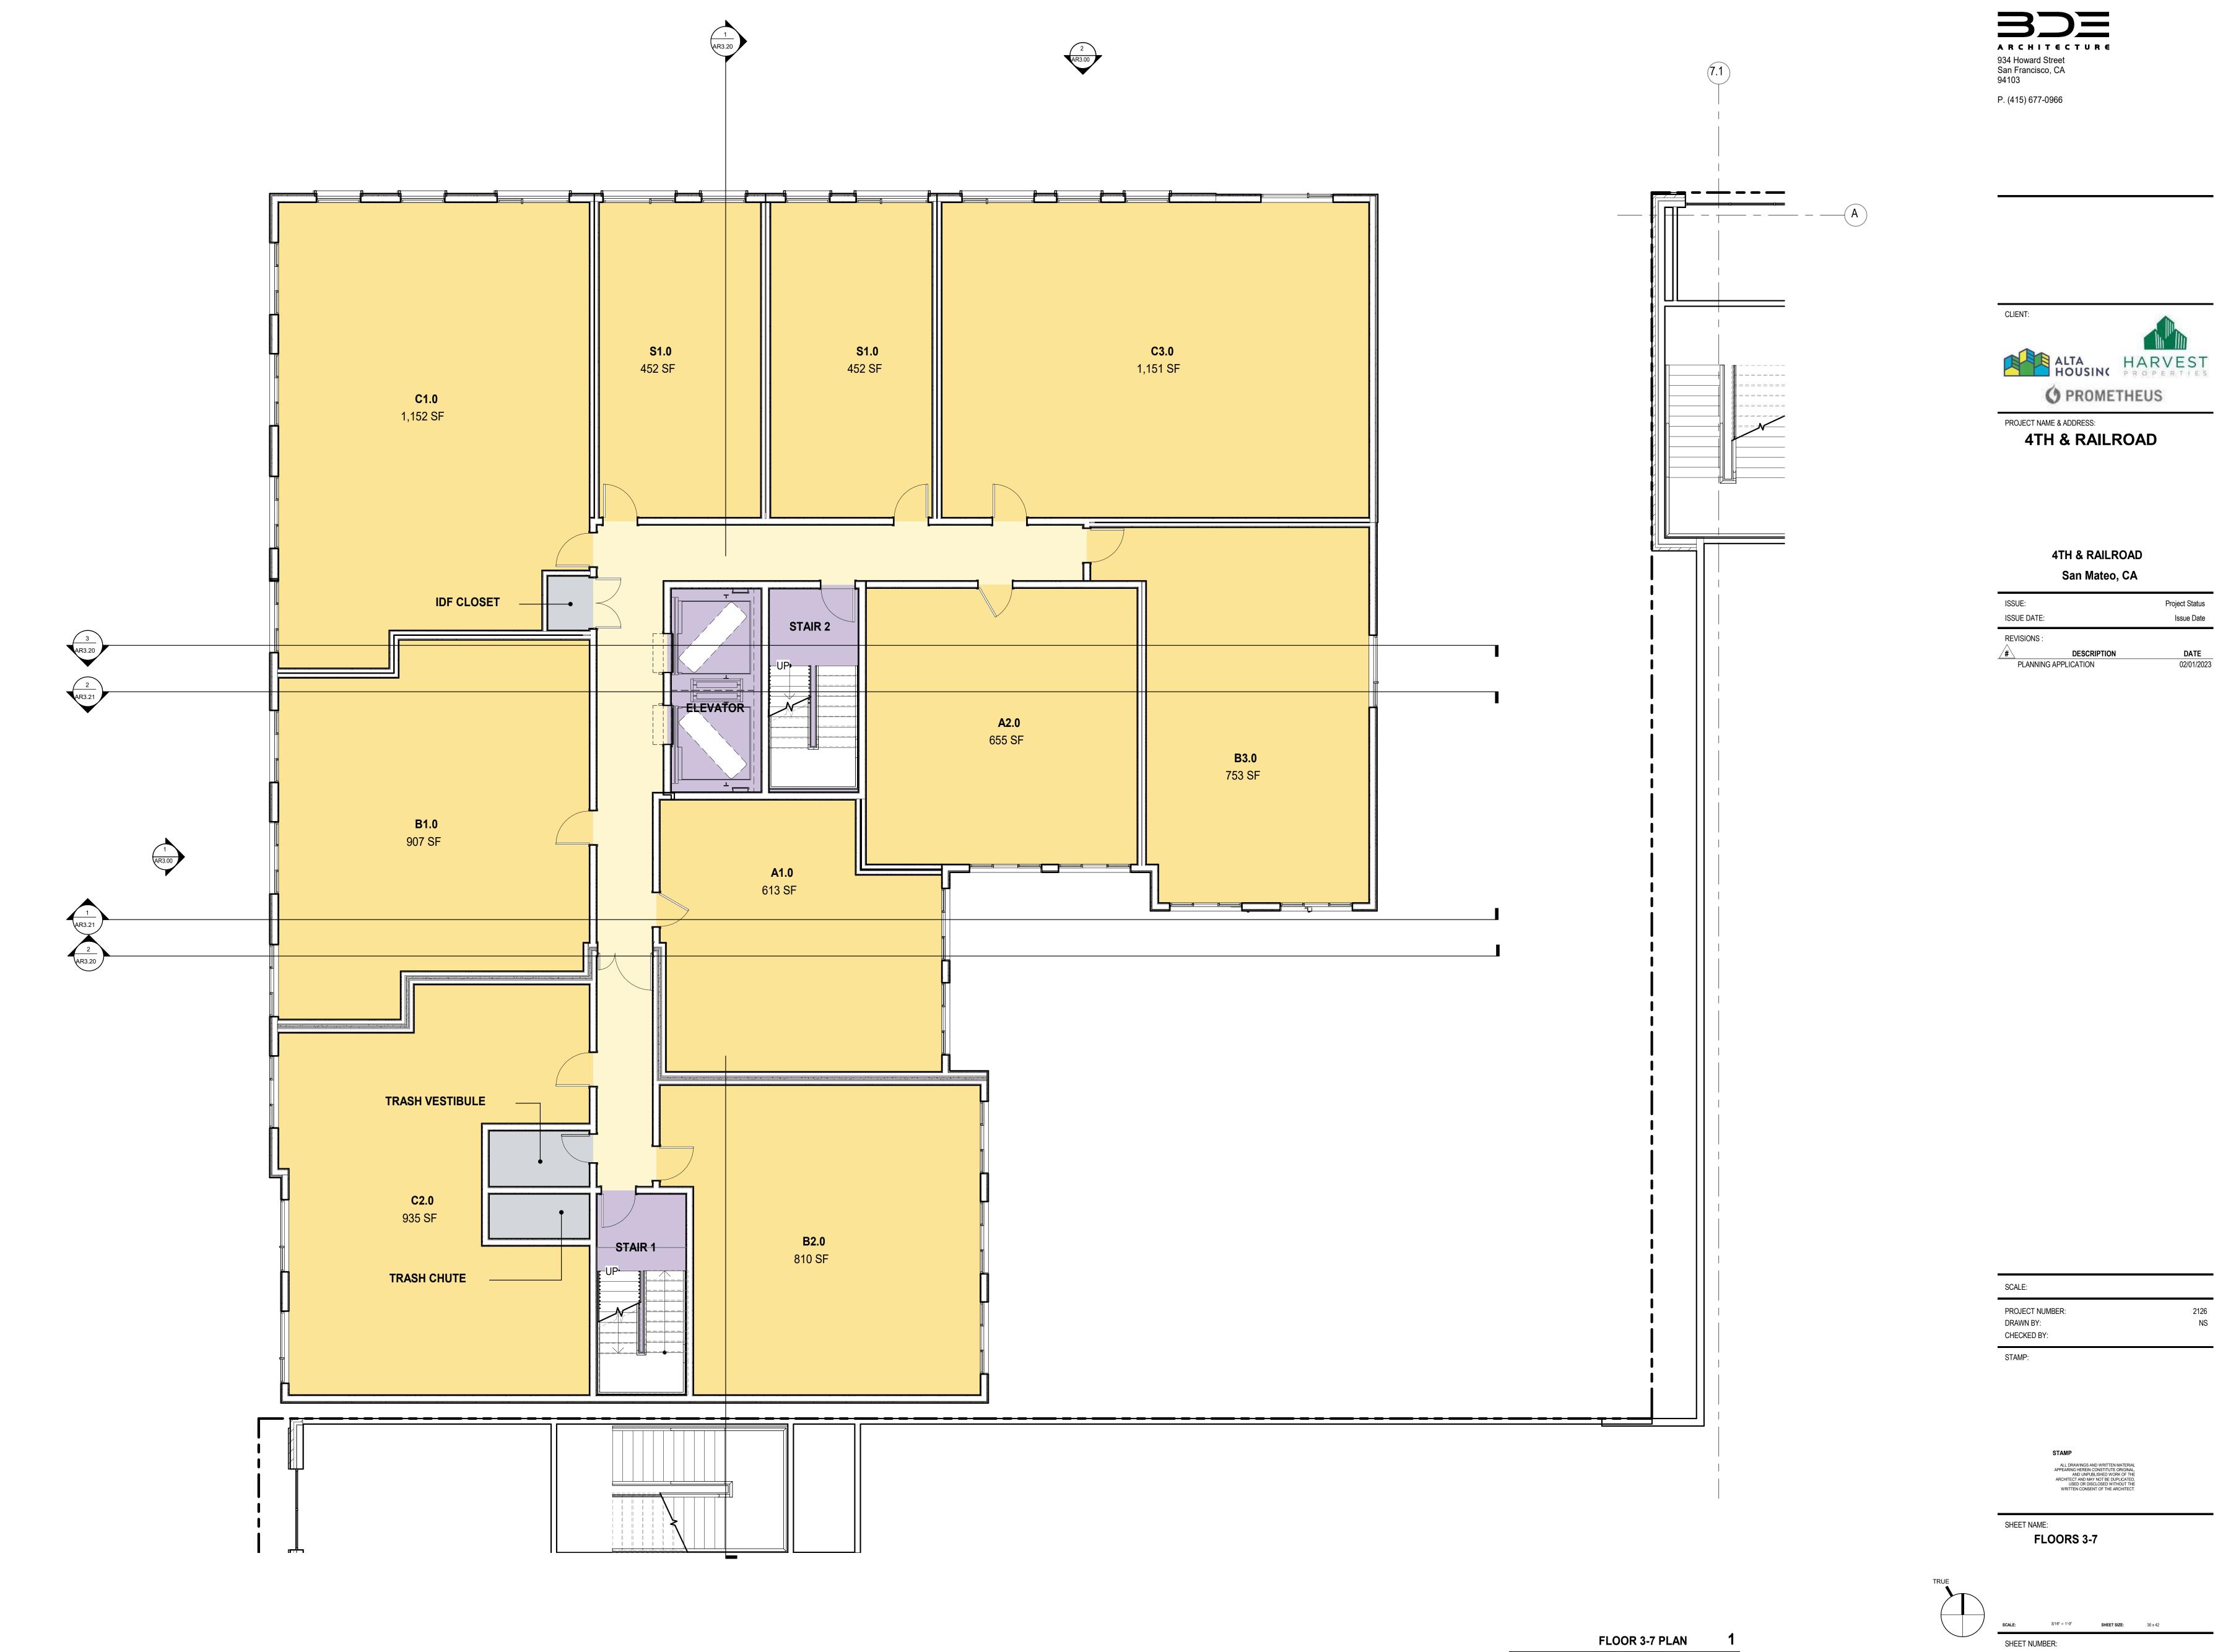

AR2.03

3/16" = 1'-0"

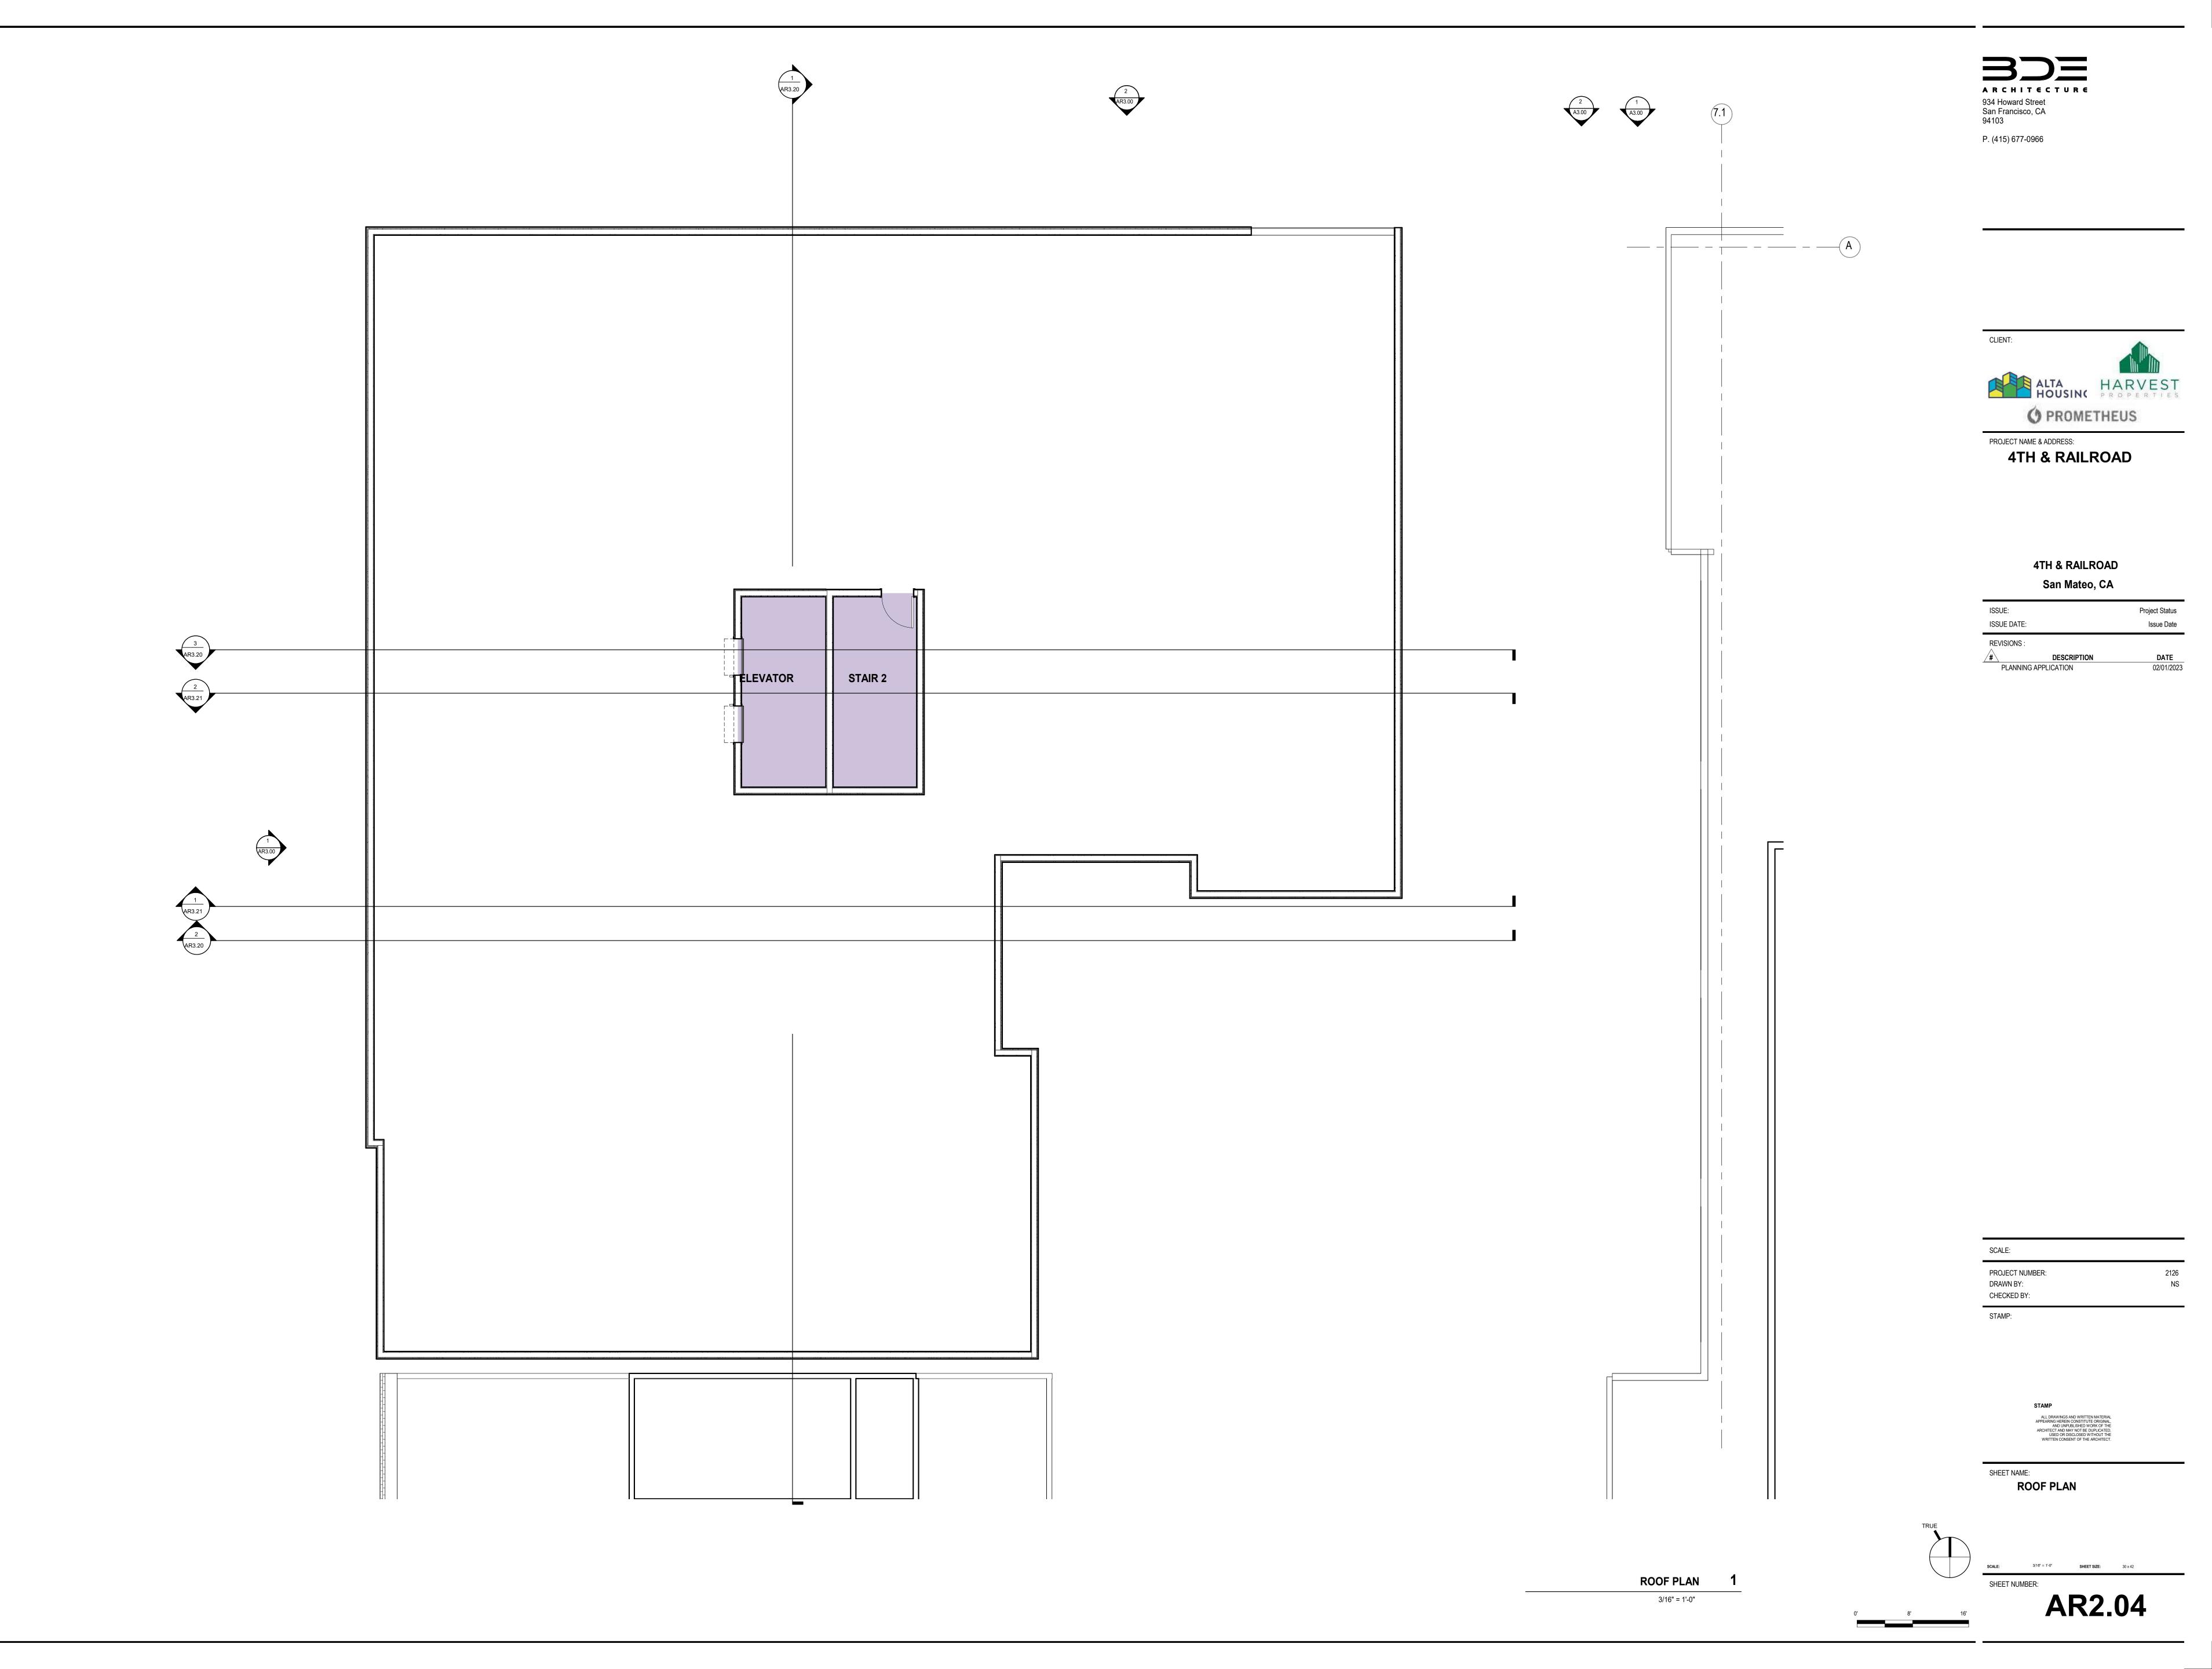





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ALTA HARVEST HOUSING PROPERTIES

PROJECT NAME & ADDRESS:

4TH & RAILROAD

4TH & RAILROAD
San Mateo, CA

ISSUE: Project Status
ISSUE DATE: Issue Date

REVISIONS:

# DESCRIPTION DATE
PLANNING APPLICATION 02/01/2023

BLOCK ELEVATION - RAILROAD AVENUE

2



SCALE:

PROJECT NUMBER: 2126

STAMP

ALL DRAWINGS AND WRITTEN MATERIAL
APPEARING HEREIN CONSTITUTE ORIGINAL.
AND UNPUBLISHED WORK OF THE

SHEET NAME:

BLOCK
ELEVATIONS

ELEVATION DE LE CONTRA LA CONTRA LA

SHEET NUMBER:

AR3.00

BLOCK ELEVATION - E 4TH AVENUE



46' - 0"


T.O. SUBFLOOR
FLOOR 5 T.O. SUBFLOOR FLOOR 4


**ELEVATION - E 4TH AVENUE** 

3/32" = 1'-0"

WINDOW & STOREFRONT 'ARCH BRONZE' DRAGON'S BREATH BM 1547



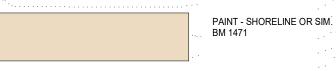

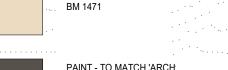



P. (415) 677-0966

CLIENT:

PAINT - TO MATCH 'ARCH . BRONZE' WINDOW AND STOREFRONT FINISH







RECESSED VINYL NAIL FIN WINDOWS COLOR: BLACK OR SIM.

O PROMETHEUS PROJECT NAME & ADDRESS: 4TH & RAILROAD


Project Status

Issue Date

**DATE** 02/01/2023





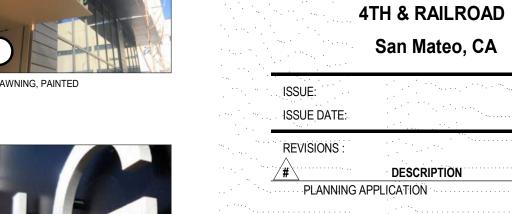


RESIDENTIAL ENTRANCE DOWNWARD LIT BUILDING SCONCE FIBER CEMENT TRIM, PTD, OR SIM. 12 MTL SPANDREL PANEL, OR SIM. GLASS RAILING BRICK SOLDIER COURSE JULIET RAILING

SHEET NAME:

BUILDING

ELEVATIONS

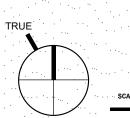

SHEET NUMBER: AR3.01






O PROMETHEUS

PROJECT NAME & ADDRESS: **4TH & RAILROAD** 

#### 4TH & RAILROAD San Mateo, CA

	,	
ISSUE:		Project Statu
ISSUE DATE:		Issue Dat
REVISIONS :		
#	DESCRIPTION	DATE
PLANNING	APPLICATION	02/01/2

RAILROAD AVENUE

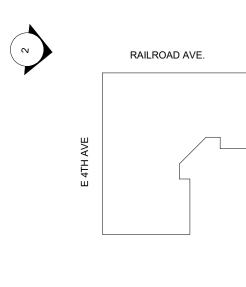

RAILROAD & E 4TH AVENUE



SELF HELP FOR THE ELDER

SHEET NAME:
PERSPECTIVE
VIEWS

AR3.02

RAILROAD & E 4TH AVENUE

E 4TH AVENUE





#### PERSPECTIVE - E 4TH AVENUE


12" = 1'-0"





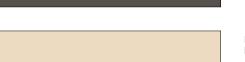


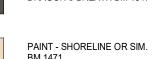

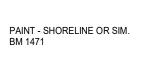





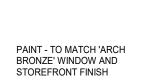


934 Howard Street San Francisco, CA 94103 P. (415) 677-0966

ARCHITECTURE





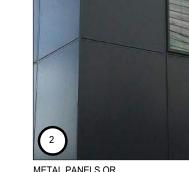

METAL PANELS OR SMOOTH PLASTER COLOR: BLACK OR SIM.





O PROMETHEUS PROJECT NAME & ADDRESS: **4TH & RAILROAD** 


**4TH & RAILROAD** 

Project Status

Issue Date


**DATE** 02/01/2023



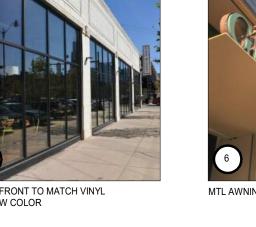





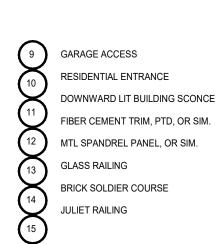


PROJECT NUMBER: CHECKED BY:

SHEET NAME:

MATERIAL

BOARD

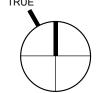


SHEET NUMBER:

**AR3.10** 


PERSPECTIVE - E 4TH AVENUE





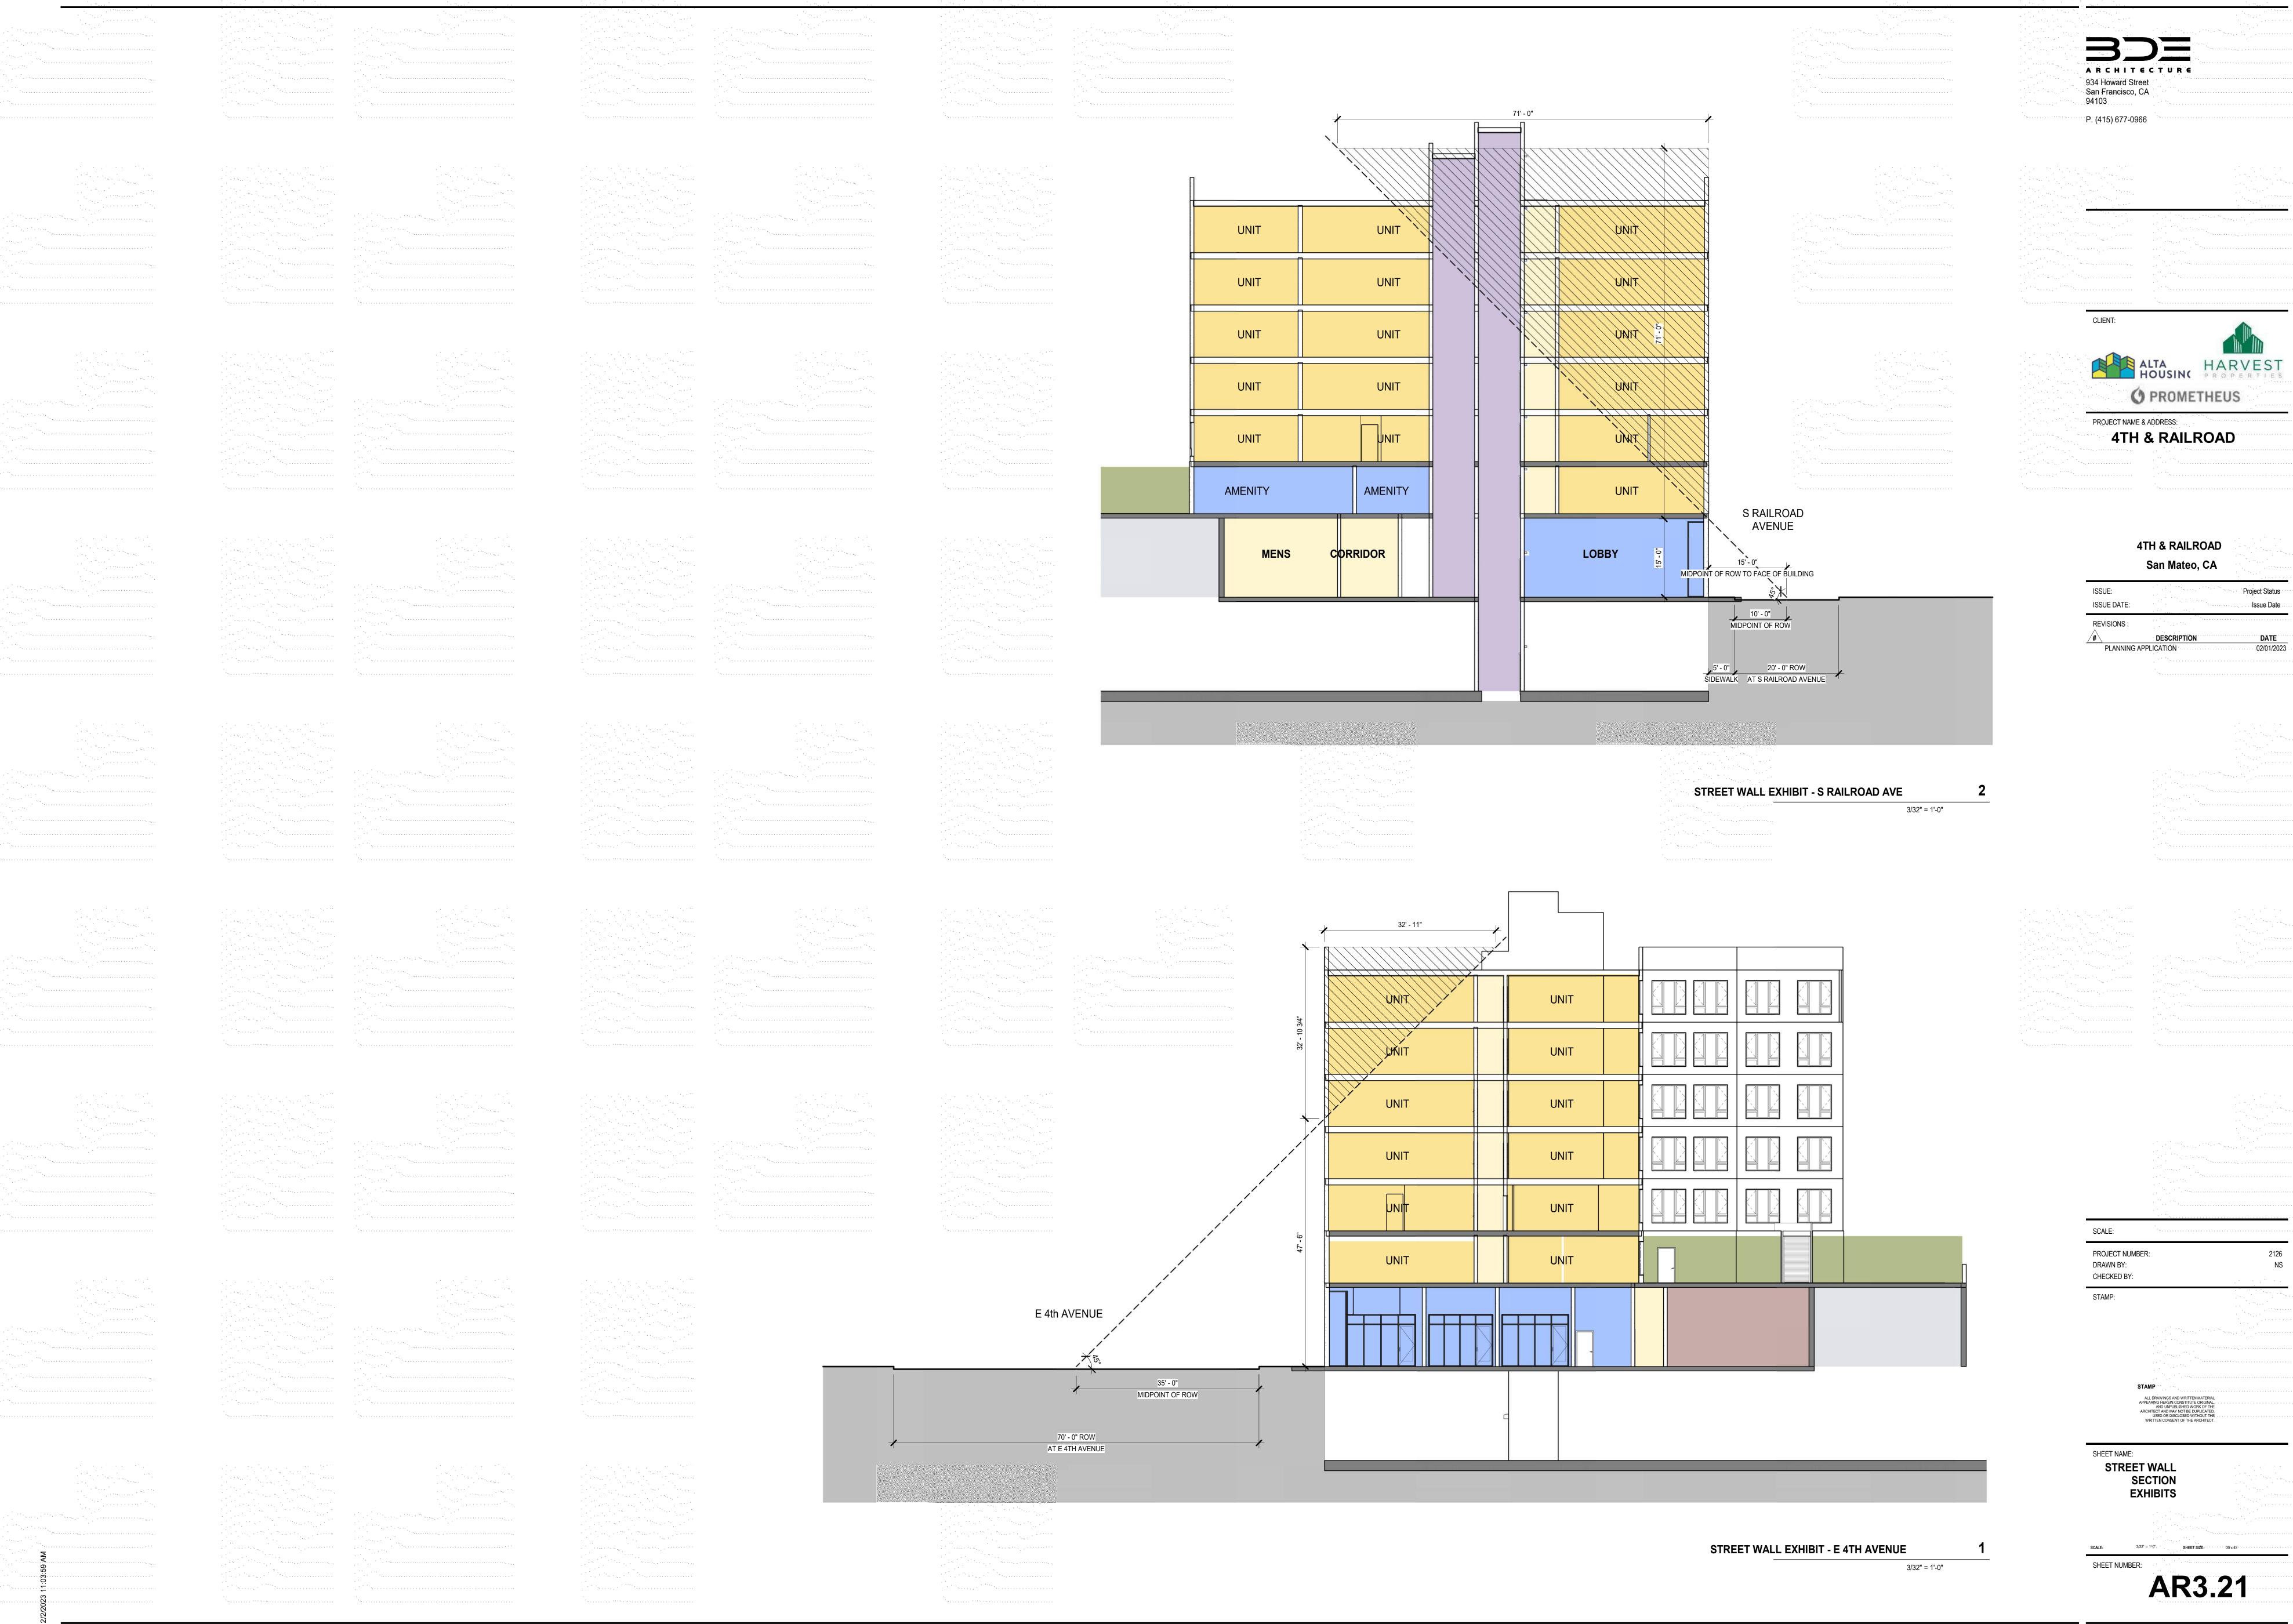



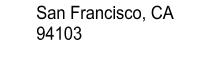

P. (415) 677-0966



CLIENT: HARVEST

O PROMETHEUS

PROJECT NAME & ADDRESS: **4TH & RAILROAD** 

**4TH & RAILROAD** 

	San Mateo, C	Α
ISSUE:		
ISSUE DATE:		
REVISIONS:		
<u>/</u> #	DESCRIPTION	DATE
PLANNING S	UBMISSION	2/01/2023

A1 CONCRETE PAVER, CITY STANDARD

B2 NOT USED

B3 NOT USED

(C1) RUBBERIZED SURFACING

PLANTER

G1) AT GRADE PLANTING AREA

G2 RAISED PLANTING AREA

(G3) RAISED STORMWATER PLANTING AREA

SITE FURNISHINGS, EGRESS

**BUILT-IN BENCH** 

MOVEABLE FURNITURE (TBD BY TENANT)

SCULPTURAL PLAY EQUIPMENT (OVER 600SF PLAY AREA)

CANVAS AWNING SUSPENDED ON CABLES

TREE

T1 PROPOSED TREE

STORMWATER PLANTER

PLANTING AREA

27.38.130 RESIDENTIAL DEVELOPMENT STANDARDS

C) Open Space. Residential development shall include private usable open space equal to at least 80SF per dwelling unit or common usble open space equal to at least 150% of the private usable open space requiremetns, or a combination of both.

UNITS PROVIDED: 60

OPEN SPACE REQUIRED: 7200 SF

OPEN SPACE PROVIDED: 4076 SF

SCALE: 3/16" = 1'-0" PROJECT NUMBER: CHECKED BY:

## **NOT FOR** CONSTRUCTION

SHEET NAME: LEVEL 2


STAMP:



LANDSCAPE PLAN AMENITY TERRACE

SHEET NUMBER:

LR1.0

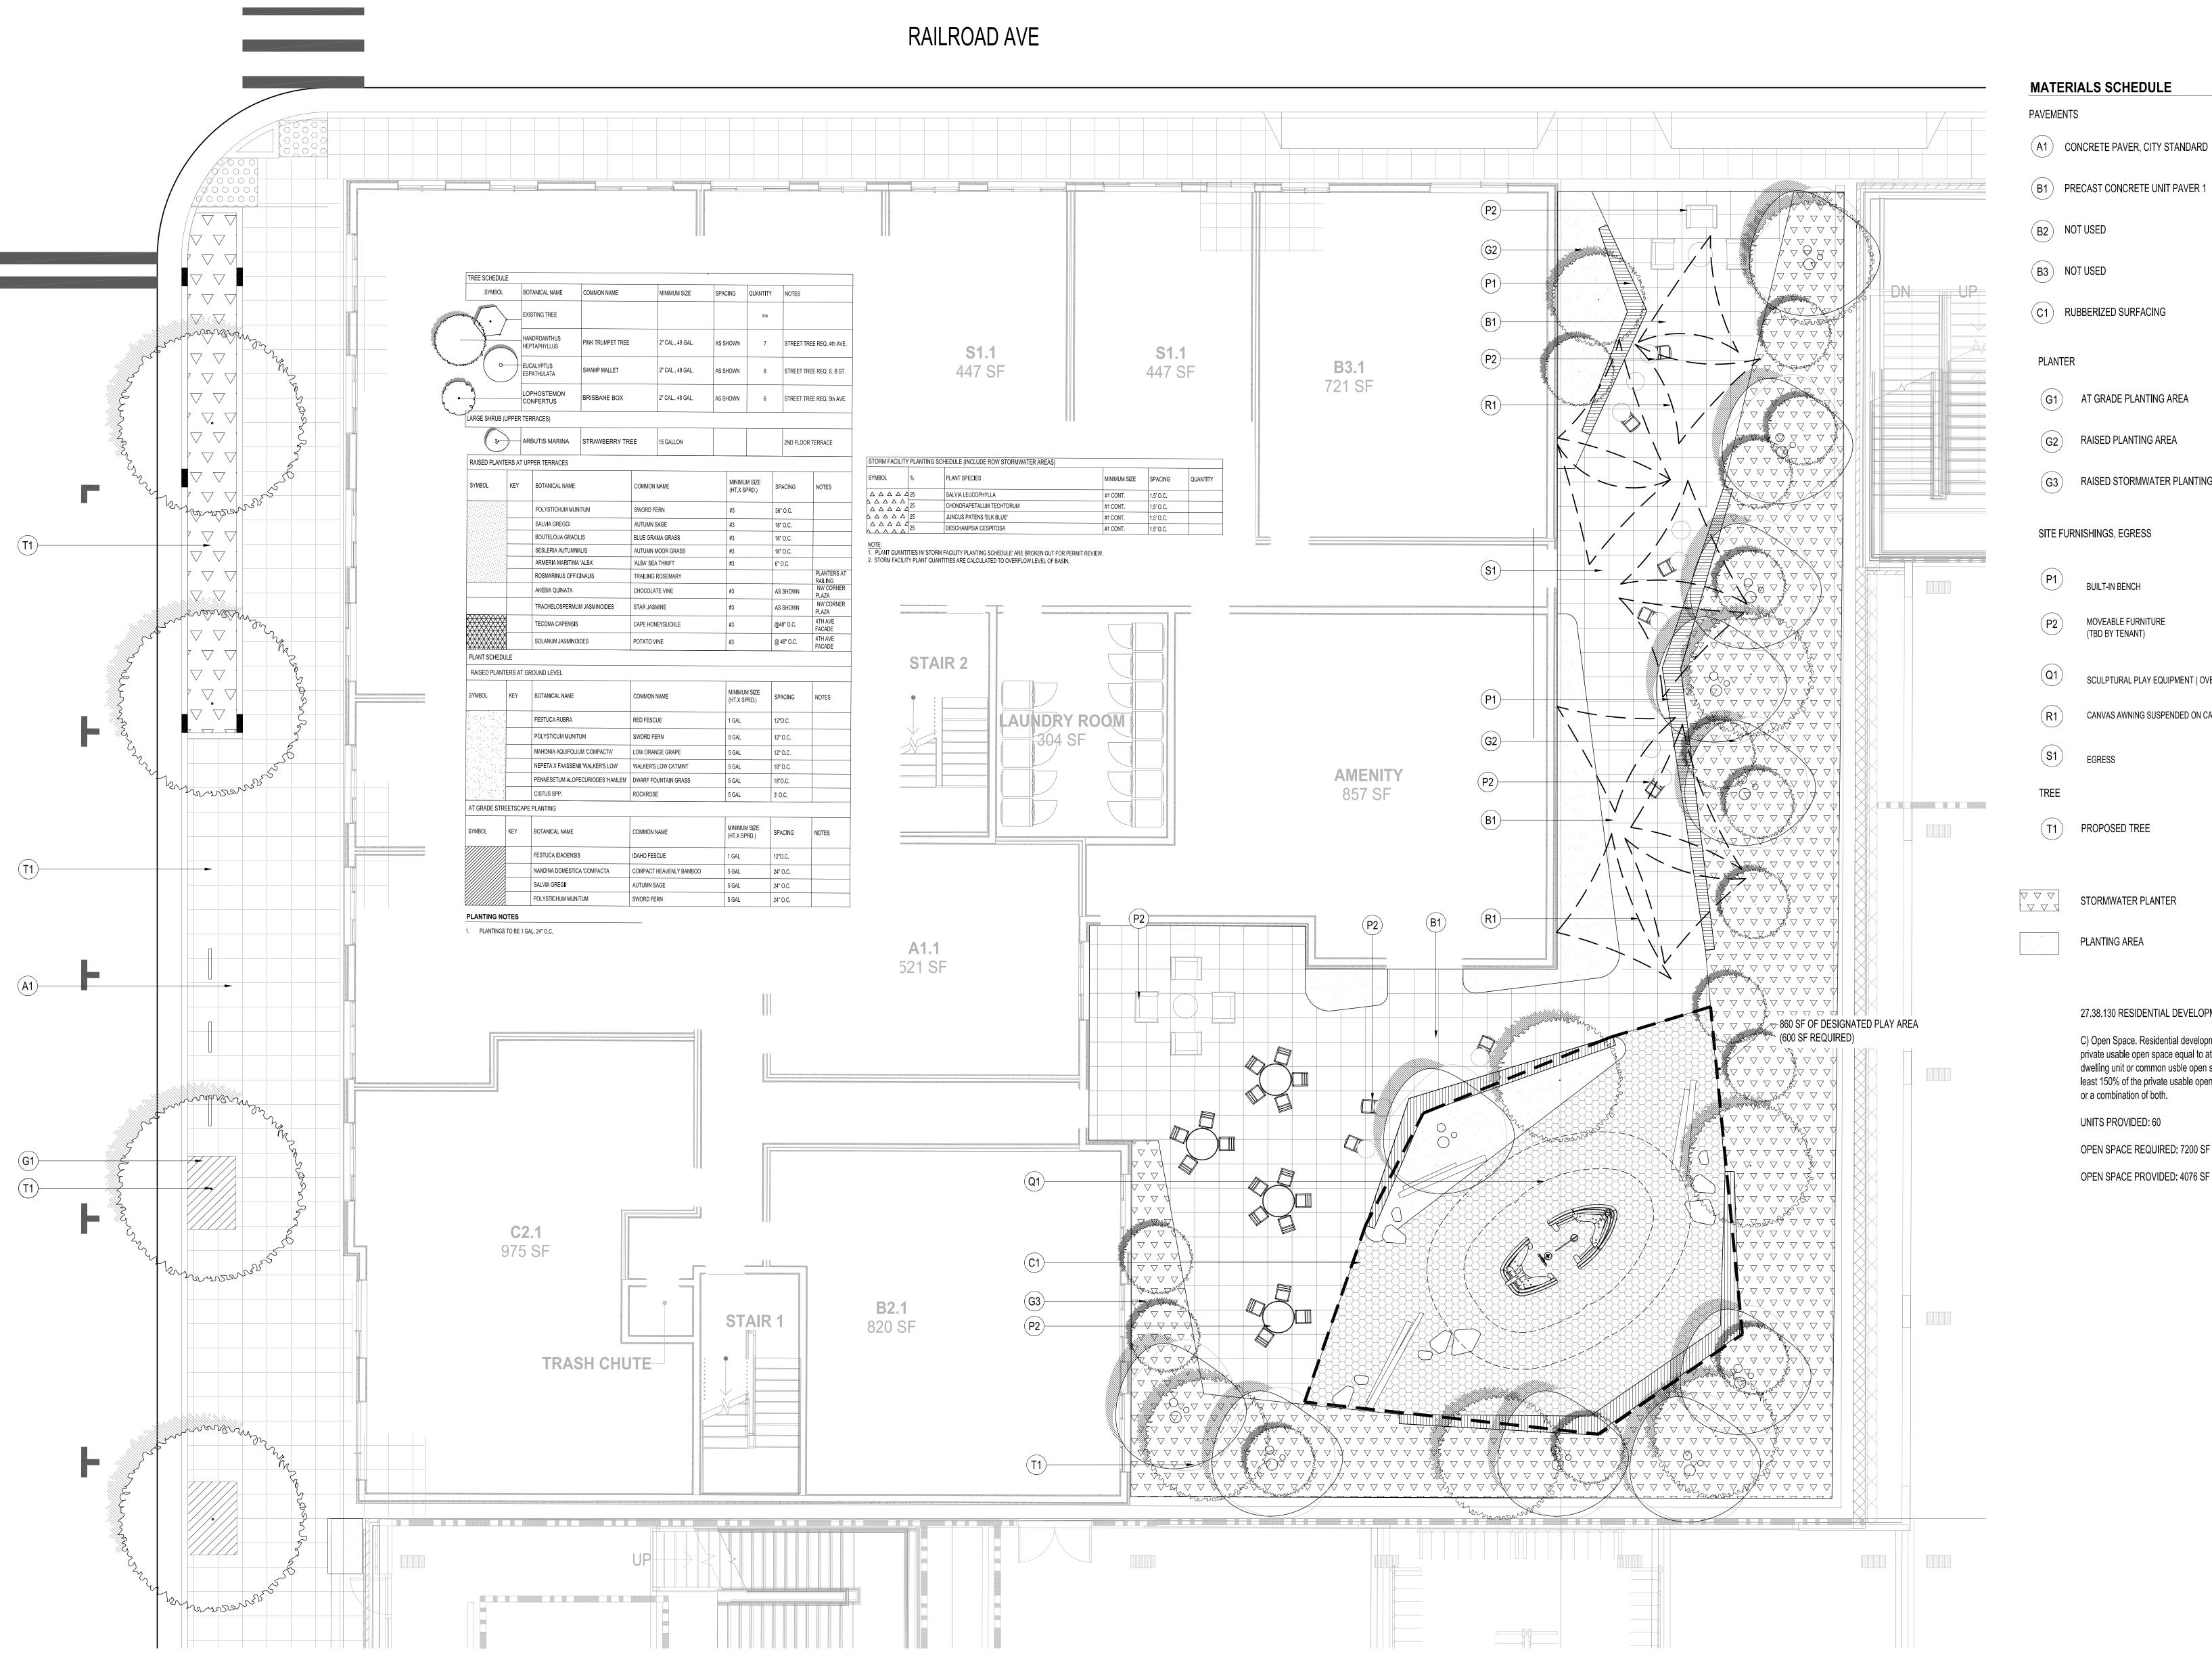


## FOR ILLUSTRATIVE PURPOSES ONLY




LOOKING PLAN SOUTH, TOWARDS SCULPTURAL PLAY AREA, WITH SEATING AREA



LOOKING PLAN NORTH, TOWARDS SCULPTURAL PLAY AREA, WITH SEATING AREA

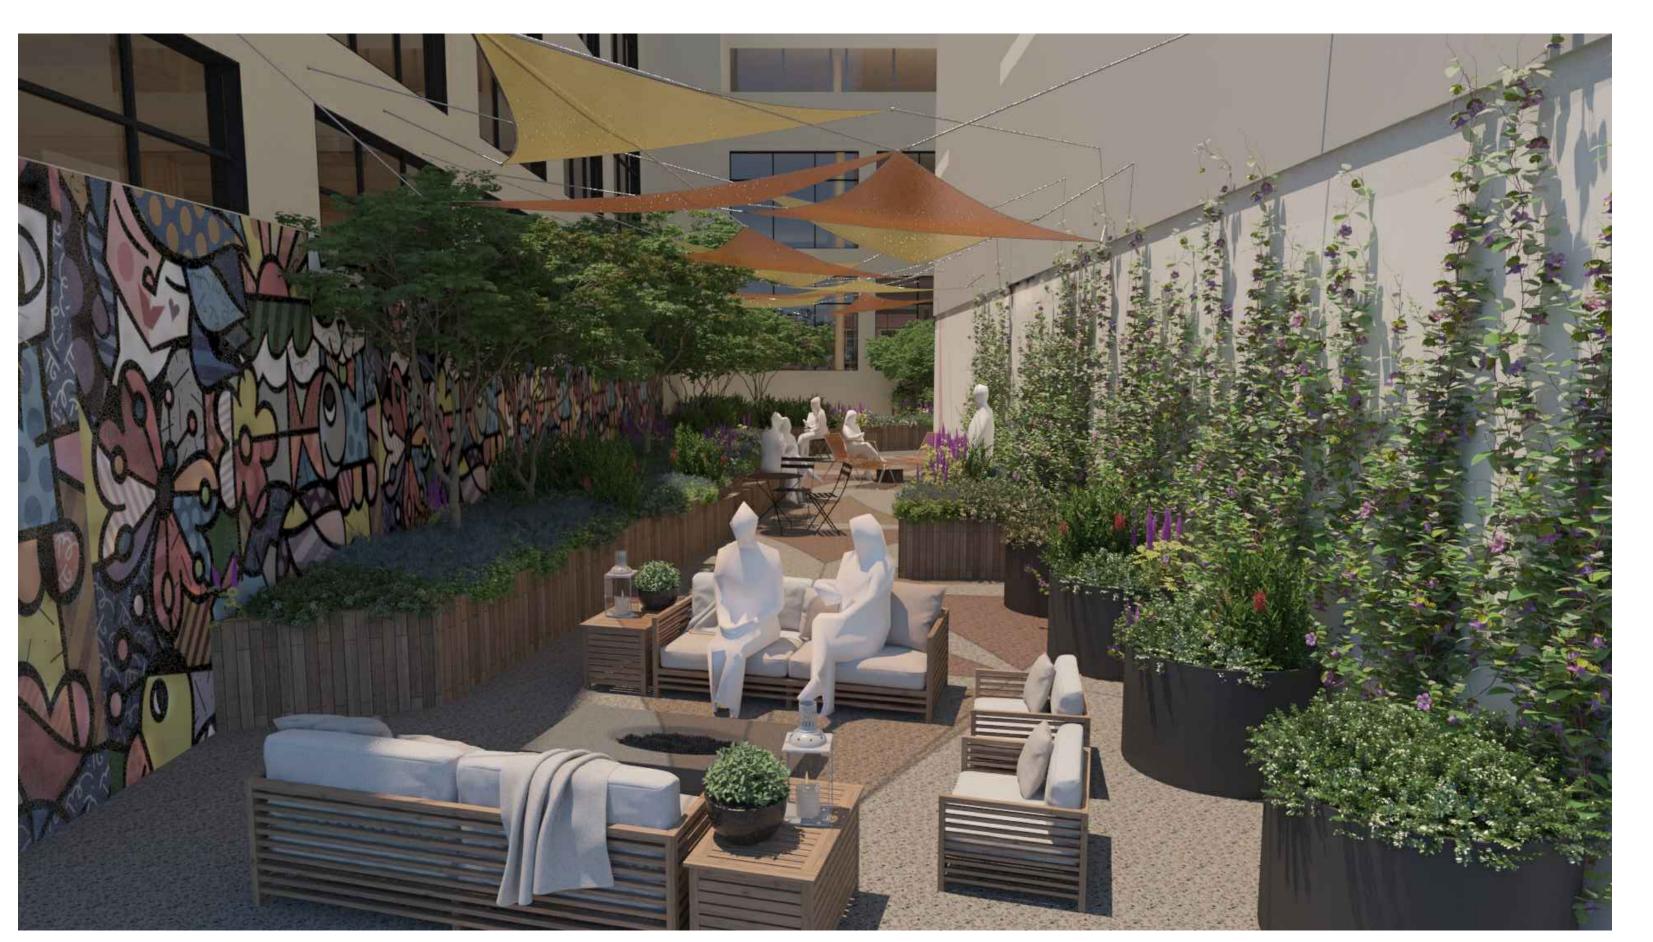

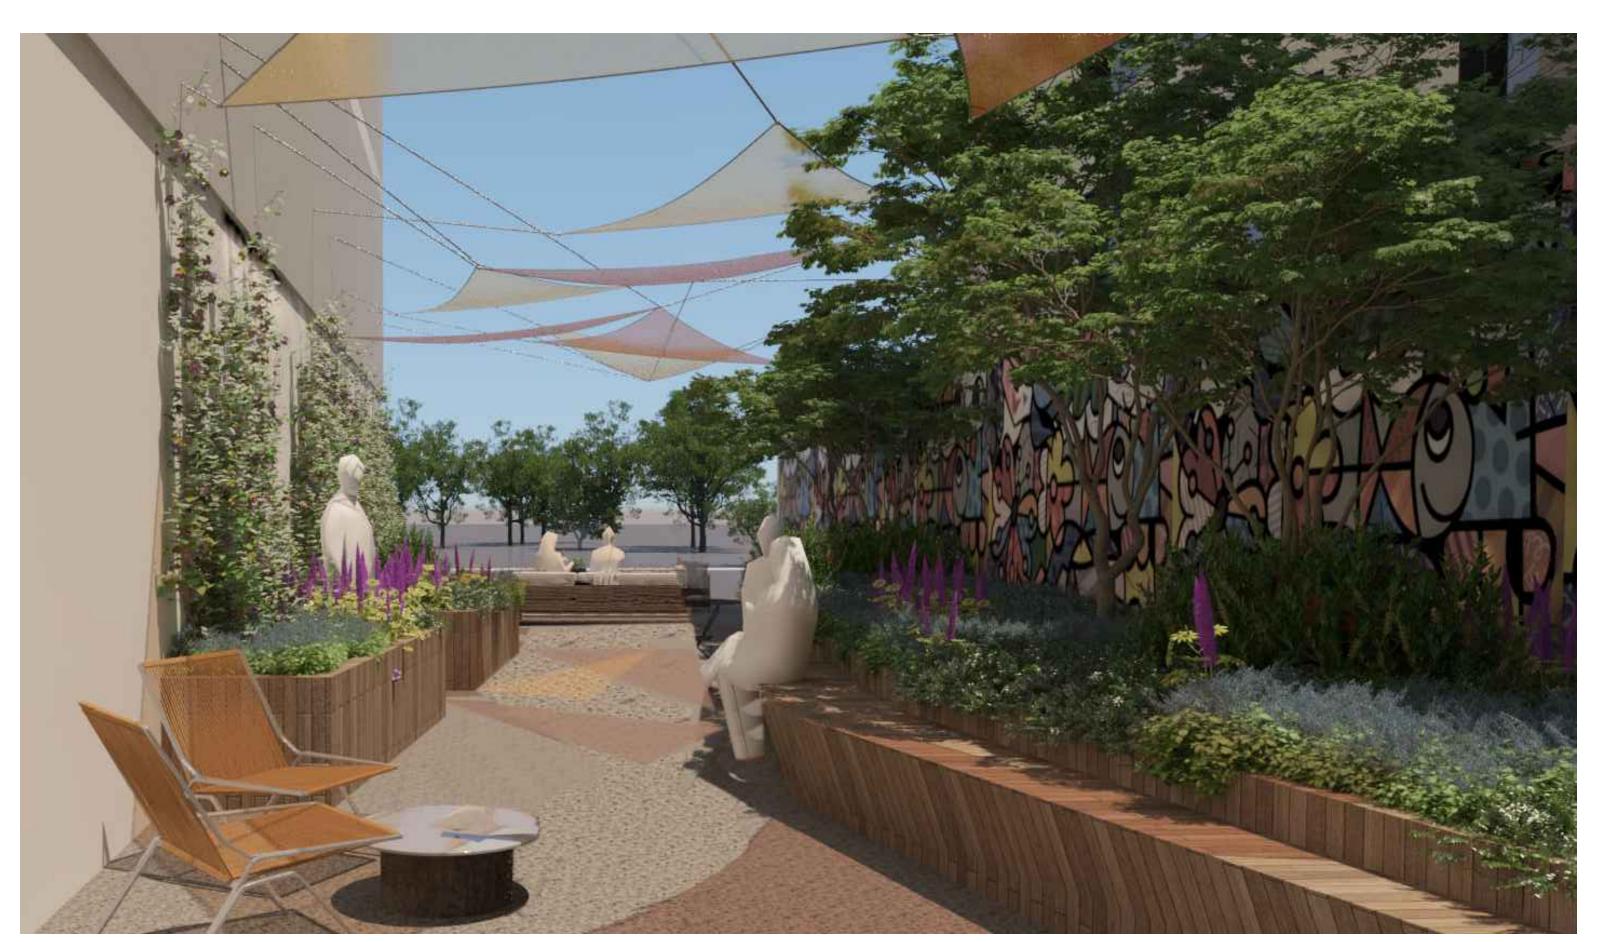

LOOKING PLAN NORTH, WITH FREESTYLE SEATING, GREENWALL AND SHADE CANOPY THAT HELPS TO PROVIDE PRIVACY. MURAL ALONG LONG BLANK FACADE TO PLAN EAST.



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HARVEST

PROMETHEUS

PROJECT NAME & ADDRESS:

4TH & RAILROAD

4TH & RAILROAD San Mateo, CA

DESCRIPTION	DATE
	<b>DESCRIPTION</b> JBMISSION

PROJECT NUMBER: 2202017.00
DRAWN BY: TH
CHECKED BY: CB

# NOT FOR CONSTRUCTION

LANDSCAPE
RENDERINGS
LEVEL 2 TERRACE



SHEET NUMBER:

LR2.0