
## DEFINITIVE SUBDIVISION PLAN BROGDEN ROAD EXTENSION

# A 2 LOT SINGLE-FAMILY RESIDENTIAL SUBDIVISION ASHLAND, MASSACHUSETTS

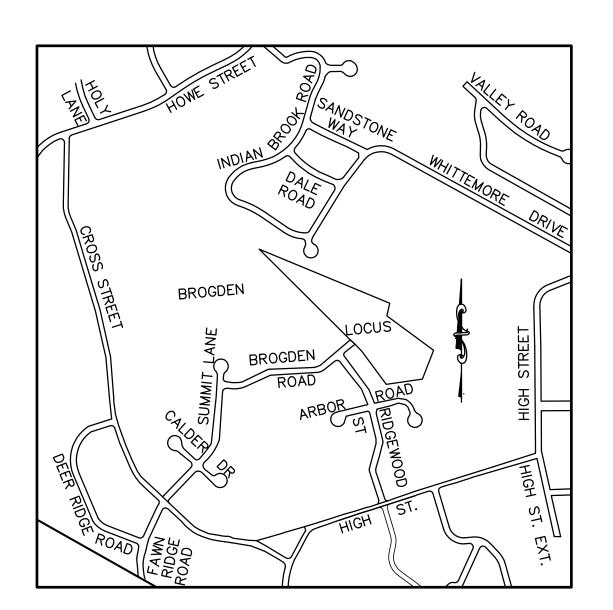


LOCUS
SCALE: 1"=800'

#### WAIVERS REQUESTED:

1.) SECTION 344.12.F.4 Dead—end streets shall be provided at the closed end with a turnaround having a property line diameter of at least one hundred twenty (120) feet. An island shall be installed within the center of the cul—de—sac. The outside radius of this island shall be designed to accommodate the turning radius movement of a WB—40 vehicle (D.O.T.). Said island shall include on its outside radius a bituminous concrete berm of modified Cape Cod style or granite curbing.

Waiver Requested to allow the construction of the cul-de-sac with no center island.

OCTOBER 25, 2017

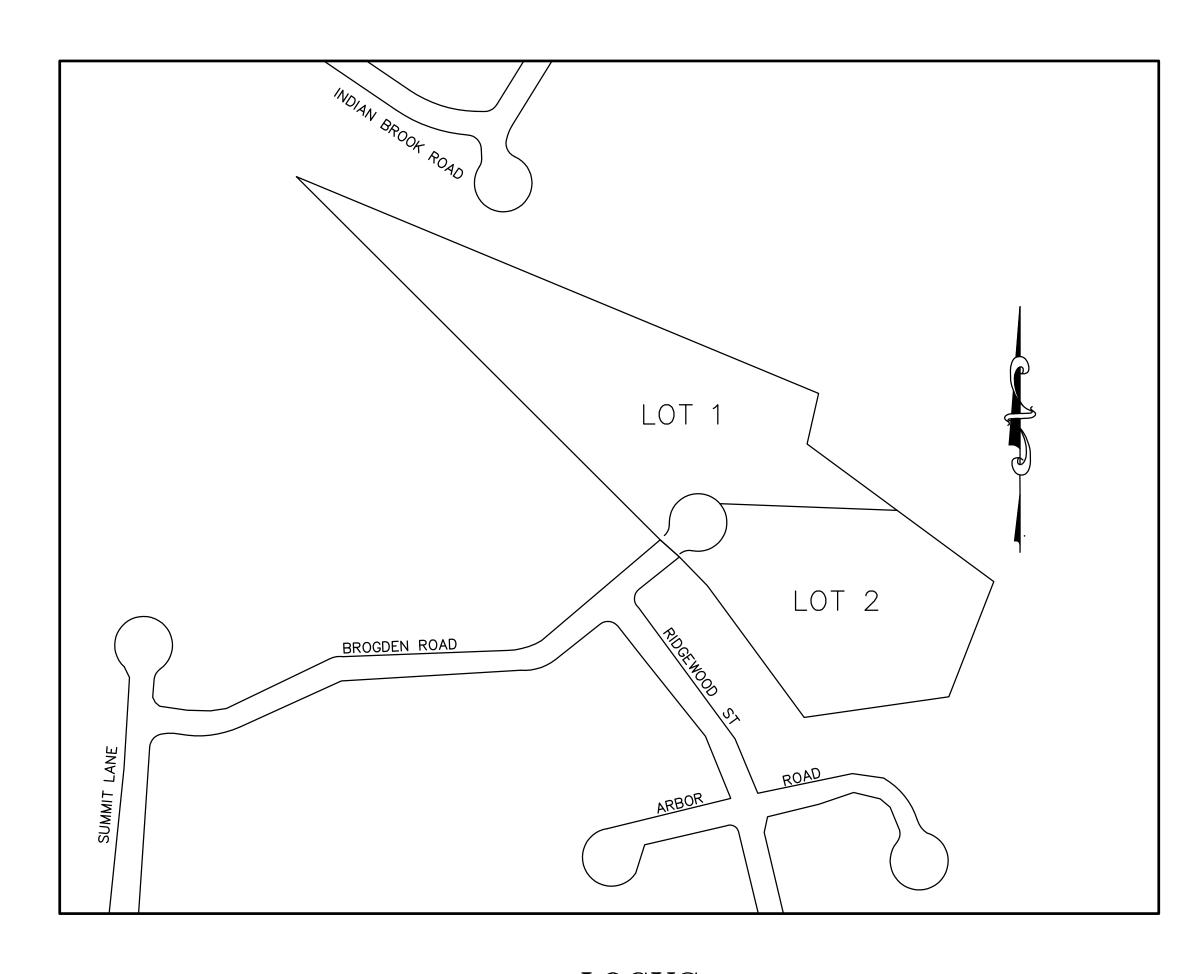

LOCUS
SCALE: 1"=200'

OWNER:
A & M Realty Trus
43 Ridgewood Stree
Ashland, MA 01721

<u>DEED REFERENCE:</u>
MIDDLESEX REGISTRY OF DEEDS
BOOK 69503, PAGE 534

<u>PLAN REFERENCE:</u>
MIDDLESEX REGISTRY OF DEEDS
1. FILED AS NO. 576 OF 2016

ASSESSORS REFERENCE MAP 18, PARCEL 180

ZONING CLASSIFICATION:
RESIDENCE A DISTRICT (RA
AREA: 30,000 S.F.
FRONTAGE: 150 FT.
SETBACKS:
FRONT: 40 FT.
SIDE: 10 FT.
REAR: 30 FT.

APPROVED BY TH ASHLAND PLANNII		
DATE APPROVED:		
DATE ENDORSED:		
BY	FORTH IN A DAT	SUBJECT TO ( COVENANT EXECUTE) IED GISTERED) HEREWITH.
	THE PLANNING ND NO APPEA 'S NEXT AFTE	G BOARD APPROVAL AL HAS BEEN TAKEN
TOWN CLER	'K	DATE
		ONFORMS TO THE HE REGISTER OF DEE
	L AND TECHN	ACCORDANCE WITH IICAL STANDARDS FO 'EYING IN THE

COMMONWEALTH OF MASSACHUSETTS

JOYCE E. HASTINGS P.L.S.

PREPARED BY:

GLM ENGINEERING CONSULTANTS, INC.
19 EXCHANGE STREET
HOLLISTON, MASSACHUSETTS 01746
(508)429-1100 fax:(508)429-7160

OWNER & APPLICANT:

A & M REALTY TRUST

43 RIDGEWOOD STREET

ASHLAND, MASSACHUSETTS 01721

SHEET INDEX

SHEET NO. DESCRIPTION

1 COVER SHEET
2 EXISTING CONDITIONS
3 LAYOUT PLAN (1"=40")
4 LAYOUT PLAN (1"=60")
5 GRADING, DRAINAGE & UTILITIES
6 PLAN AND PROFILE OF ROADWAYS
7 EROSION CONTROL PLAN
8 DETAILS

DETAILS

JOB No. 16130

SCALE: NO SCALE DATE:


PLAN SHEET NO.


DATE


1 of 9


AS NOTED


GLM PLAN NO. 27167

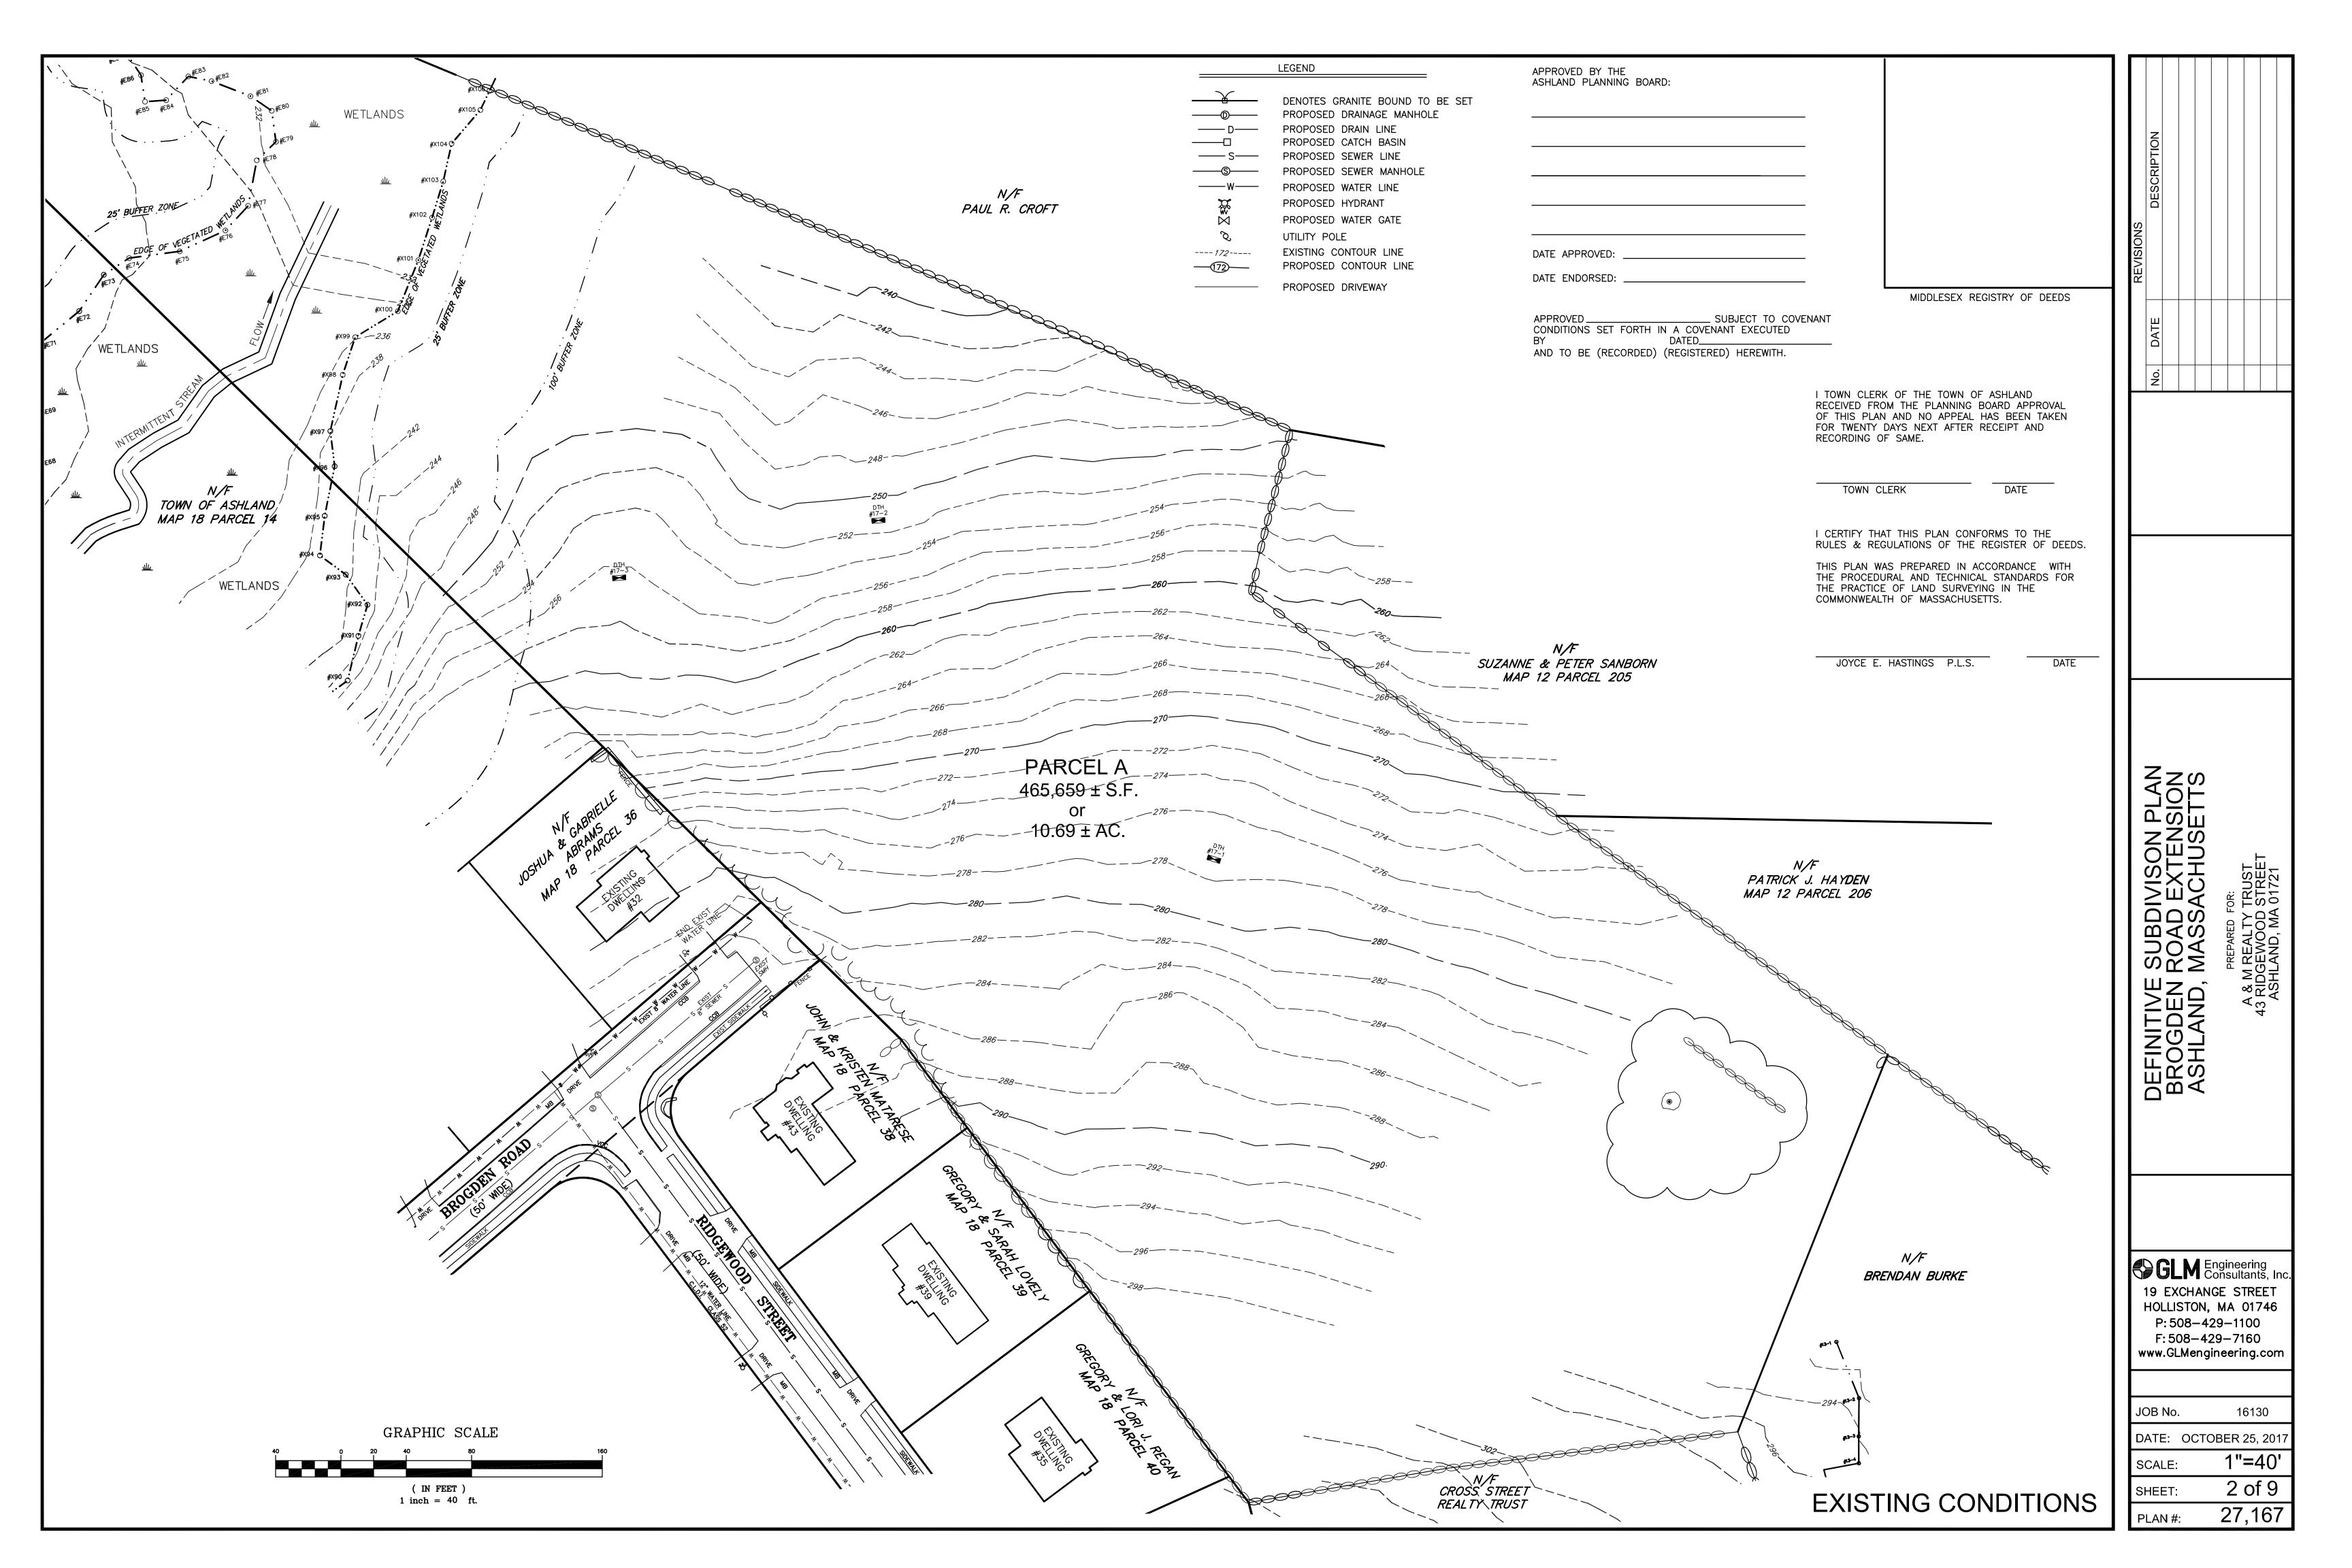


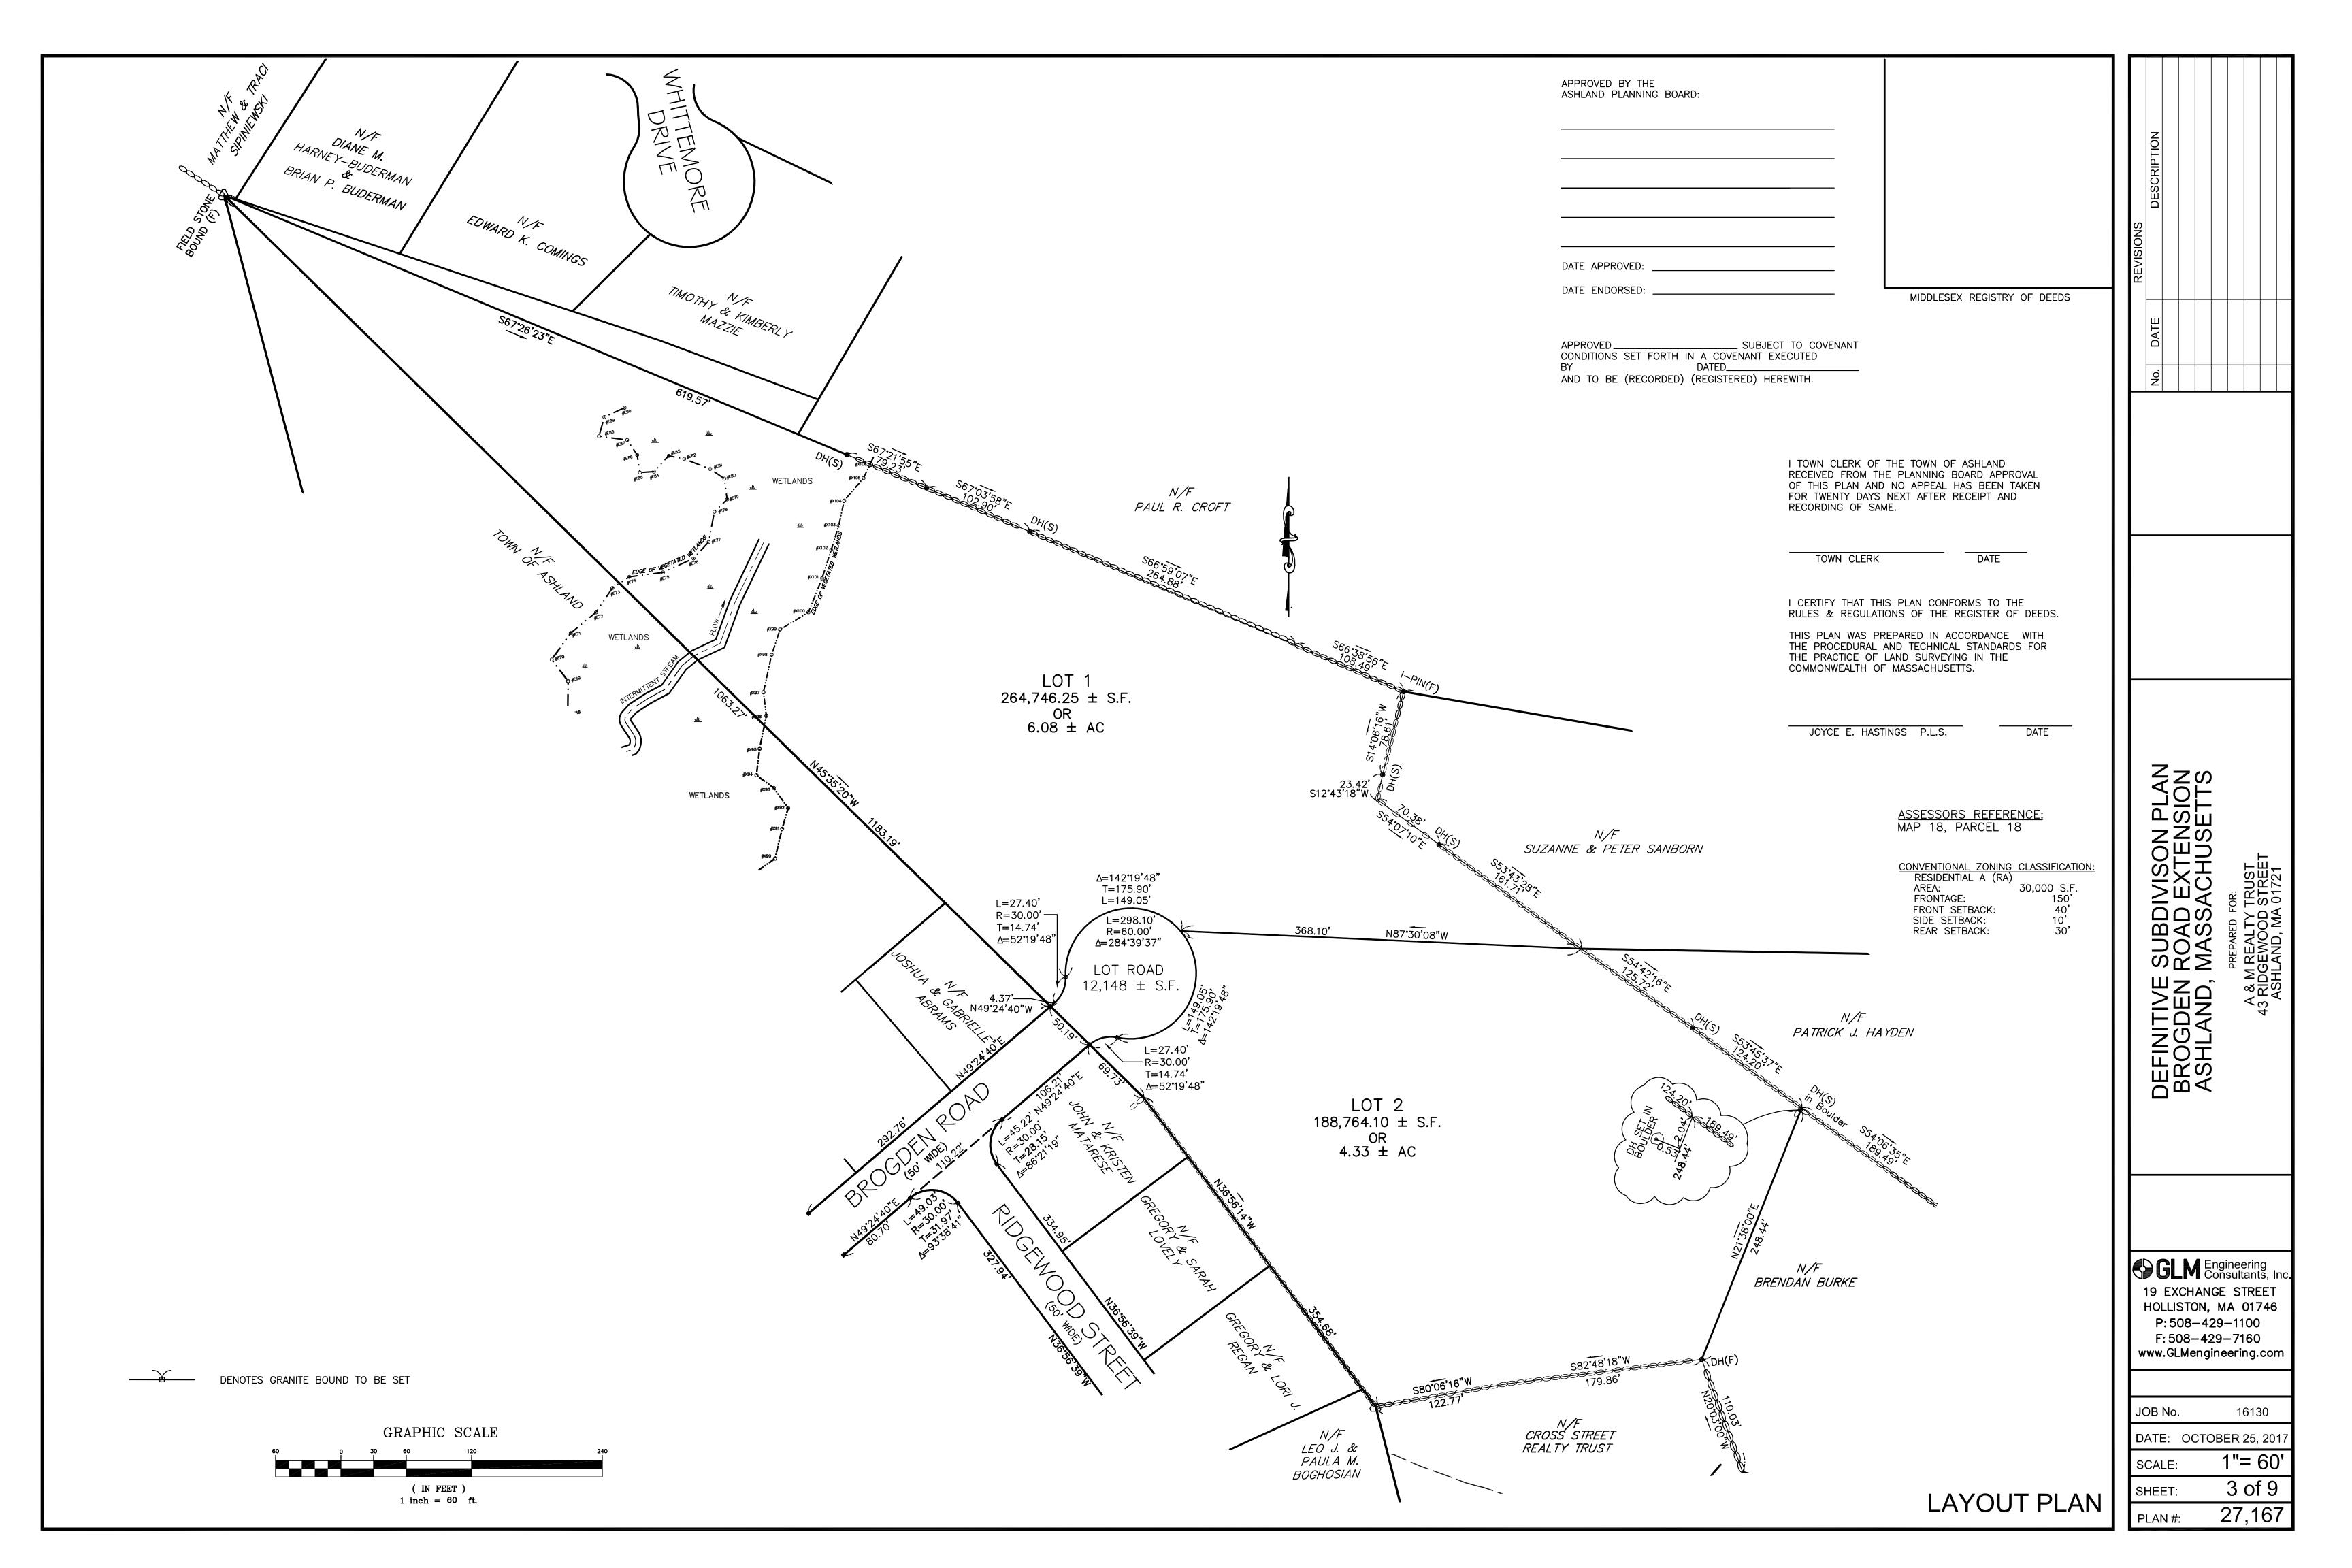


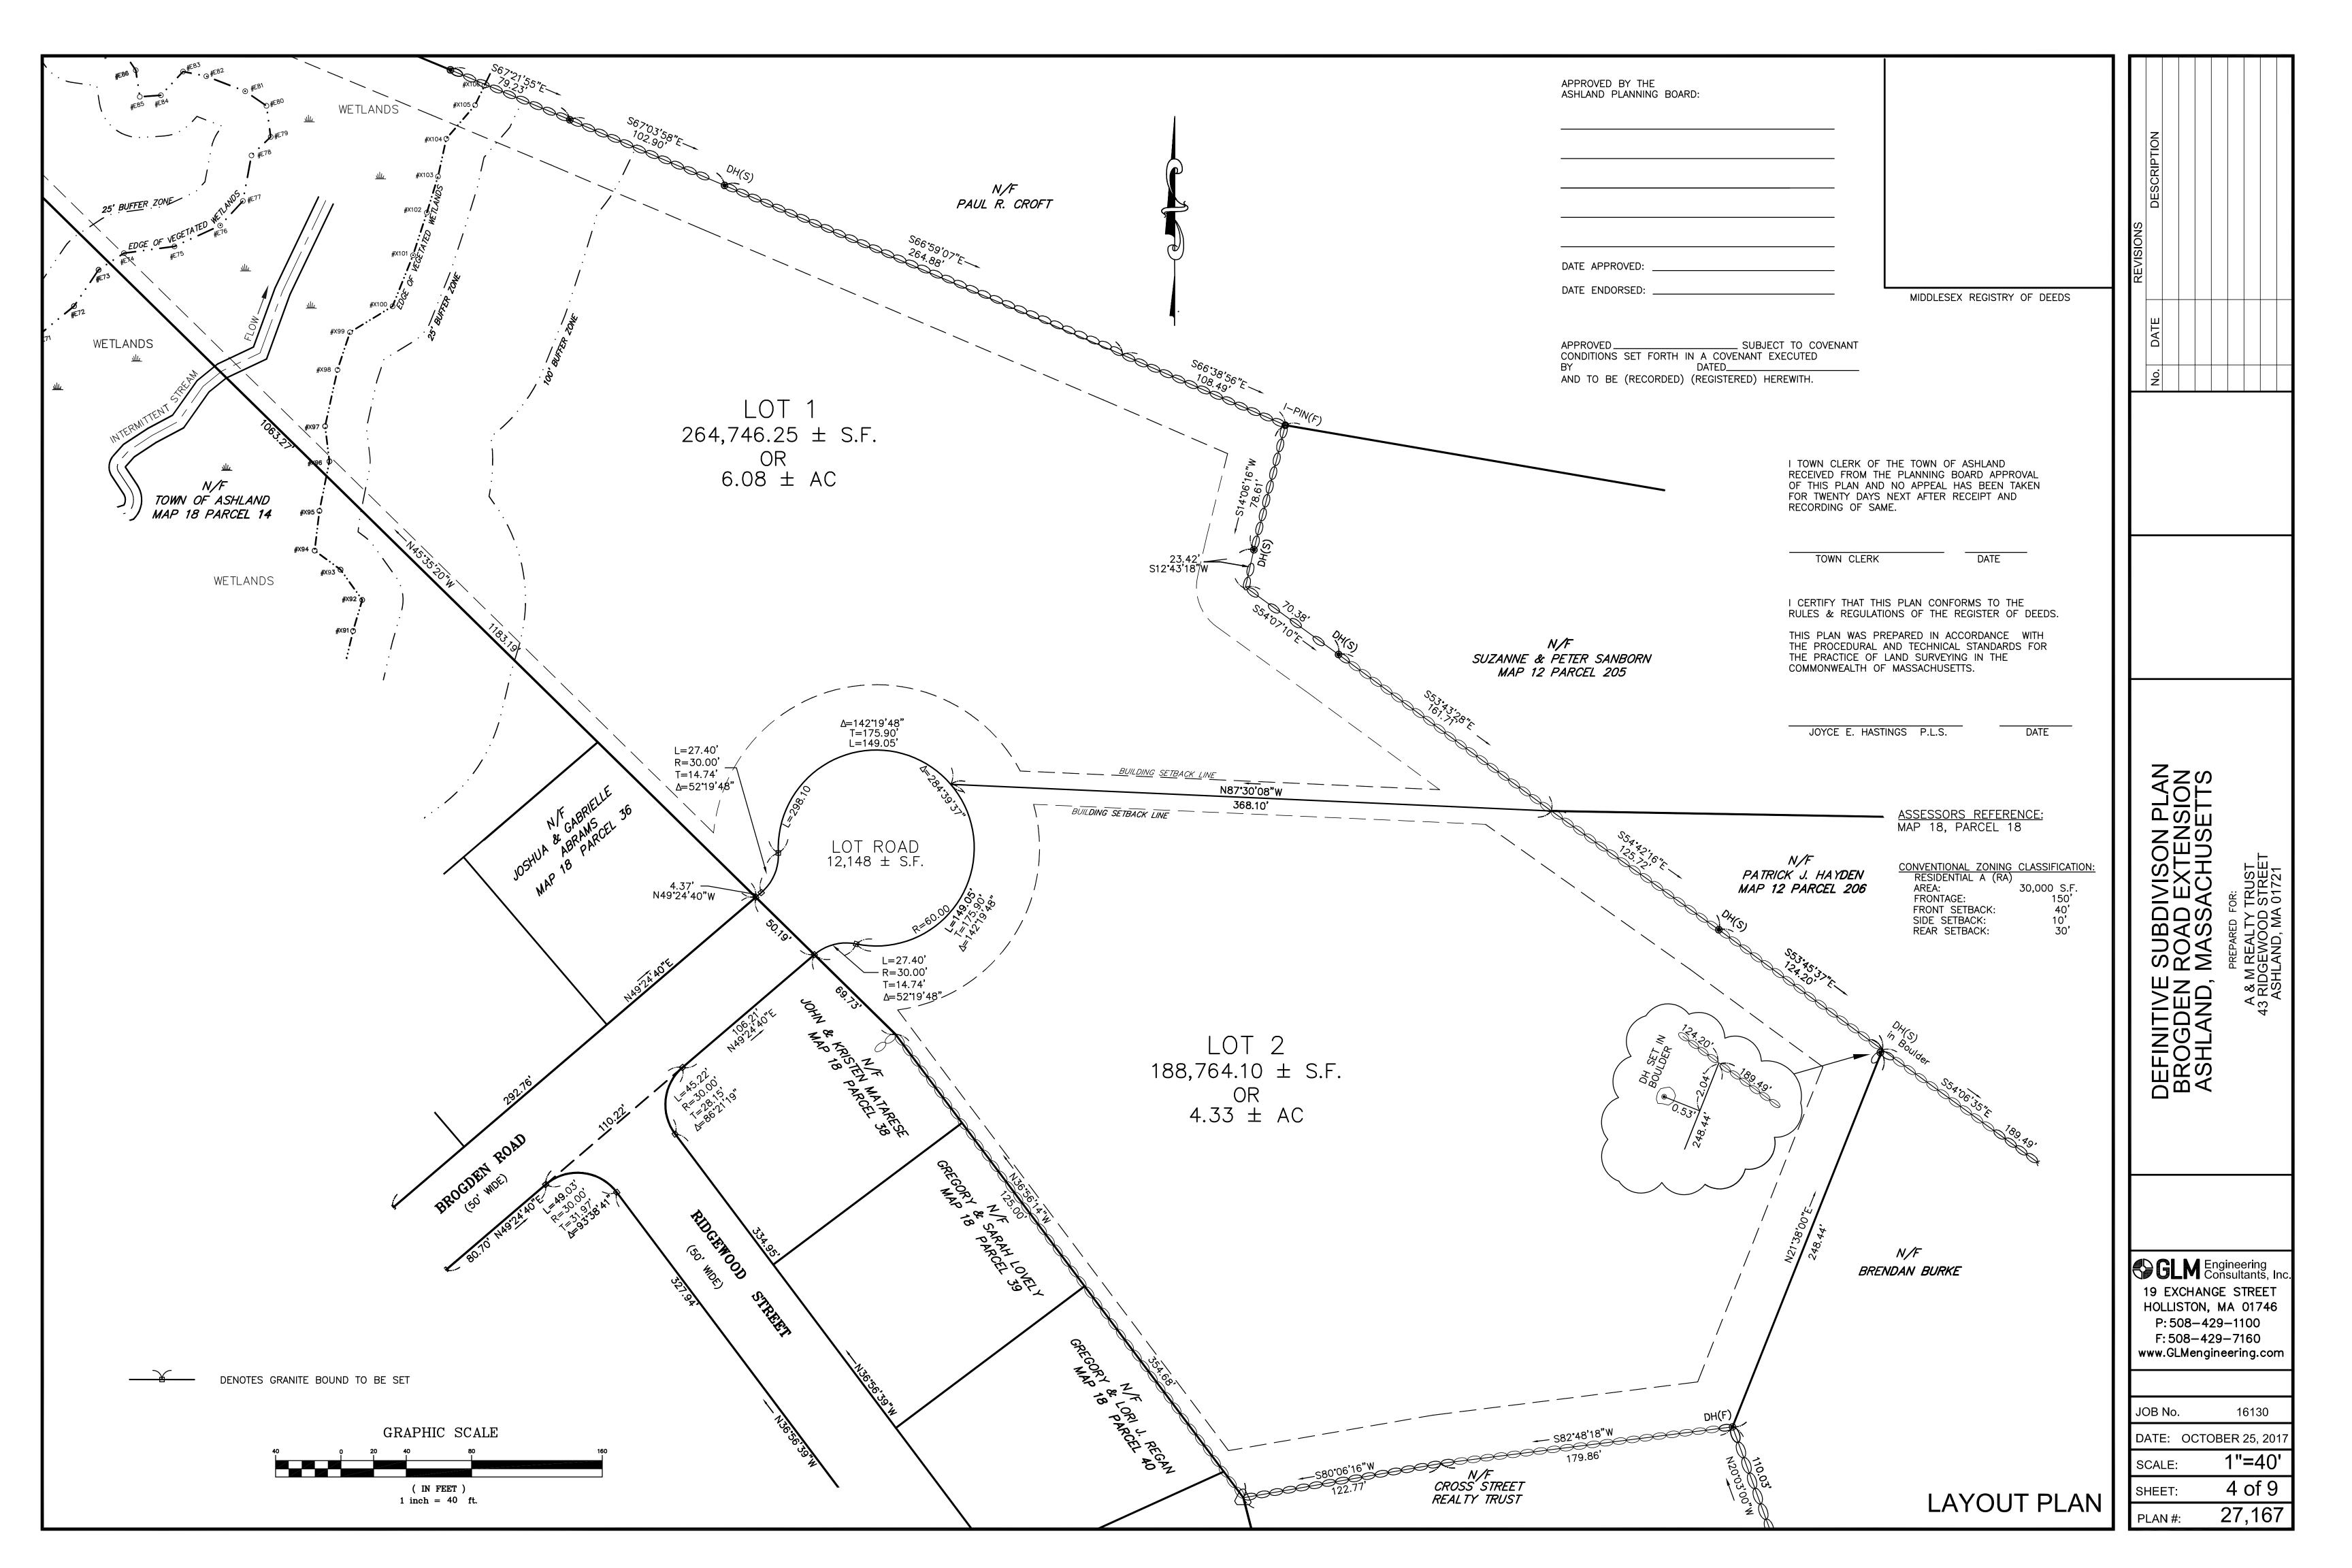

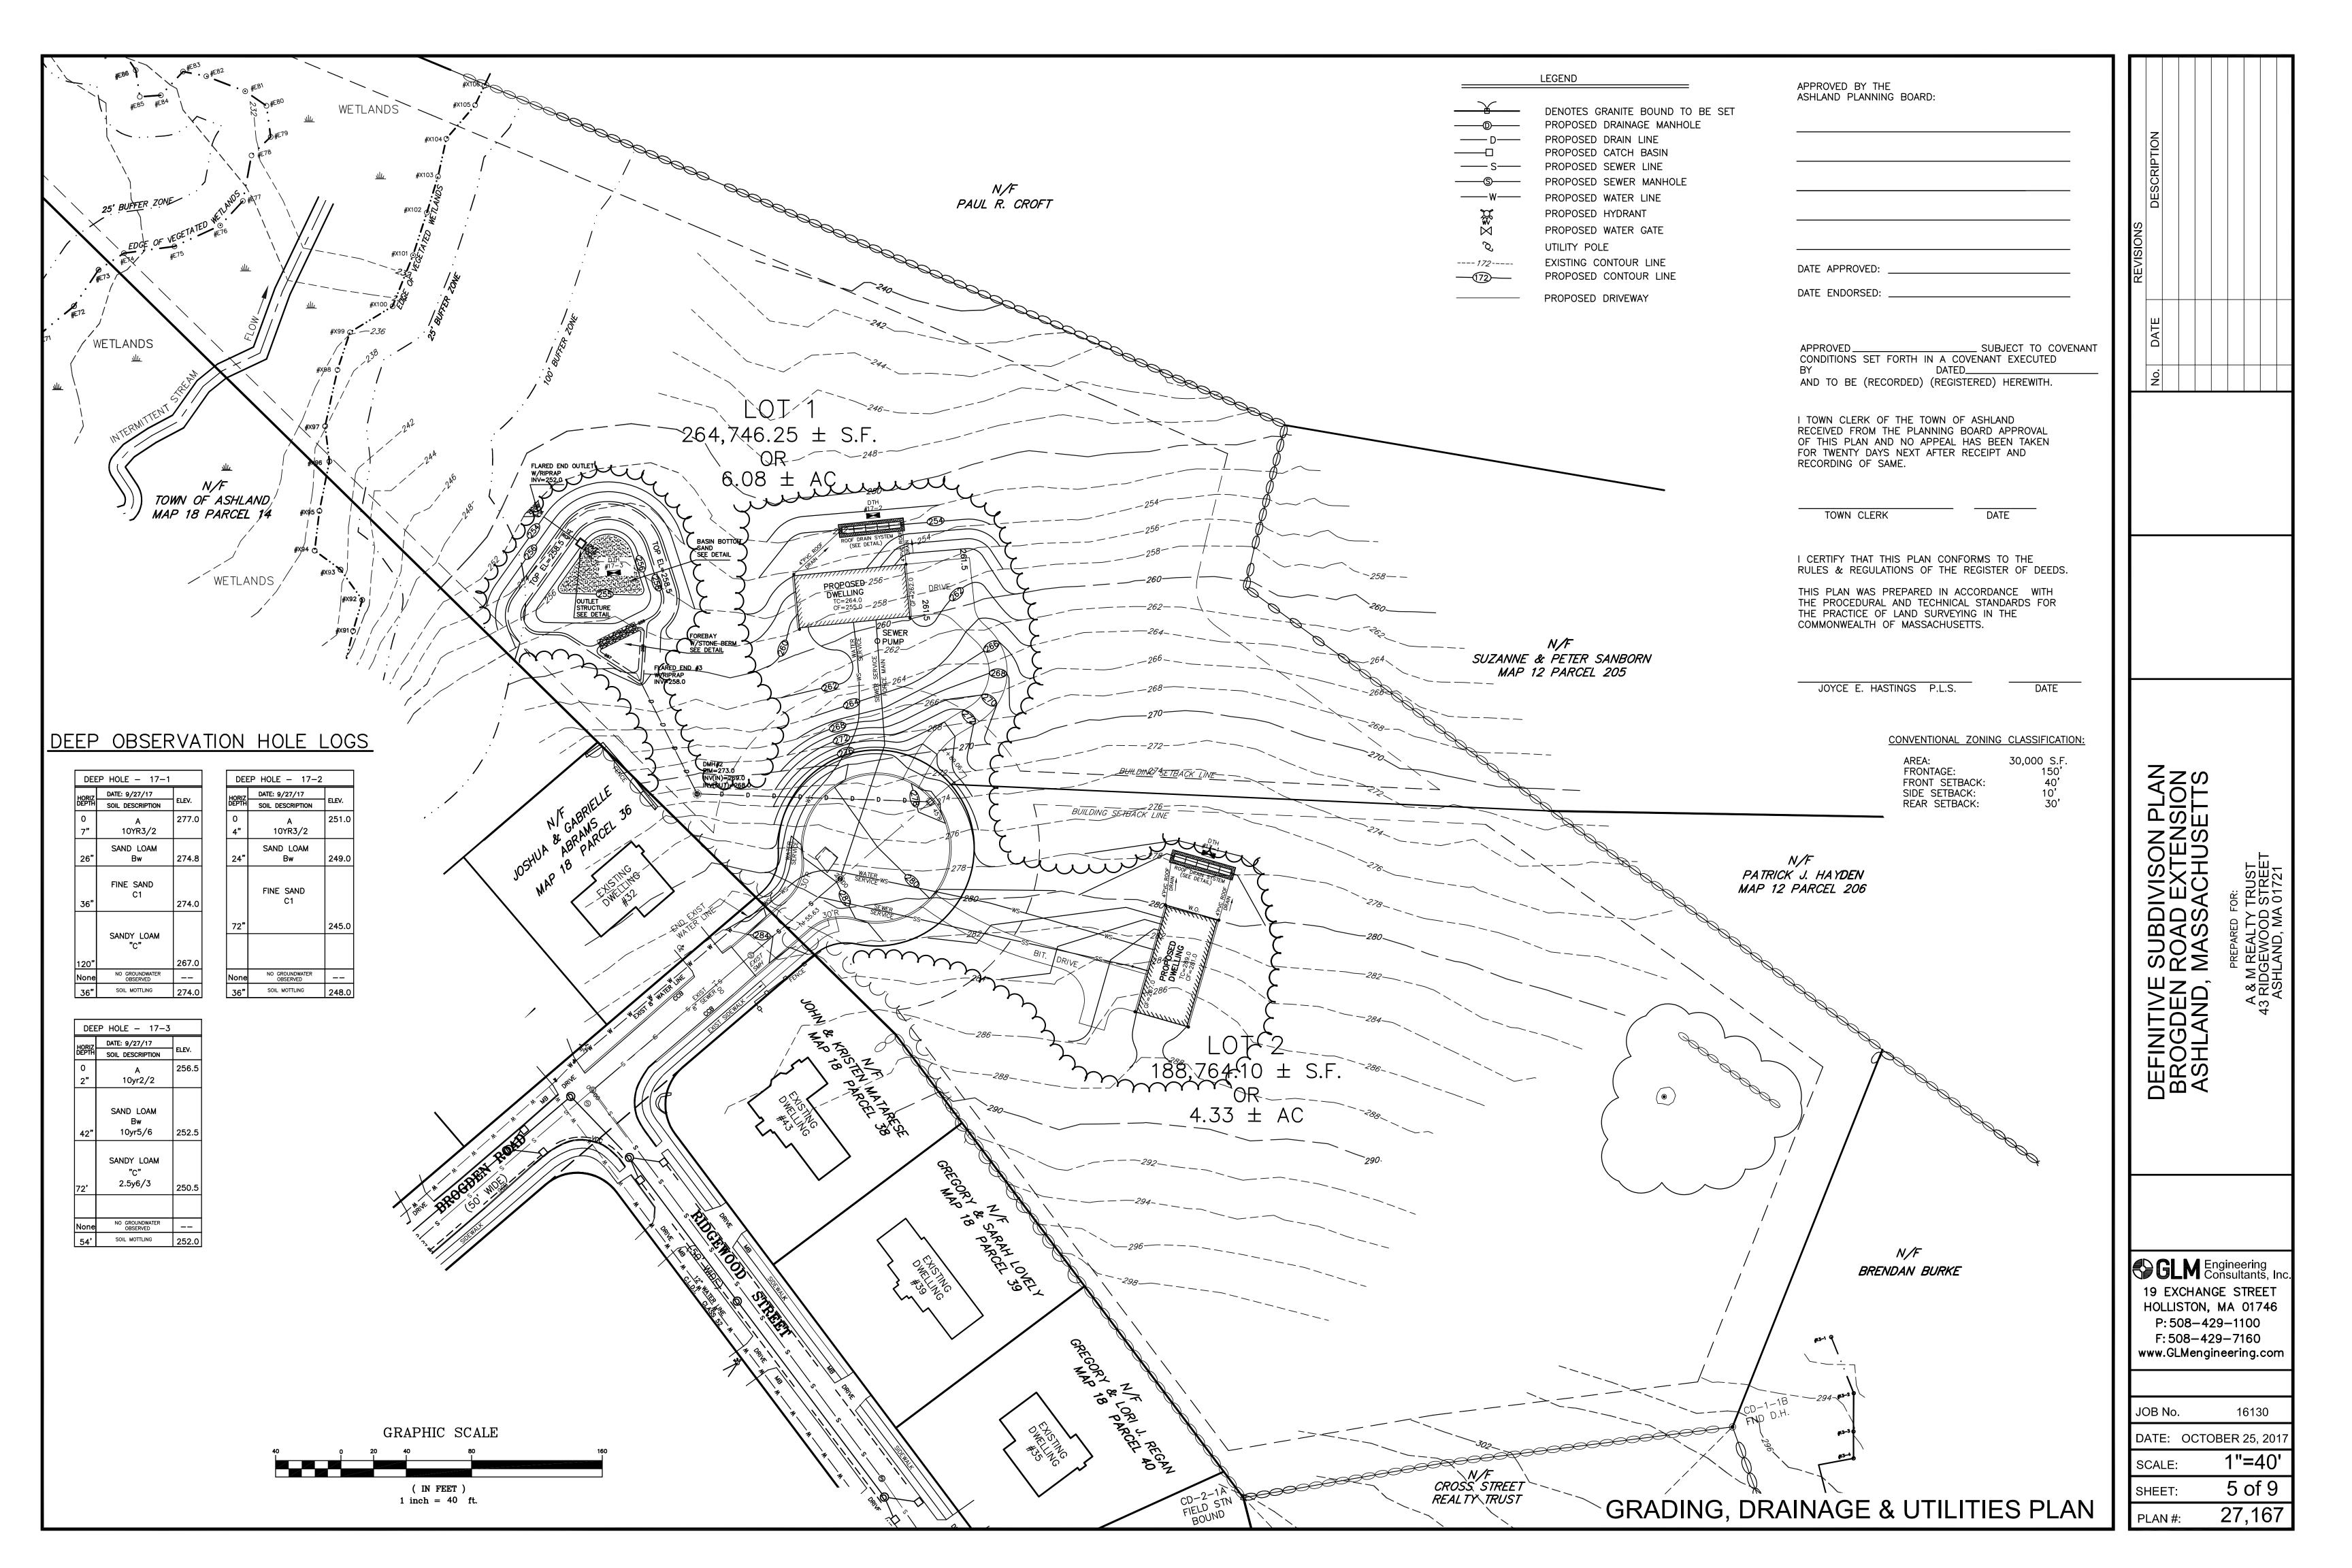

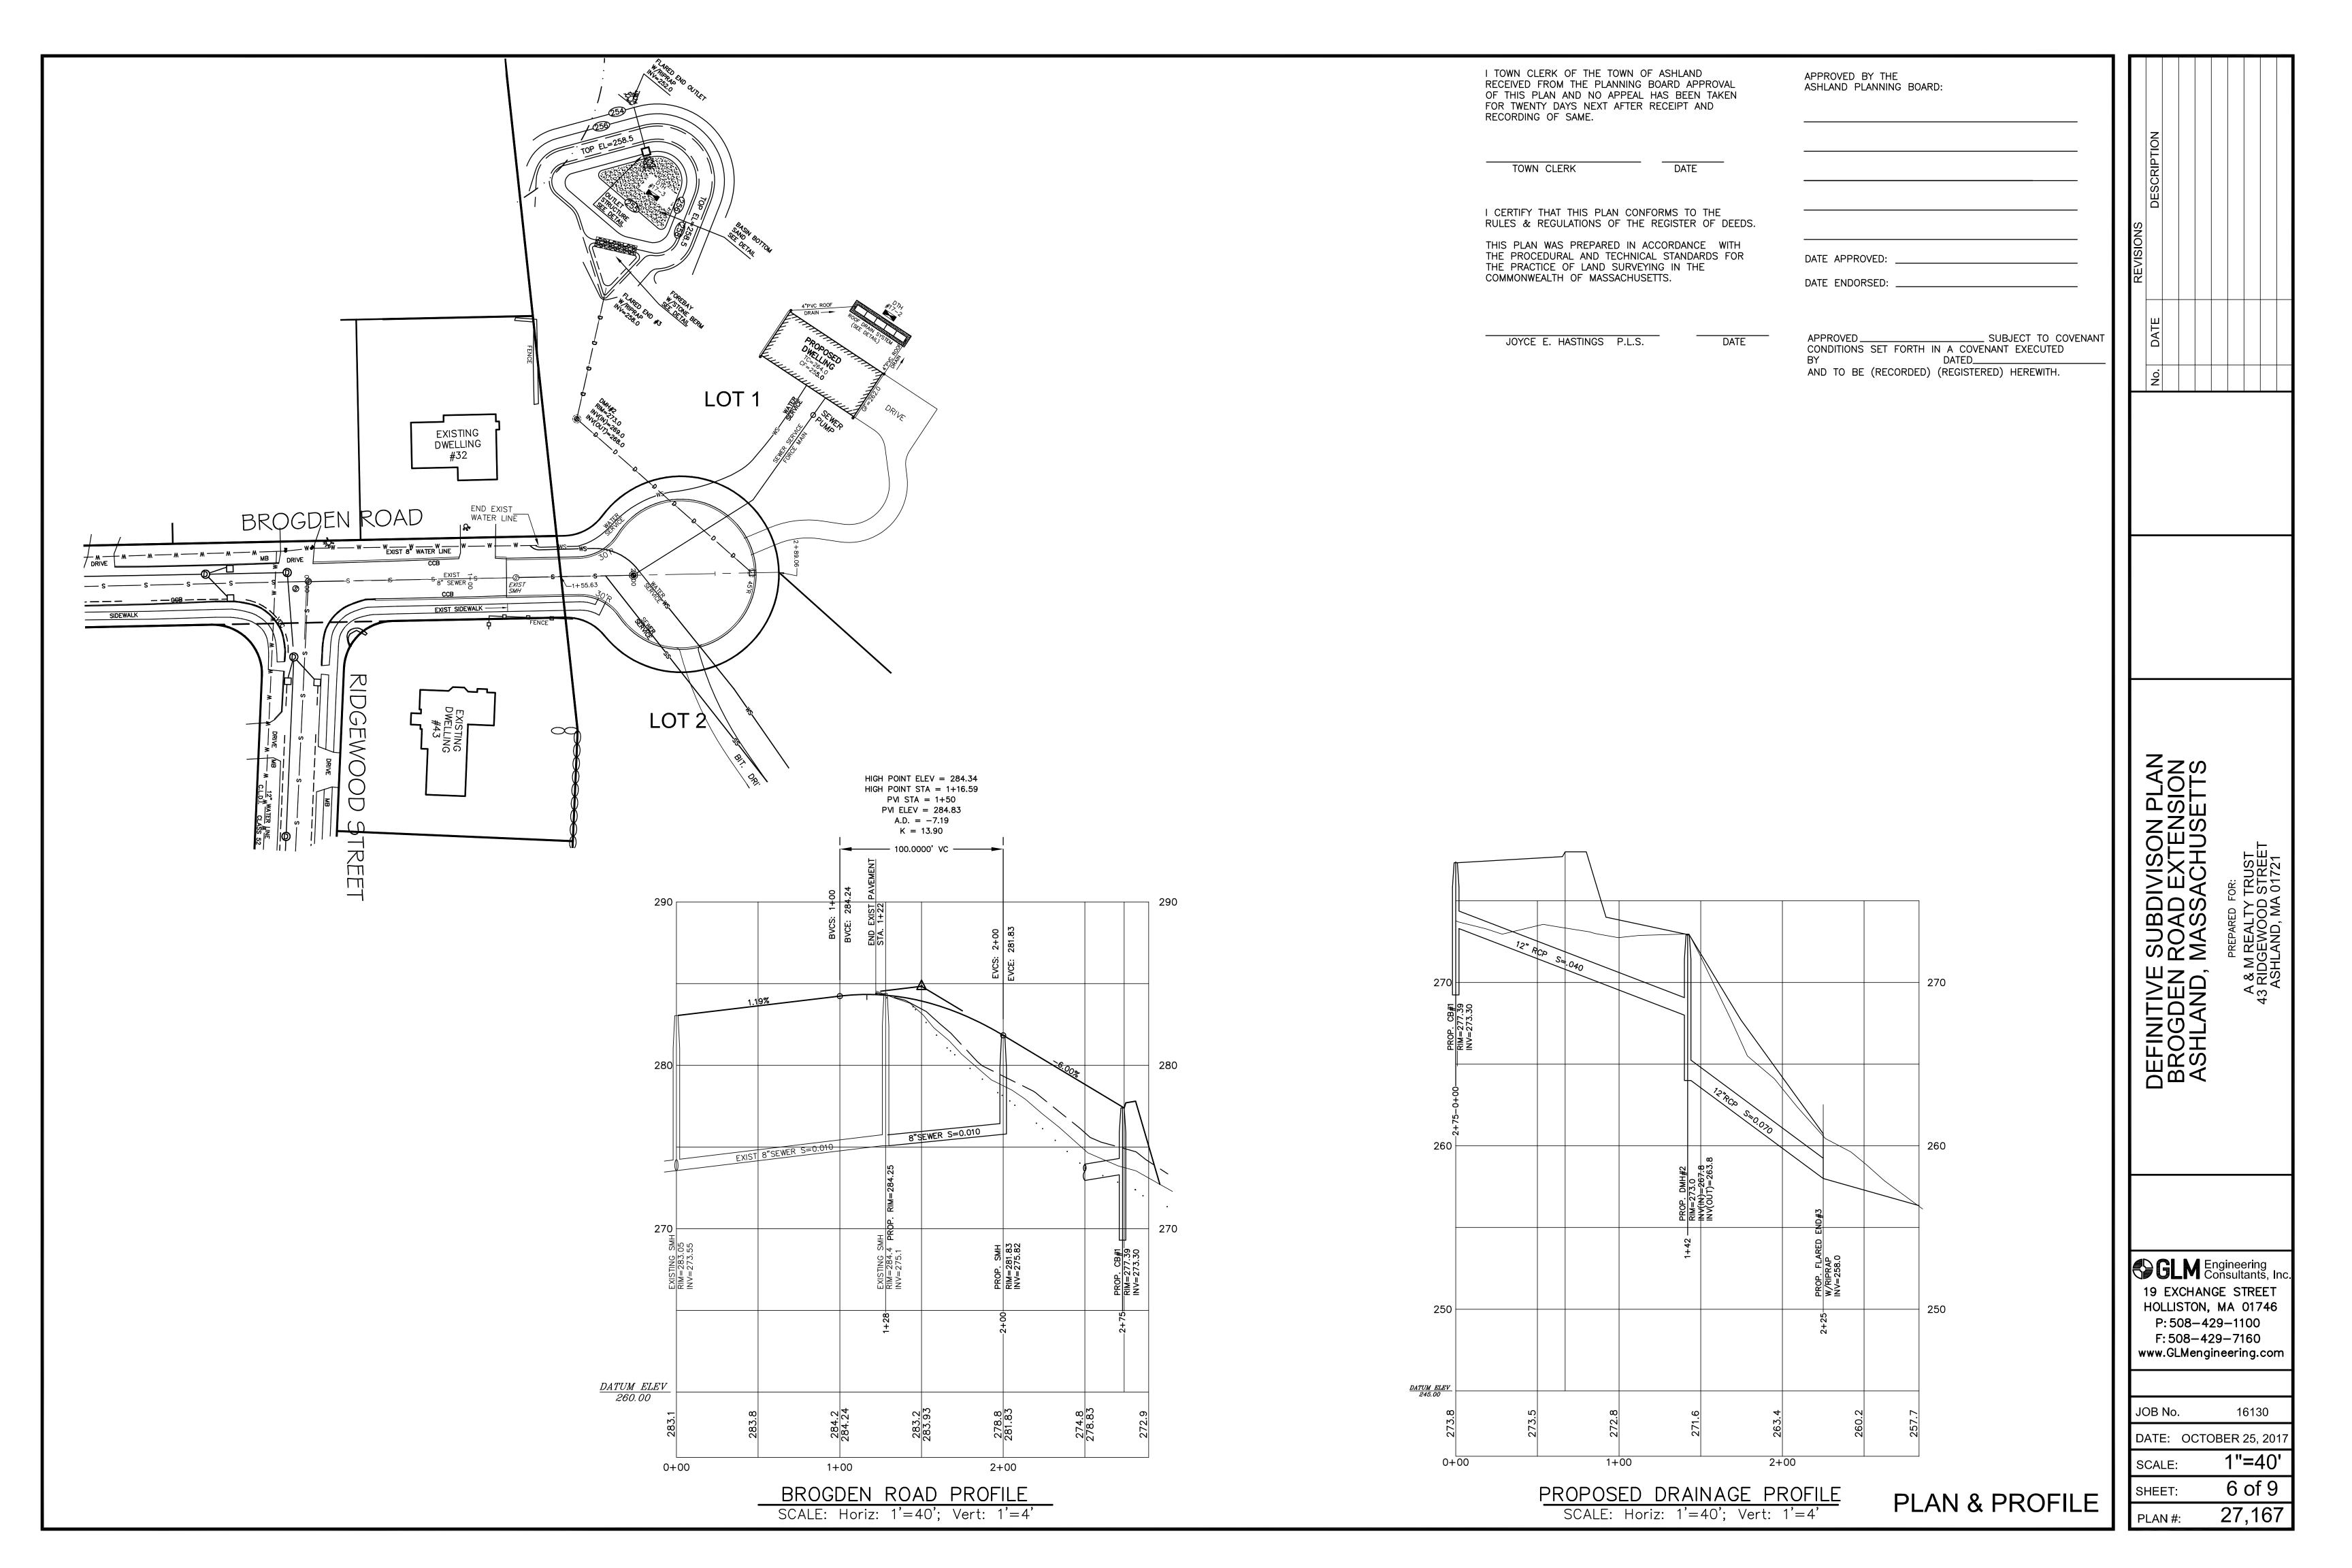

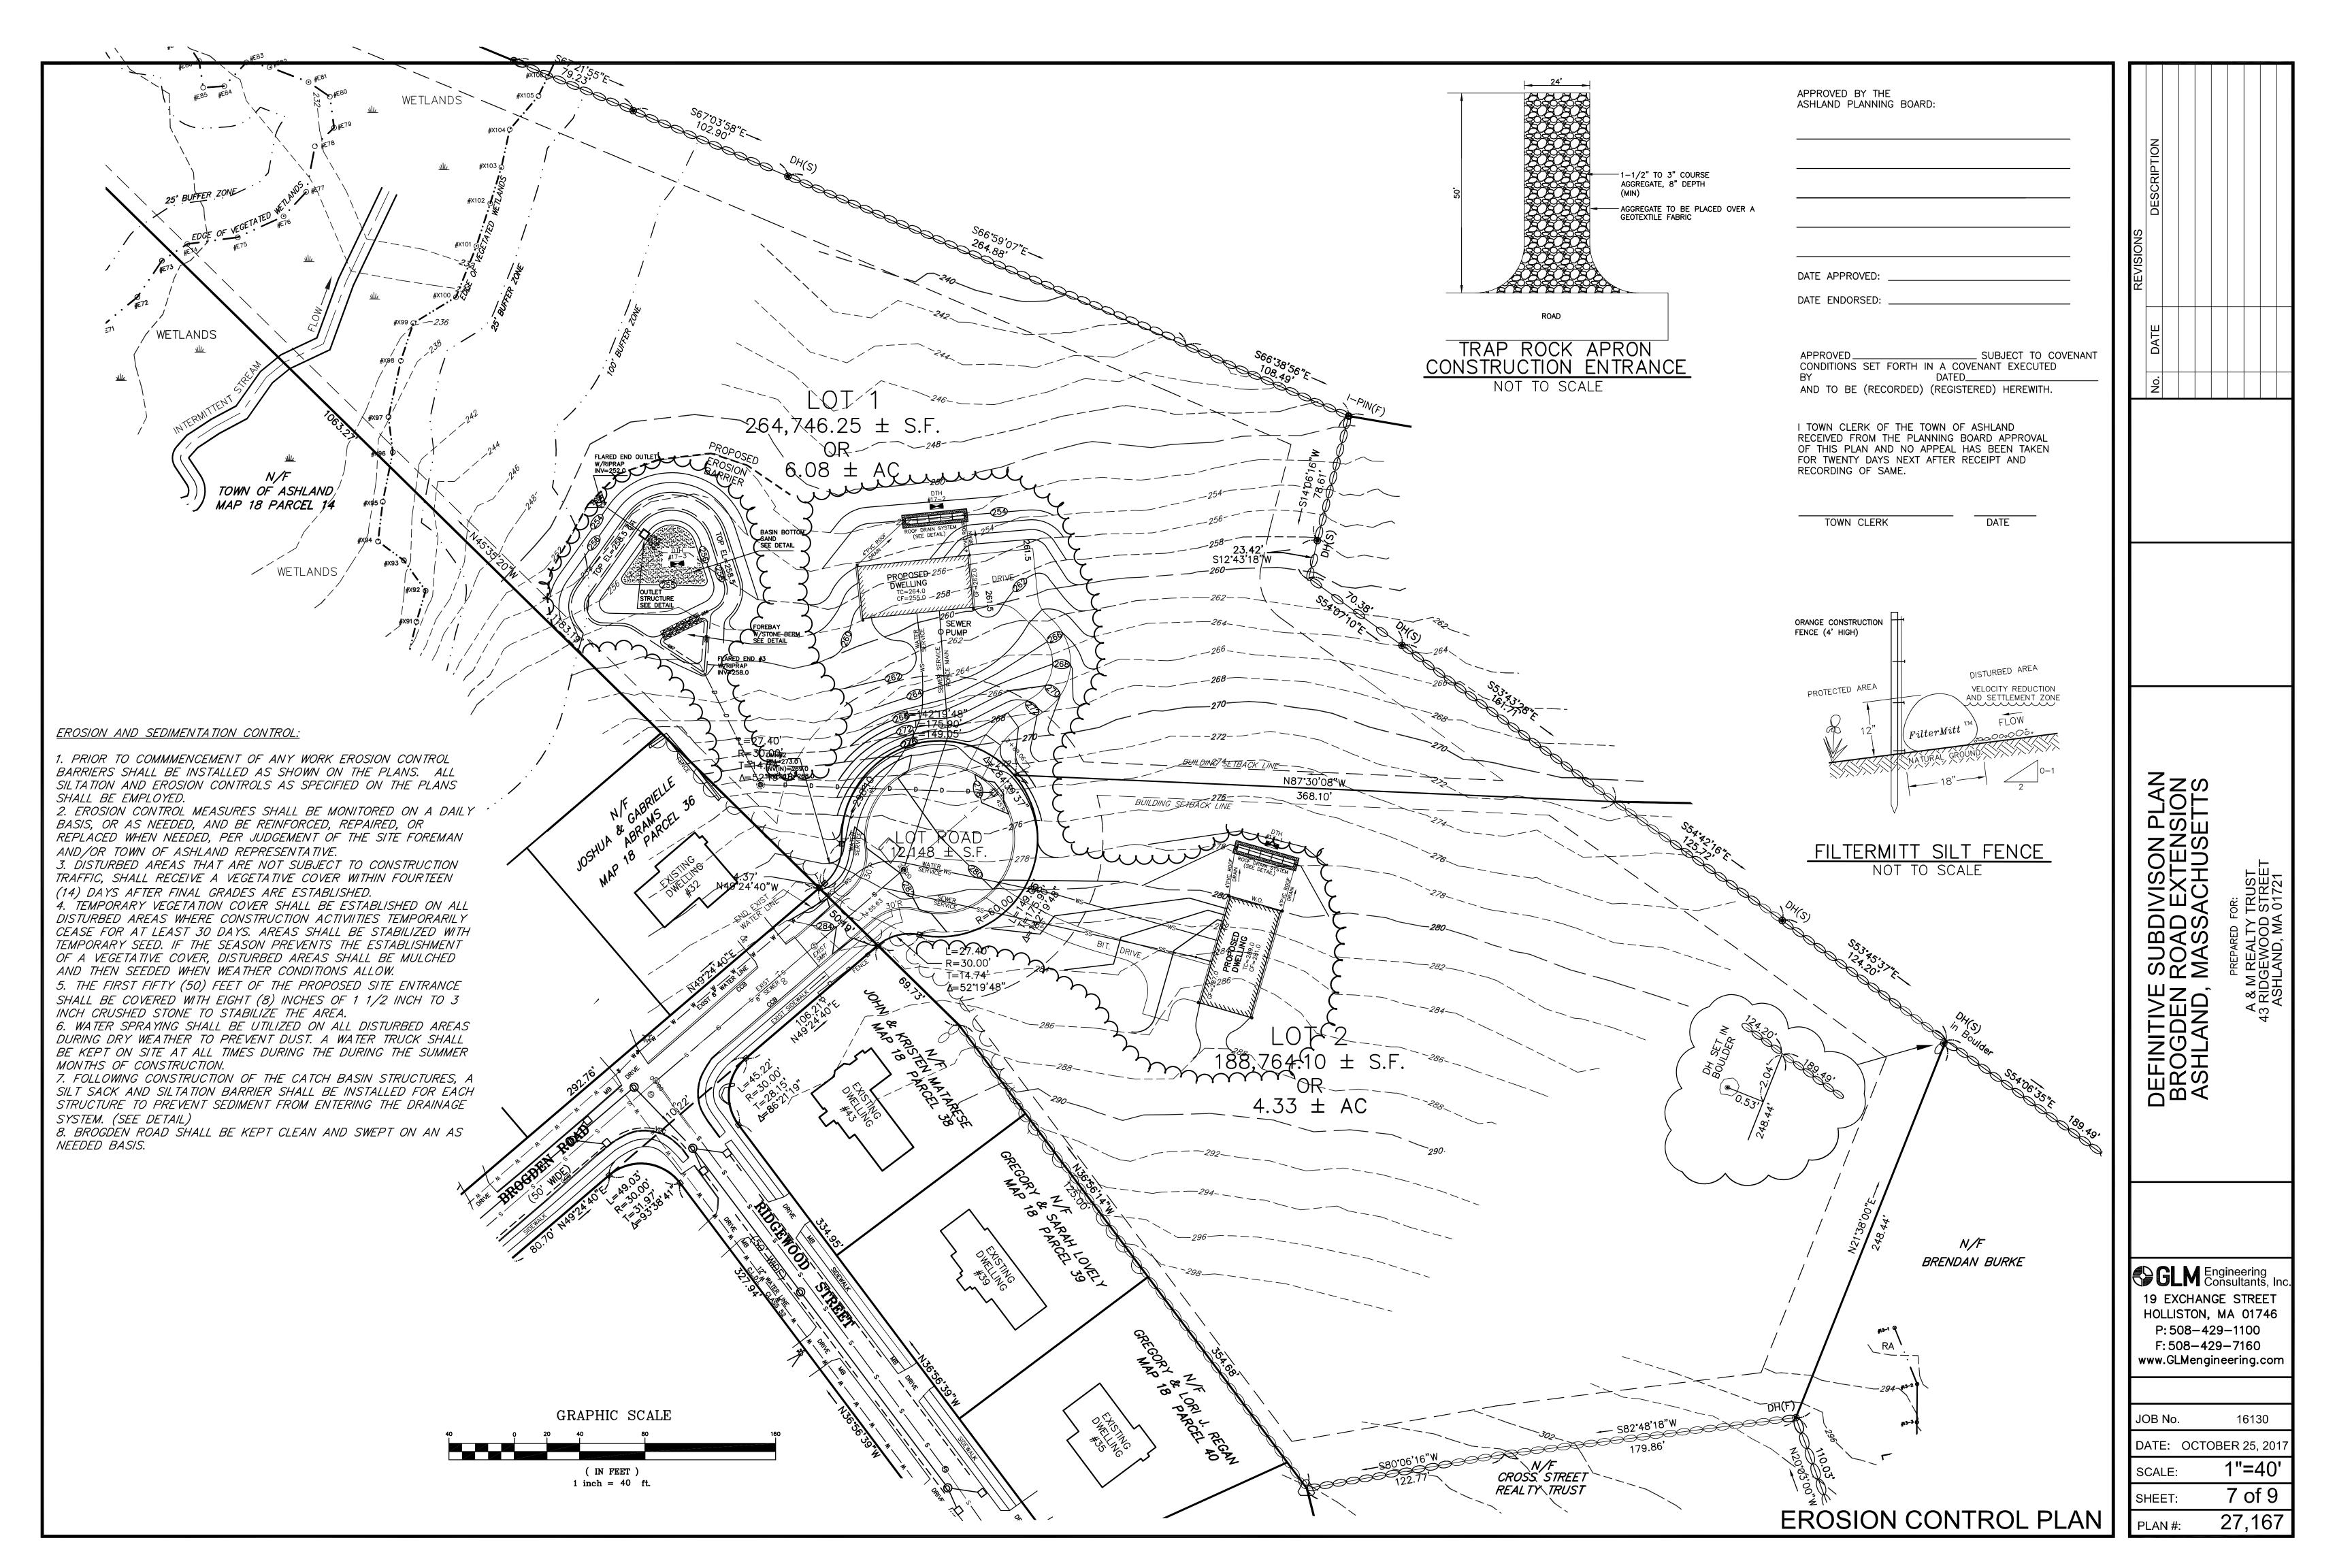

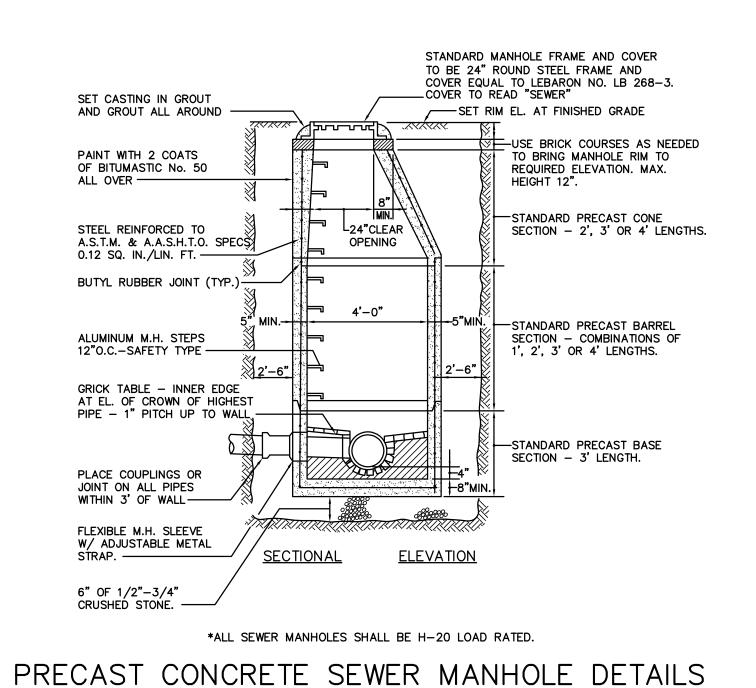

NOT TO SCALE

CURB STOP AND 2.5" BUFFALO

STEET

CORPORATION COCK OR STOP

1" CORP. MUST BE DIRECT TAP-

ALL WATER SERVICES ARE TO BE SLEEVED UNDER THE ROADWAY AND

SPEC. AND BE 200 PSI (MIN.)

AND 244-444) W/ NO DRAIN.

PLASTIC 200 PSI TUBING SHALL MEET AWWA

ANY SERVICES OVER 125 FEET IN LENGTH

1.5" AND LARGER SERVICES ARE REQUIRED

CURB STOPS MUST MEET AWWA SPEC. 800-55 (HAYS 5045 OR FORD 244-333

CORPORATION STOP SHALL MEET AWWA

SPECS. (MUELLER B-25008 OR FORD

ALL PAVED SURFACES.

SHALL BE 1-1/2" PIPE

TO HAVE A SADDLE.

F-1000 G)

CC THREAD X FLARED

OR NE STYLE 95E 5.5" CURB BOX.

EDGE OF ROADWAY LAYOUT -----

SERVICE OR CURB BOX-

6" CLEAN
WASHED SAND


TUBING WITH FLARED FITTINGS

AND/OR MUELLER COMPRESSION FITTINGS WITH STAINLESS

SERVICE PIPE OR STOP

1" 200 PSI PE3406 PLASTIC

FINISHED GRADE

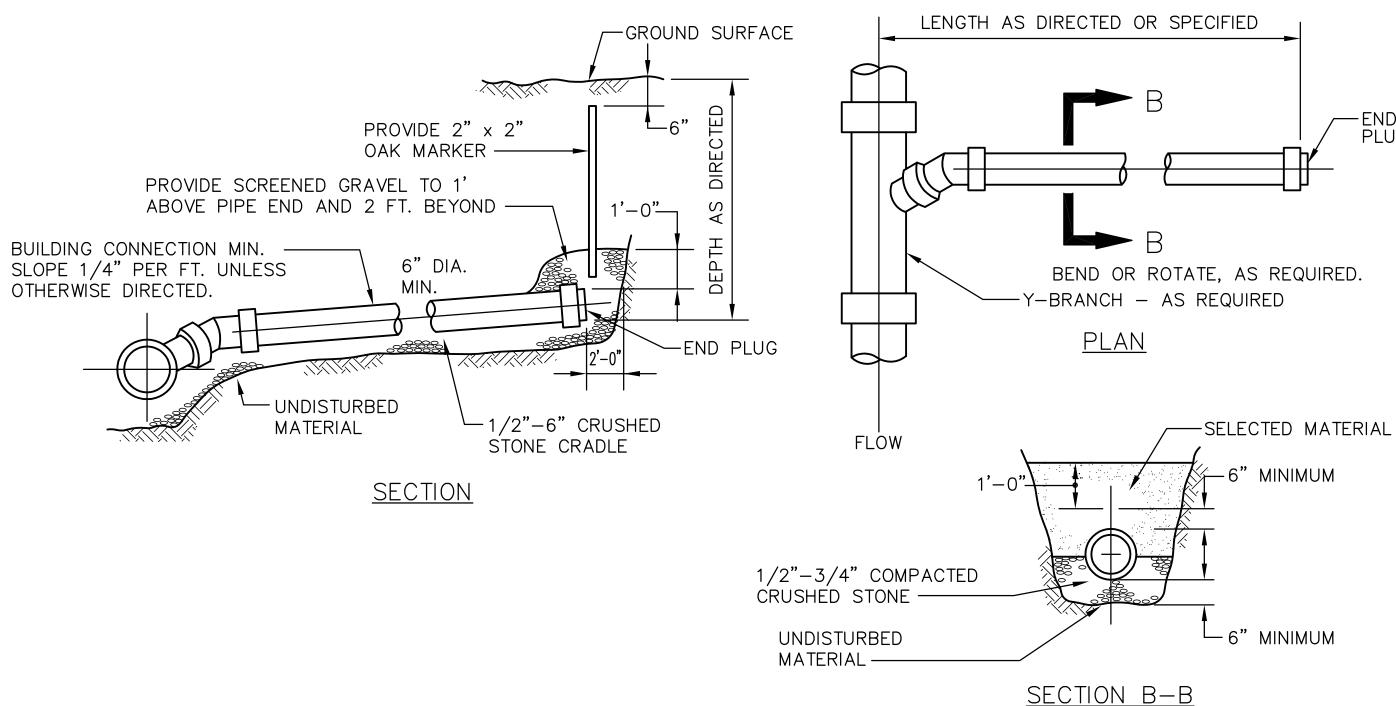



NOT TO SCALE


PLUG RESTAINED TO

FRICTION CLAMP OR

EQUAL

- CONCRETE BACKING AGAINST UNDISTURBED MATERIAL

GROUND SURFACE

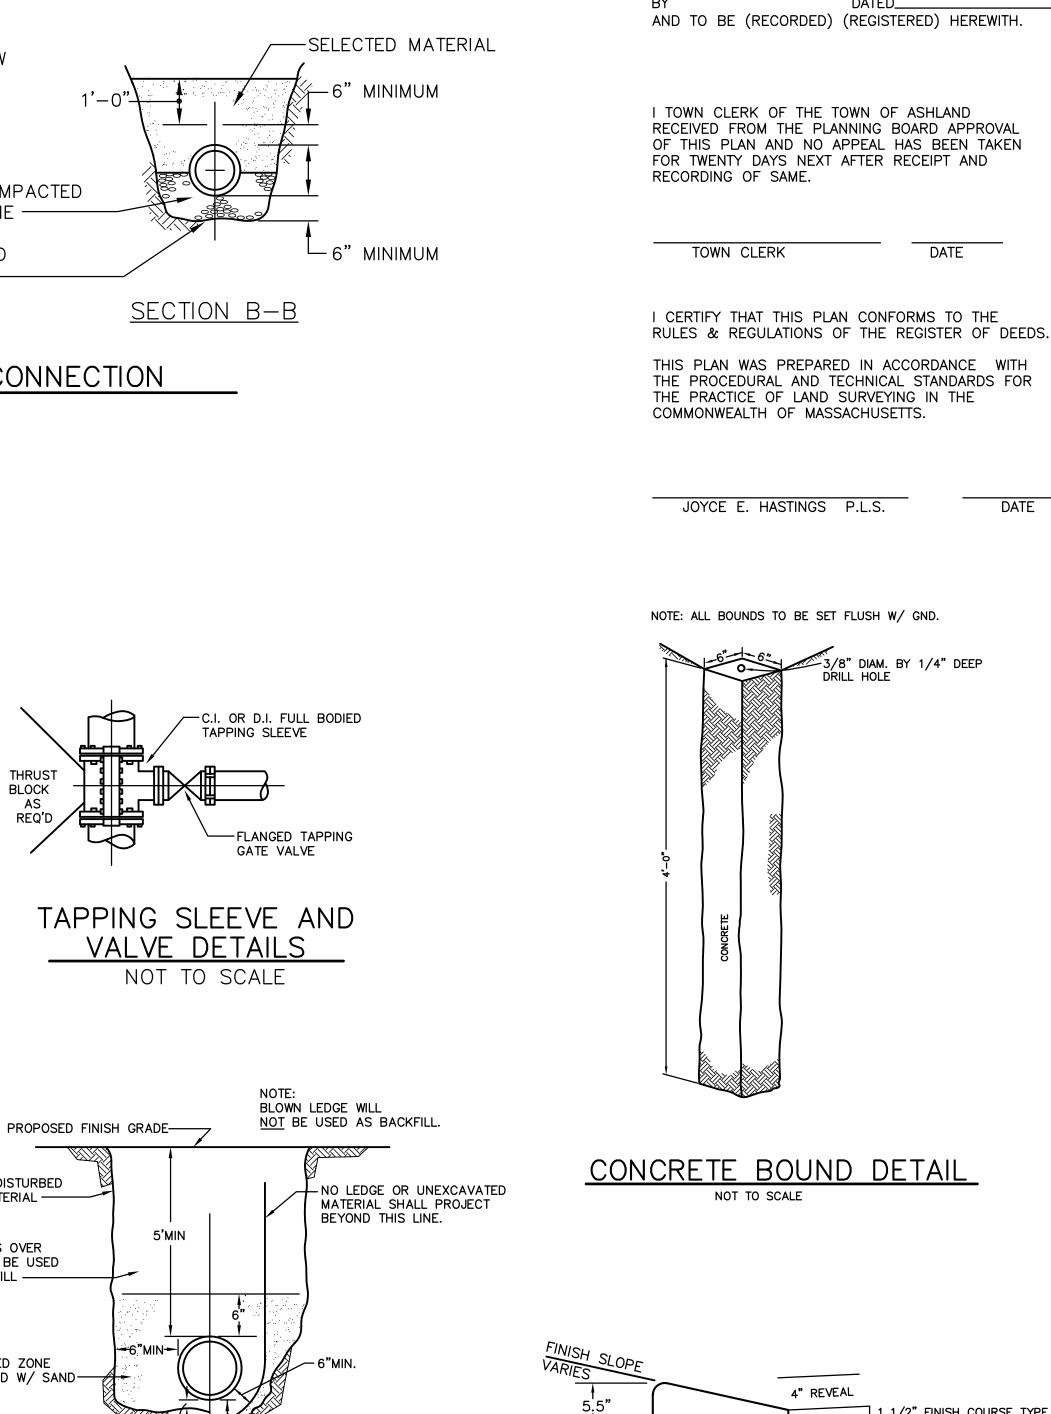

APPROVED BY THE

DATE APPROVED:

DATE ENDORSED

APPROVED.

CONDITIONS SET FORTH IN A COVENANT EXECUTED

SUBJECT TO COVENANT

ASHLAND PLANNING BOARD:



REMOTE READER HEIGHT = 3' MIN - 5' MAX

FOUNDATION WALL CLOSEST TO TAP

---BLUE TRACER TAPE MARKED "CAUTION WATER LINE BELOW" MUST BE PLACED TWO FEET BELOW FINISHED GRADE IN THE WATER-SERVICE TRENCH TO EACH


—BALL VALVE

-BASEMENT FLOOR


RESIDENCE AND TIED TO THE SERVICE BOX.

TAILPIECE (SPUD CONNECTOR)

TO HOUSE AND BADGER (OR EQUIVALENT)
REMOTE METER WITH CU. FT. OUTSIDE
READER CALIBRATED AND SEALED BY DPW
WATER DIVISION.

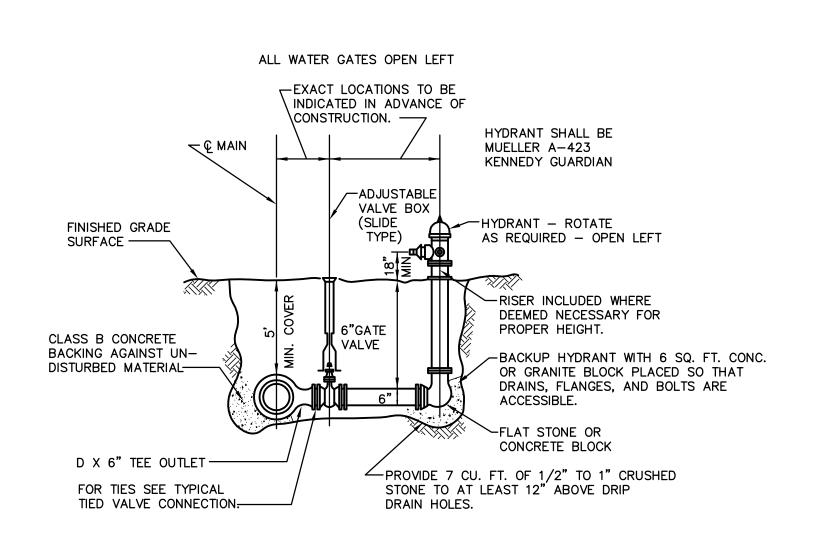

TYP. HYDRANT ASSEMBLY DETAIL NOT TO SCALE

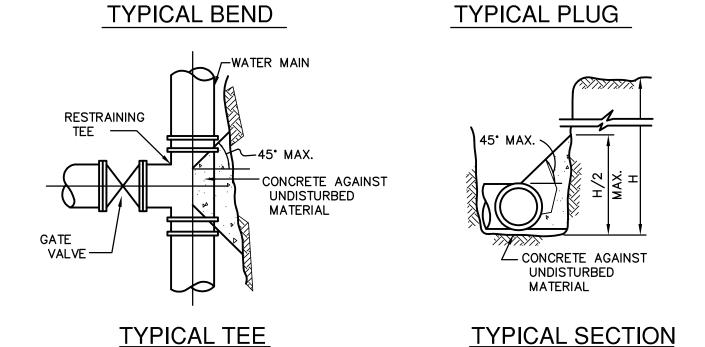


-CONCRETE AGAINST

UNDISTURBED MATERIAL


NOTE: CONCRETE FOR THRUST BLOCKS SHALL BE NO LONGER THAN THE RATIO OF 2 1/2 : 5 1/2 AND SHALL HAVE A MINIMUM COMPRESSION STRENGTH OF 2000 PSI (SO THAT FLANGES AND BOLTS ARE ACCESSIBLE.)

BEARING AREAS OF THRUST BLOCKS (BEARING AREA IN SQUARE FT.)					
PIPE SIZE INCHES	1/4 BEND	1/8 BEND	1/16 BEND OR LESS	PLUG TEES	
6 AND 8	8	8		8	
10 AND 12	22	13	8	16	

TYP. THRUST BLOCK DETAIL

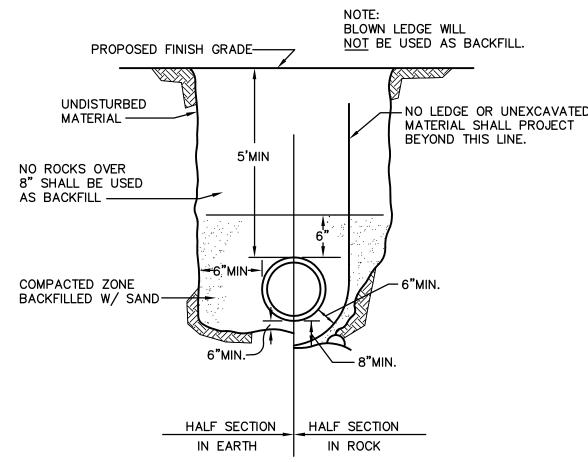

WATER MAIN TRENCH DETAIL NOT TO SCALE

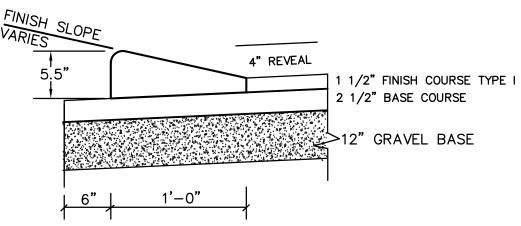

CAPE COD BERM DETAIL NOT TO SCALE


**DETAIL** 

SUBDIVISOR ROAD EXT DEFINITIVE BROGDEN F ASHLAND, I

GLM Engineering Consultants, Inc 19 EXCHANGE STREET HOLLISTON, MA 01746 P: 508-429-1100 F: 508-429-7160 www.GLMengineering.com

16130 DATE: OCTOBER 25, 2017 SCALE: AS SHOWN

8 of 9 SHEET: 27,167 PLAN #:

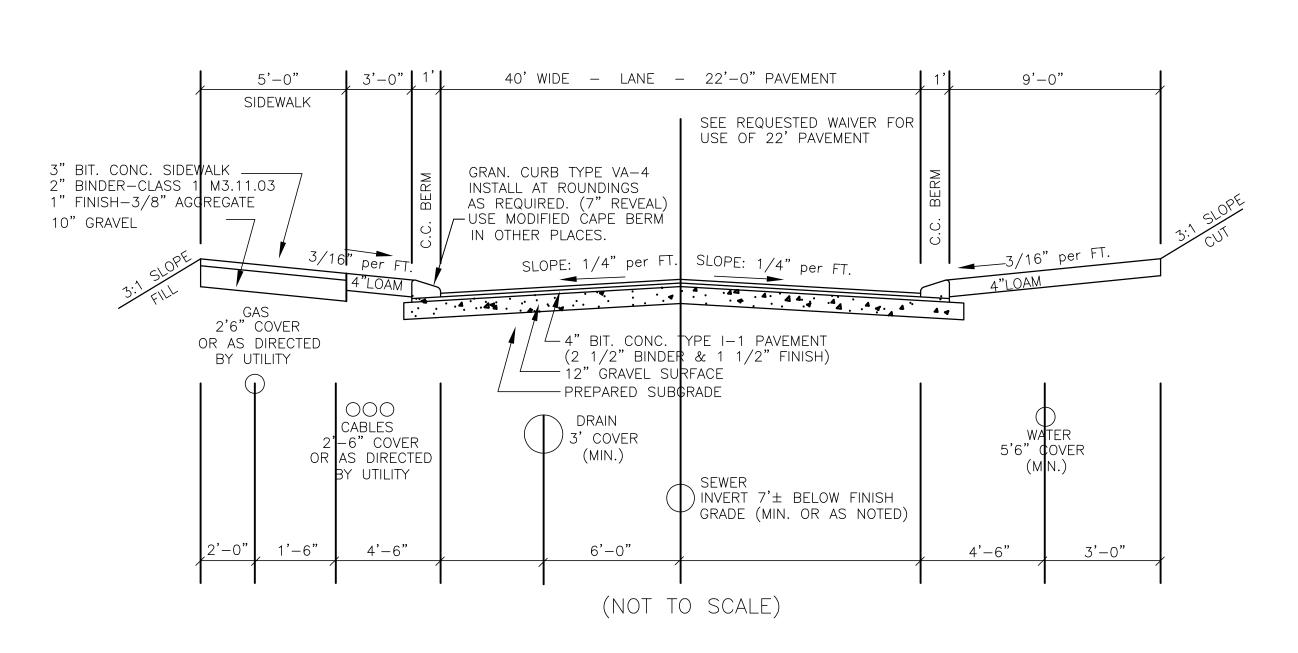


## TYPICAL RIGHT OF WAY CROSS SECTION ASHLAND, MASS.


FLARED END

W/RIPAP


INV=258.0

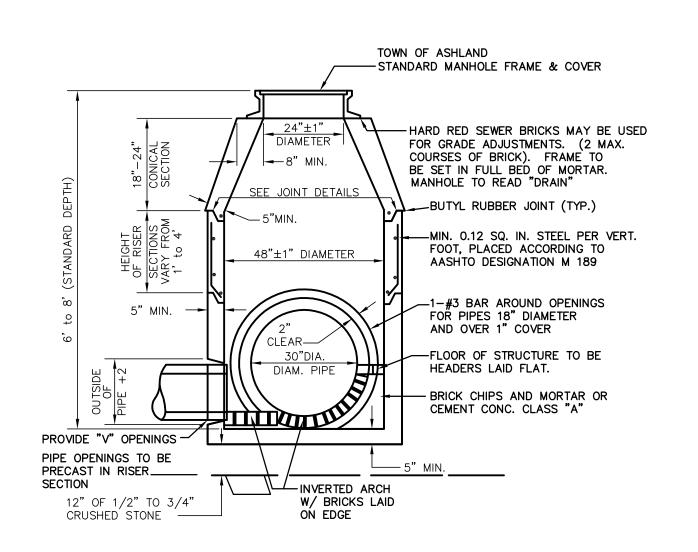

### PRECAST CONCRETE MANHOLE DETAIL

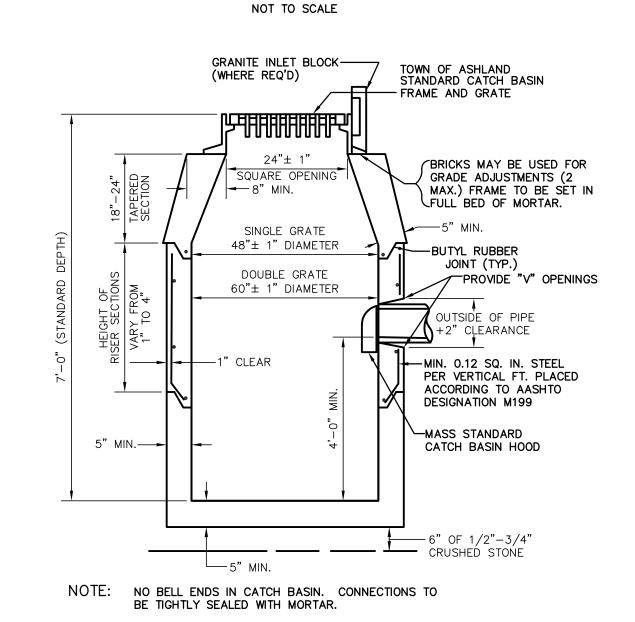

PRECAST CONCRETE CATCH BASIN DETAIL

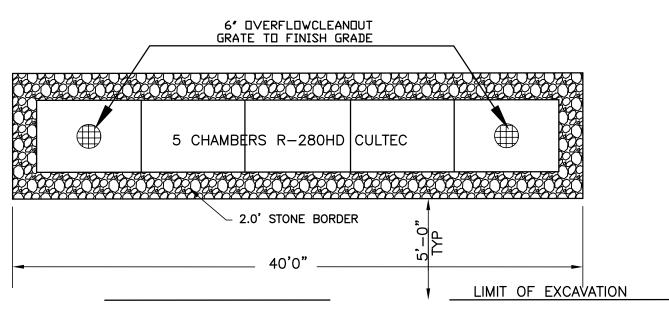

### FINISHED GRADE CULTEC No. 410 FILTER FABRIC 9" MIN C□VER CULTEC RECHARGER MODEL R-280HD-CHAMBER 6″ MIN. 1- 2 INCH WASHED, CRUSHED STONE PROVIDE 1 ROW - 5 CHAMBERS

STONE BERM

W/3-6' RIPRAP

STONE

EL = 258.0

FOREBAY

CORE 1-2" WASHED CRUSH

#### Recommended Single-Level Installation of Cultec R-280HD Unit Storm Water Management

<u> Lot 1 Lot 2</u>

254.0 280.0

253.2 279.2

250.0 276.0

248.0 274.0

**SCHEDULE OF ELEVATIONS:** 

Min. Cover

Top System

Bot System

Elev. G.W.


LIMIT OF EXCAVATION: (To extend 5 feet beyond limits of system) ALL FILL, SUBSOIL ('A' & 'B' Horizons) AND ANY DELETERIOUS MATERIAL MUST BE REMOVED FROM THE AREA OF THE LEACHING SYSTEM AND OTHER DESIGNATED LIMITS AND BACKFILLED WITH APPROVED CLEAN BANK RUN GRAVEL GRADED SO NOT MORE THAN 45% OF THE SAMPLE IS RETAINED IN A #4 SIEVE, OF THAT PASSING, 20% OR LESS SHALL PASS A #100 SIEVE AND 5% OR LESS SHALL PASS THE #200 SIEVE. NOT MORE THAN 90% SHALL BE RETAINED ON THE #50 SIEVE. SAMPLE FOR SIEVE ANALYSIS TO BE TAKEN FROM SAMPLE IN PLACE.

**GENERAL NOTES** 1. ALL ROOF RUNOFF SHALL BE DIRECTED TO LEACHING SYSTEM VIA. GUTTERS, DOUWNSPOUTS AND PIPING.

2. ALL CULTEC CHAMBERS MUST BE INSTALLED IN ACCORDANCE WITH ALL APPLICABLE LOCAL, STATE AND FEDERAL REGULATIONS. REFER TO CULTEC, INC.'S CURRENT RECOMMENDED INSTALLATION GUIDELINES.

#### CULTEC DRY ROOF RUNOFF INFILTRATION DETAIL

NOT TO SCALE

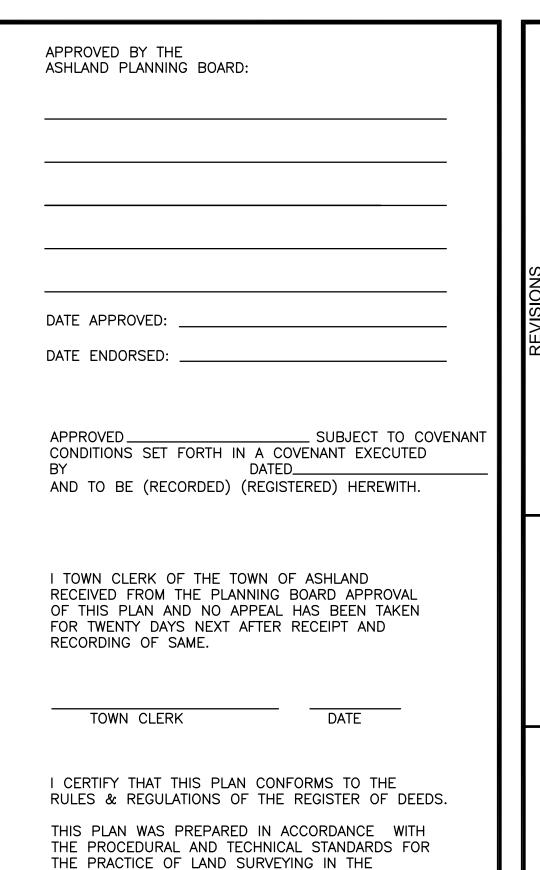

COMMONWEALTH OF MASSACHUSETTS.

JOYCE E. HASTINGS P.L.S.

**ELEV.=** 257.0

DATE

SUBDIVISOR ROAD EXT DEFINITIVE BROGDEN I ASHLAND, I

**GLM** Engineering Consultants, 19 EXCHANGE STREET HOLLISTON, MA 01746 P: 508-429-1100 F: 508-429-7160 www.GLMengineering.com

16130 DATE: OCTOBER 25, 2017 SCALE: AS SHOWN 2 of 9 SHEET


PLAN #:

27,167

**DETAIL** 

THE INFILTRATION SYSTEM AREA SHALL BE A BE EXCAVATED AND ALL DELETERIOUS MATERIAL REMOVED TO THE DEPTH OF THE NATURAL PARENT MATERIAL. LIMIT OF EXCAVATION & SAND BOTTOM
ALL DELETERIOUS MATERIAL MUST BE REMOVED FROM THE AREA OF THE

INFILTRATION SYSTEMS AND OTHER DESIGNATED LIMITS AND FILLED WITH

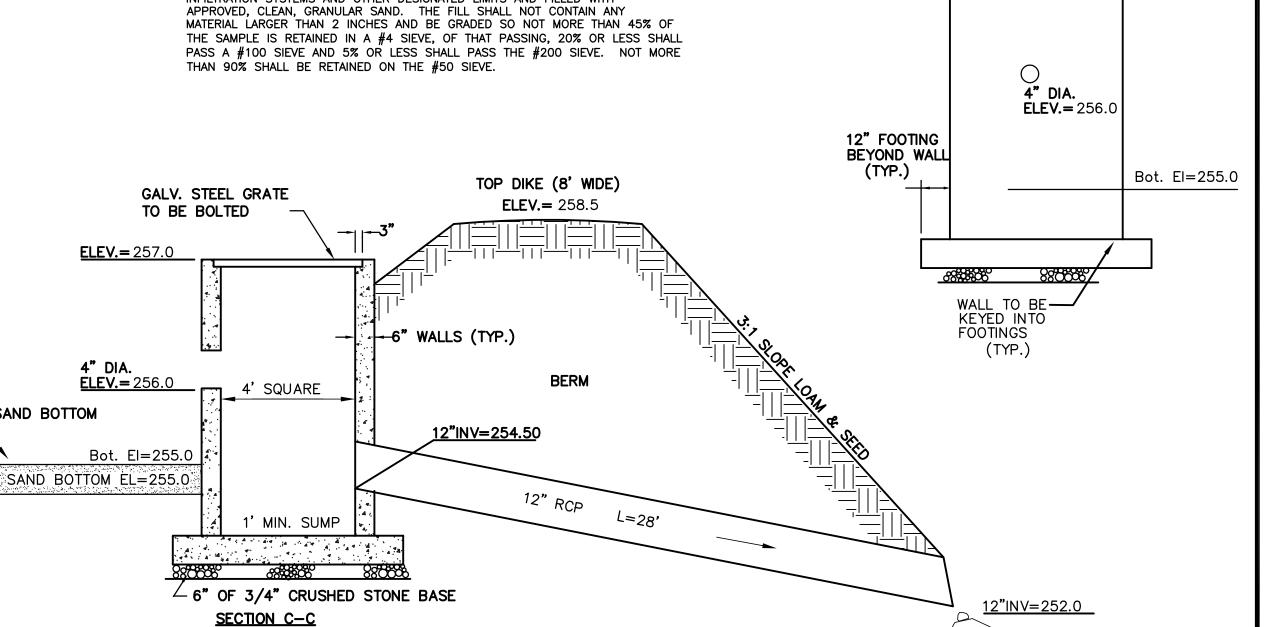

DRAINAGE BASIN & OUTLET STRUCTURE DETAIL

(PRECAST CONCRETE STRUCTURE) NOT TO SCALE

(SEE DETAIL)