

"CENTAURUS SOLAR" PHOTOVOLTAIC SOLAR ARRAY PROJECT

FOR LODESTAR ENERGY

AT 175 BUTTERFIELD DRIVE ASHLAND, MASSACHUSETTS

LOCUS TITLE INFORMATION

LOT 3A, BUTTERFIELD DRIVE

OWNER: BUTTERFIELD DRIVE, LLC
 DEED REFERENCE: BK. 17760 PG. 201
 PLAN REFERENCE: PLAN NO. 7 OF 2015
 ASSESSORS: PARCEL ID


ZONING

	REQUIRED	EXISTING
INDUSTRIAL (I)		
MIN LOT AREA	30,000 SQ. FT.	1,205,690± SQ. FT.
MINIMUM FRONTAGE	150 FEET	586.38 FEET
FRONT SETBACK	40 FEET	400± FEET
SIDE SETBACK	30 FEET	23.5' FEET
REAR	30 FEET	936' FEET

PHOTOVOLTAIC INSTALLATIONS OVERLAY DISTRICT (PIOD)

	REQUIRED	EXISTING
MIN LOT AREA	30,000 SQ. FT.	1,205,690± SQ. FT.
MINIMUM FRONTAGE	150 FEET	586.38 FEET
FRONT SETBACK	*10 FEET	N/A
SIDE SETBACK	*15 FEET	N/A
REAR	*25 FEET	N/A


* 50' FRONT, SIDE AND REAR SETBACKS REQUIRED IN RESIDENTIAL ZONE.

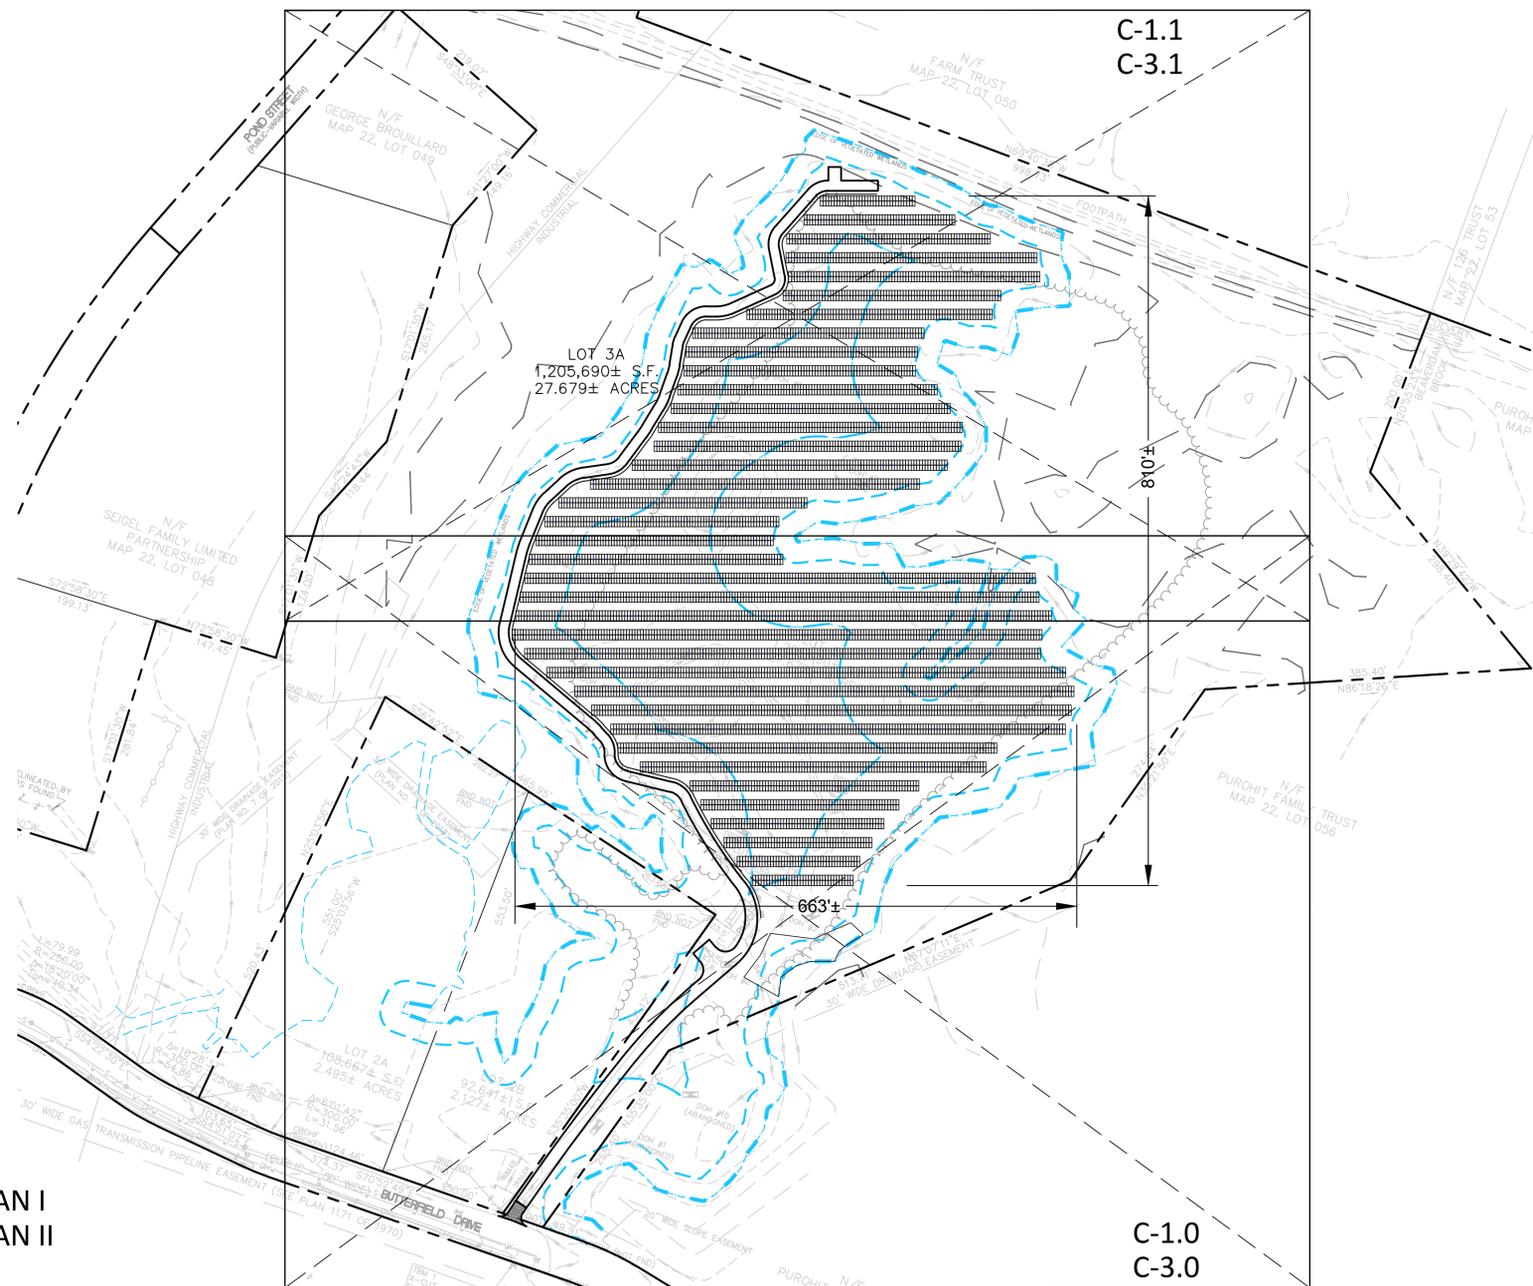

LEGEND

- BOUND
- UTILITY POLE
- IRON ROD FND
- CONC BOUND/DRILL HOLE FND
- CONC BOUND CENTER BACK
- ⊕ CATCH BASIN
- ⊗ GAS GATE
- GUY POLE
- ⊗ FIRE HYDRANT
- LIGHT POLE
- △ SPTB
- ⊗ SEWER MANHOLE
- ⊗ BENCHMARK
- UNLABELED MANHOLE
- ⊗ WATER GATE
- WETLAND FLAG
- STOCK
- ▨ MARSH
- CATCHBASIN
- ⊗ WATER VALVE
- CONC. BOUND
- ⊗ CBD

- EASEMENT LINE
- TREE-LINE
- WETLANDS LINE
- 25' NO-TOUCH LINE
- 100' BUFFER
- FLOOD-ZONE A

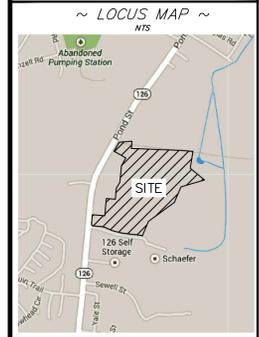

Prepared by:
Design Consultants, Inc.
 CIVIL ENGINEERS AND LAND SURVEYORS
 120 MIDDLESEX AVENUE, SUITE 20
 SOMERVILLE, MA 02145
 617-776-3350 617-776-7710

Prepared for:
LODESTAR ENGERY, LLC
 3 ELLSWORTH PLACE
 SUITE 122
 AVON, CT, 06001



PREPARED BY:
Design Consultants, Inc.
 Consulting Engineers and Surveyors
 120 MIDDLESEX AVENUE
 SUITE 20
 SOMERVILLE, MA 02145
 617-776-3350

Project Title:
CENTAURUS SOLAR
 IN
 ASHLAND, MA

SHEET INDEX:

SHEET No.	DESCRIPTION
C-0.0	COVER SHEET
C-1.0	EXISTING CONDITIONS PLAN I
C-1.1	EXISTING CONDITIONS PLAN II
C-2.0	SITE PREPARATION PLAN
C-3.0	SITE, GRADING & DRAINAGE PLAN I
C-3.1	SITE, GRADING & DRAINAGE PLAN II
C-4.0	DETAILS I
C-4.1	DETAILS II

Sheet Title:
TITLE SHEET



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Scale:	1"=100'
Drawn by:	SSW
Checked by:	SBS
Proj. #	2015-017

10/8/2015	PANELS & DRIVEWAY LAYOUT
DATE:	ACTION
SHEET C-0.0	



P:\2015 PROJECTS\2015-017 BUTTERFIELD DR. ASHLAND (SOLAR)\DWG_ENGINEERING\15-017 C3.0 SITE PLAN & COVER SHEET.DWG


P:\2015 PROJECTS\2015-017 BUTTERFIELD DR. ASHLAND (SOLAR)\DWG\ENGINEERING\15-017 C1.0 EXISTING CONDITIONS PLAN.DWG

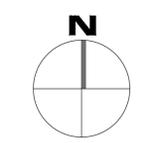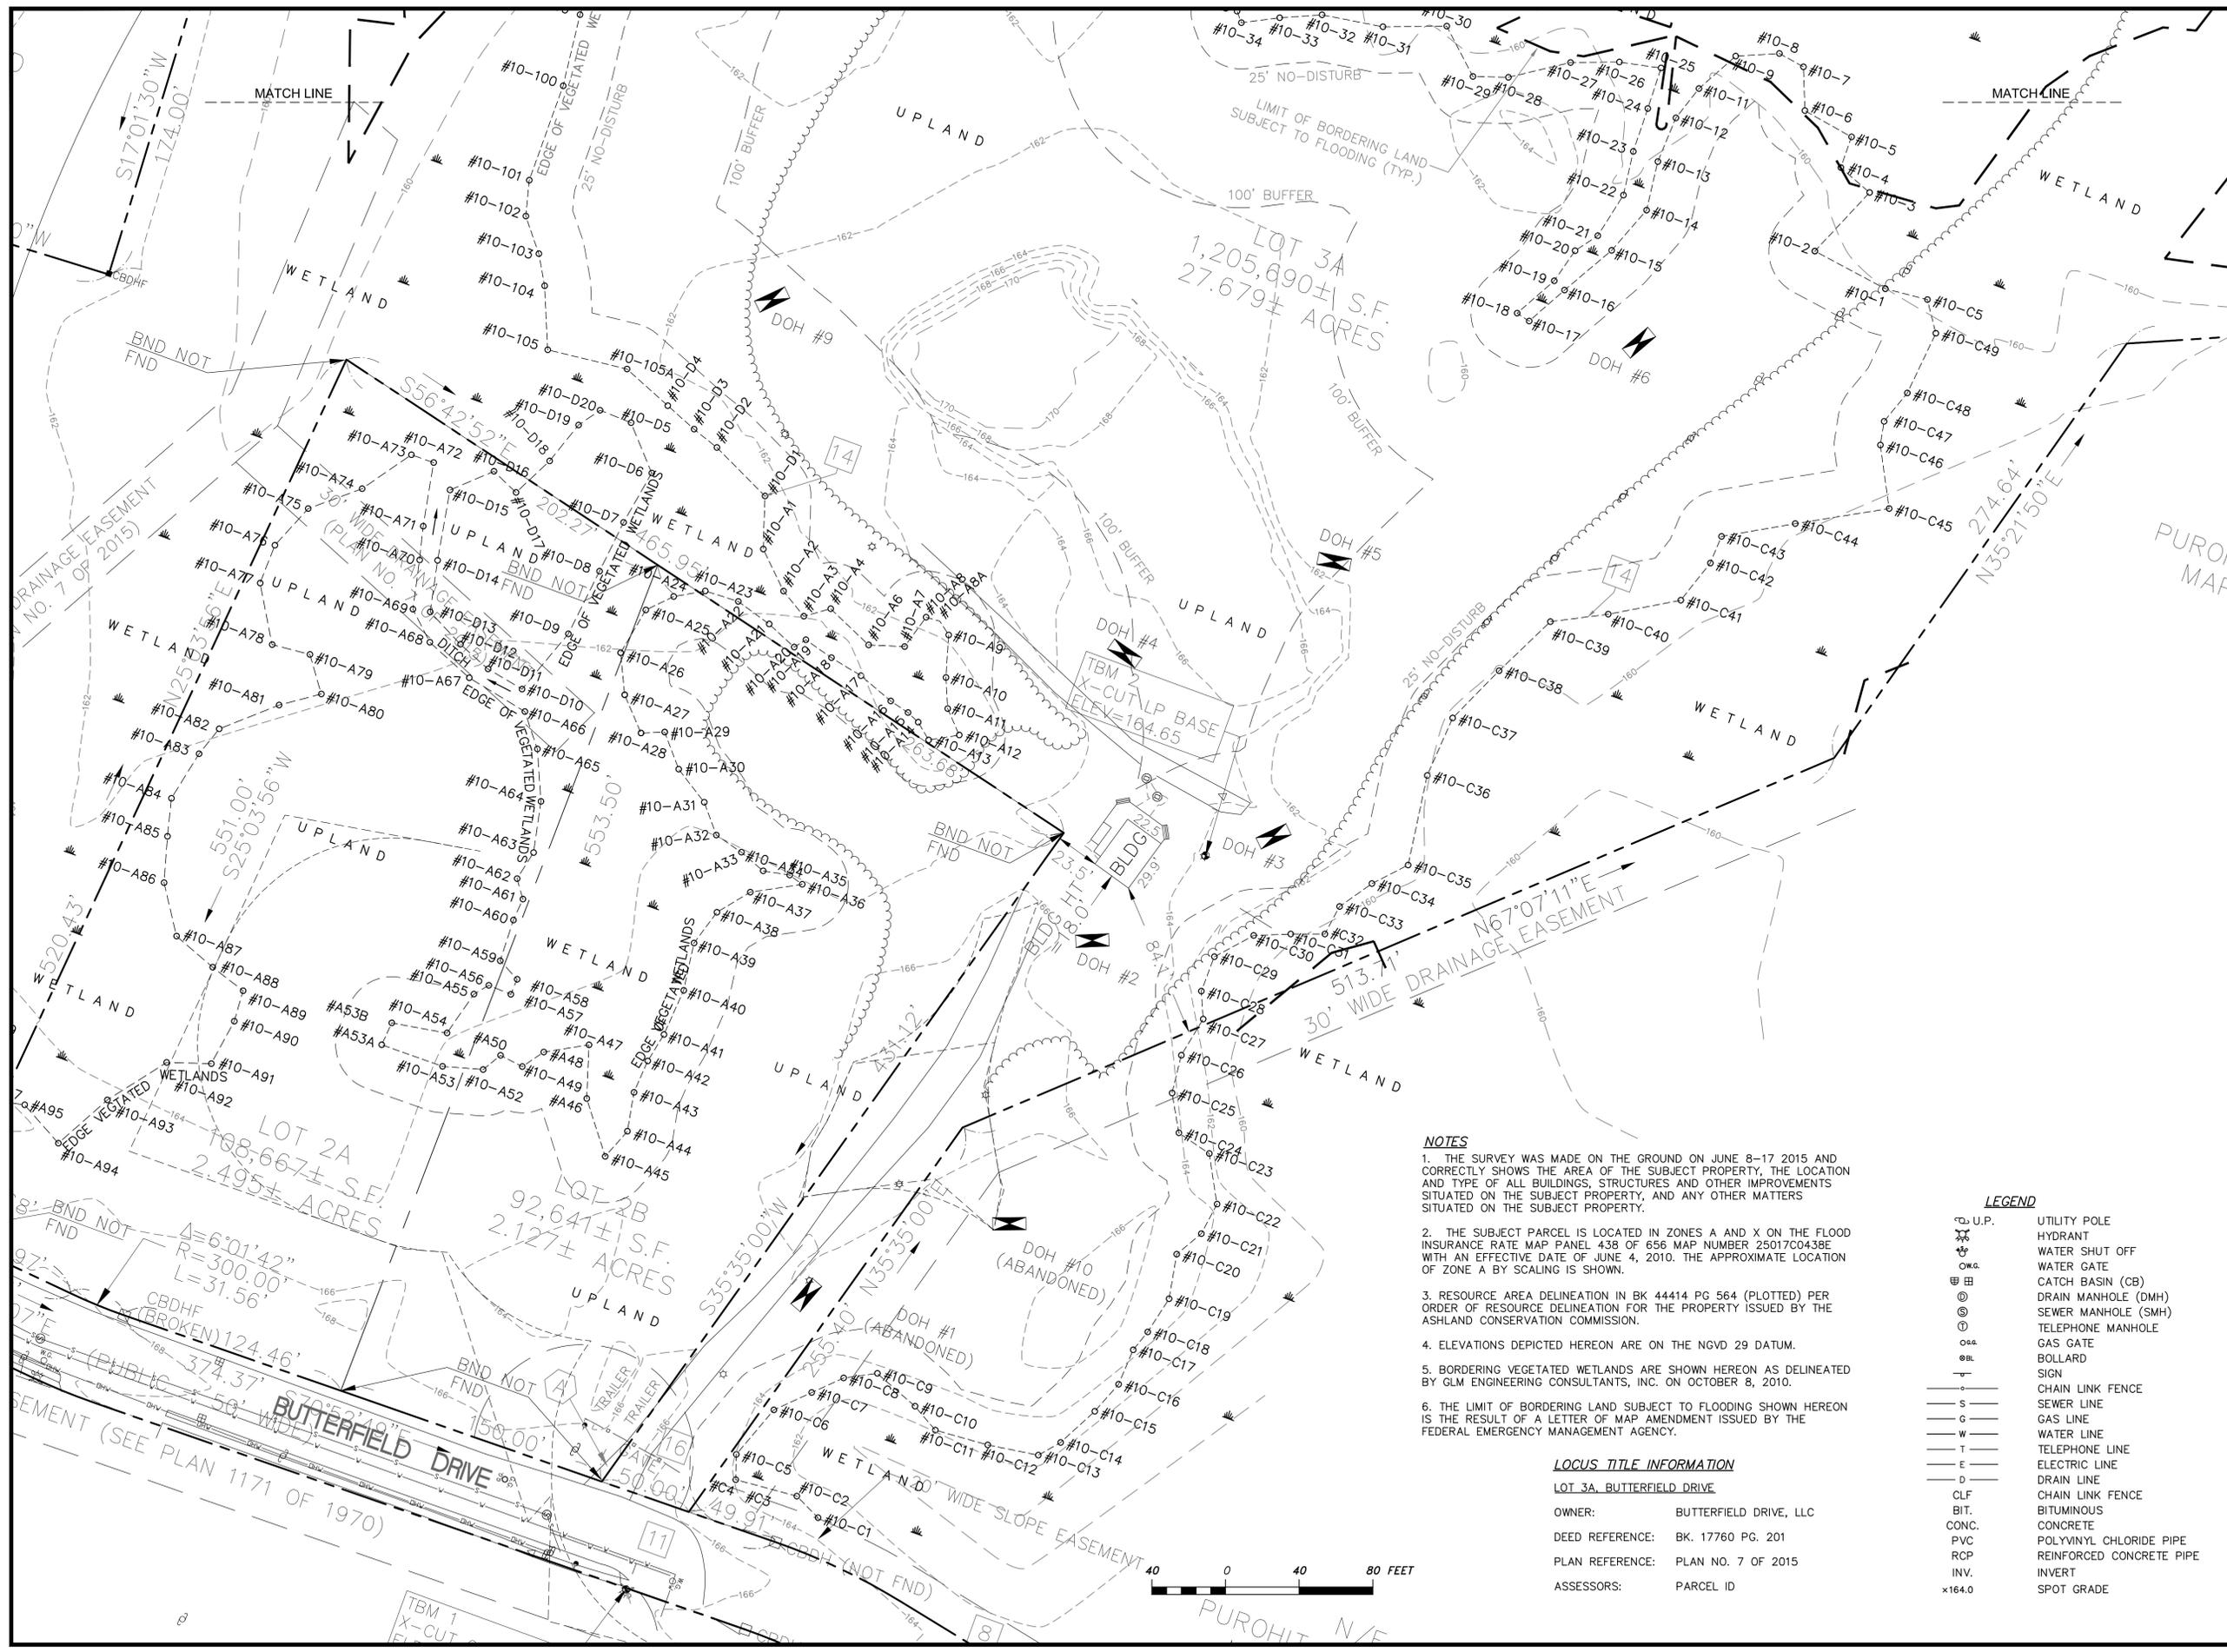

~ LOCUS MAP ~
N/S

Prepared by:
Design Consultants, Inc.
CIVIL ENGINEERS and LAND SURVEYORS
120 Middlesex Avenue, Suite 207
Somerville, MA 02145
617-776-3309 617-776-7710

Prepared for:
LODESTAR ENRGY, LLC
3 ELLSWORTH PLACE
SUITE 122
AVON, CT, 06001

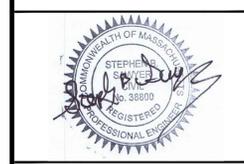

Project Title:
CENTAURUS SOLAR
IN
ASHLAND, MA

Sheet Title:
**EXISTING
CONDITIONS
PLAN I**

Date:	9-14-2015
Scale:	1"=40'
Drawn by:	SSW
Checked by:	SBS
Proj. #	2015-017

10/8/2015	PANELS & DRIVEWAY LAYOUT
DATE:	ACTION
SHEET C-1.0	

- NOTES**
- THE SURVEY WAS MADE ON THE GROUND ON JUNE 8-17 2015 AND CORRECTLY SHOWS THE AREA OF THE SUBJECT PROPERTY, THE LOCATION AND TYPE OF ALL BUILDINGS, STRUCTURES AND OTHER IMPROVEMENTS SITUATED ON THE SUBJECT PROPERTY, AND ANY OTHER MATTERS SITUATED ON THE SUBJECT PROPERTY.
 - THE SUBJECT PARCEL IS LOCATED IN ZONES A AND X ON THE FLOOD INSURANCE RATE MAP PANEL 438 OF 656 MAP NUMBER 25017C0438E WITH AN EFFECTIVE DATE OF JUNE 4, 2010. THE APPROXIMATE LOCATION OF ZONE A BY SCALING IS SHOWN.
 - RESOURCE AREA DELINEATION IN BK 44414 PG 564 (PLOTTED) PER ORDER OF RESOURCE DELINEATION FOR THE PROPERTY ISSUED BY THE ASHLAND CONSERVATION COMMISSION.
 - ELEVATIONS DEPICTED HEREON ARE ON THE NGVD 29 DATUM.
 - BORDERING VEGETATED WETLANDS ARE SHOWN HEREON AS DELINEATED BY GLM ENGINEERING CONSULTANTS, INC. ON OCTOBER 8, 2010.
 - THE LIMIT OF BORDERING LAND SUBJECT TO FLOODING SHOWN HEREON IS THE RESULT OF A LETTER OF MAP AMENDMENT ISSUED BY THE FEDERAL EMERGENCY MANAGEMENT AGENCY.


LEGEND

U.P.	UTILITY POLE
HYDRANT	HYDRANT
WATER SHUT OFF	WATER SHUT OFF
WATER GATE	WATER GATE
CATCH BASIN (CB)	CATCH BASIN (CB)
DRAIN MANHOLE (DMH)	DRAIN MANHOLE (DMH)
SEWER MANHOLE (SMH)	SEWER MANHOLE (SMH)
TELEPHONE MANHOLE	TELEPHONE MANHOLE
GAS GATE	GAS GATE
BOLLARD	BOLLARD
SIGN	SIGN
CHAIN LINK FENCE	CHAIN LINK FENCE
SEWER LINE	SEWER LINE
GAS LINE	GAS LINE
WATER LINE	WATER LINE
TELEPHONE LINE	TELEPHONE LINE
ELECTRIC LINE	ELECTRIC LINE
DRAIN LINE	DRAIN LINE
CHAIN LINK FENCE	CHAIN LINK FENCE
BIT.	BITUMINOUS
CONC.	CONCRETE
PVC	POLYVINYL CHLORIDE PIPE
RCP	REINFORCED CONCRETE PIPE
INV.	INVERT
x164.0	SPOT GRADE

LOCUS TITLE INFORMATION
LOT 3A, BUTTERFIELD DRIVE
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 PLAN REFERENCE: PLAN NO. 7 OF 2015
 ASSESSORS: PARCEL ID



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~ LOCUS MAP ~
MIS
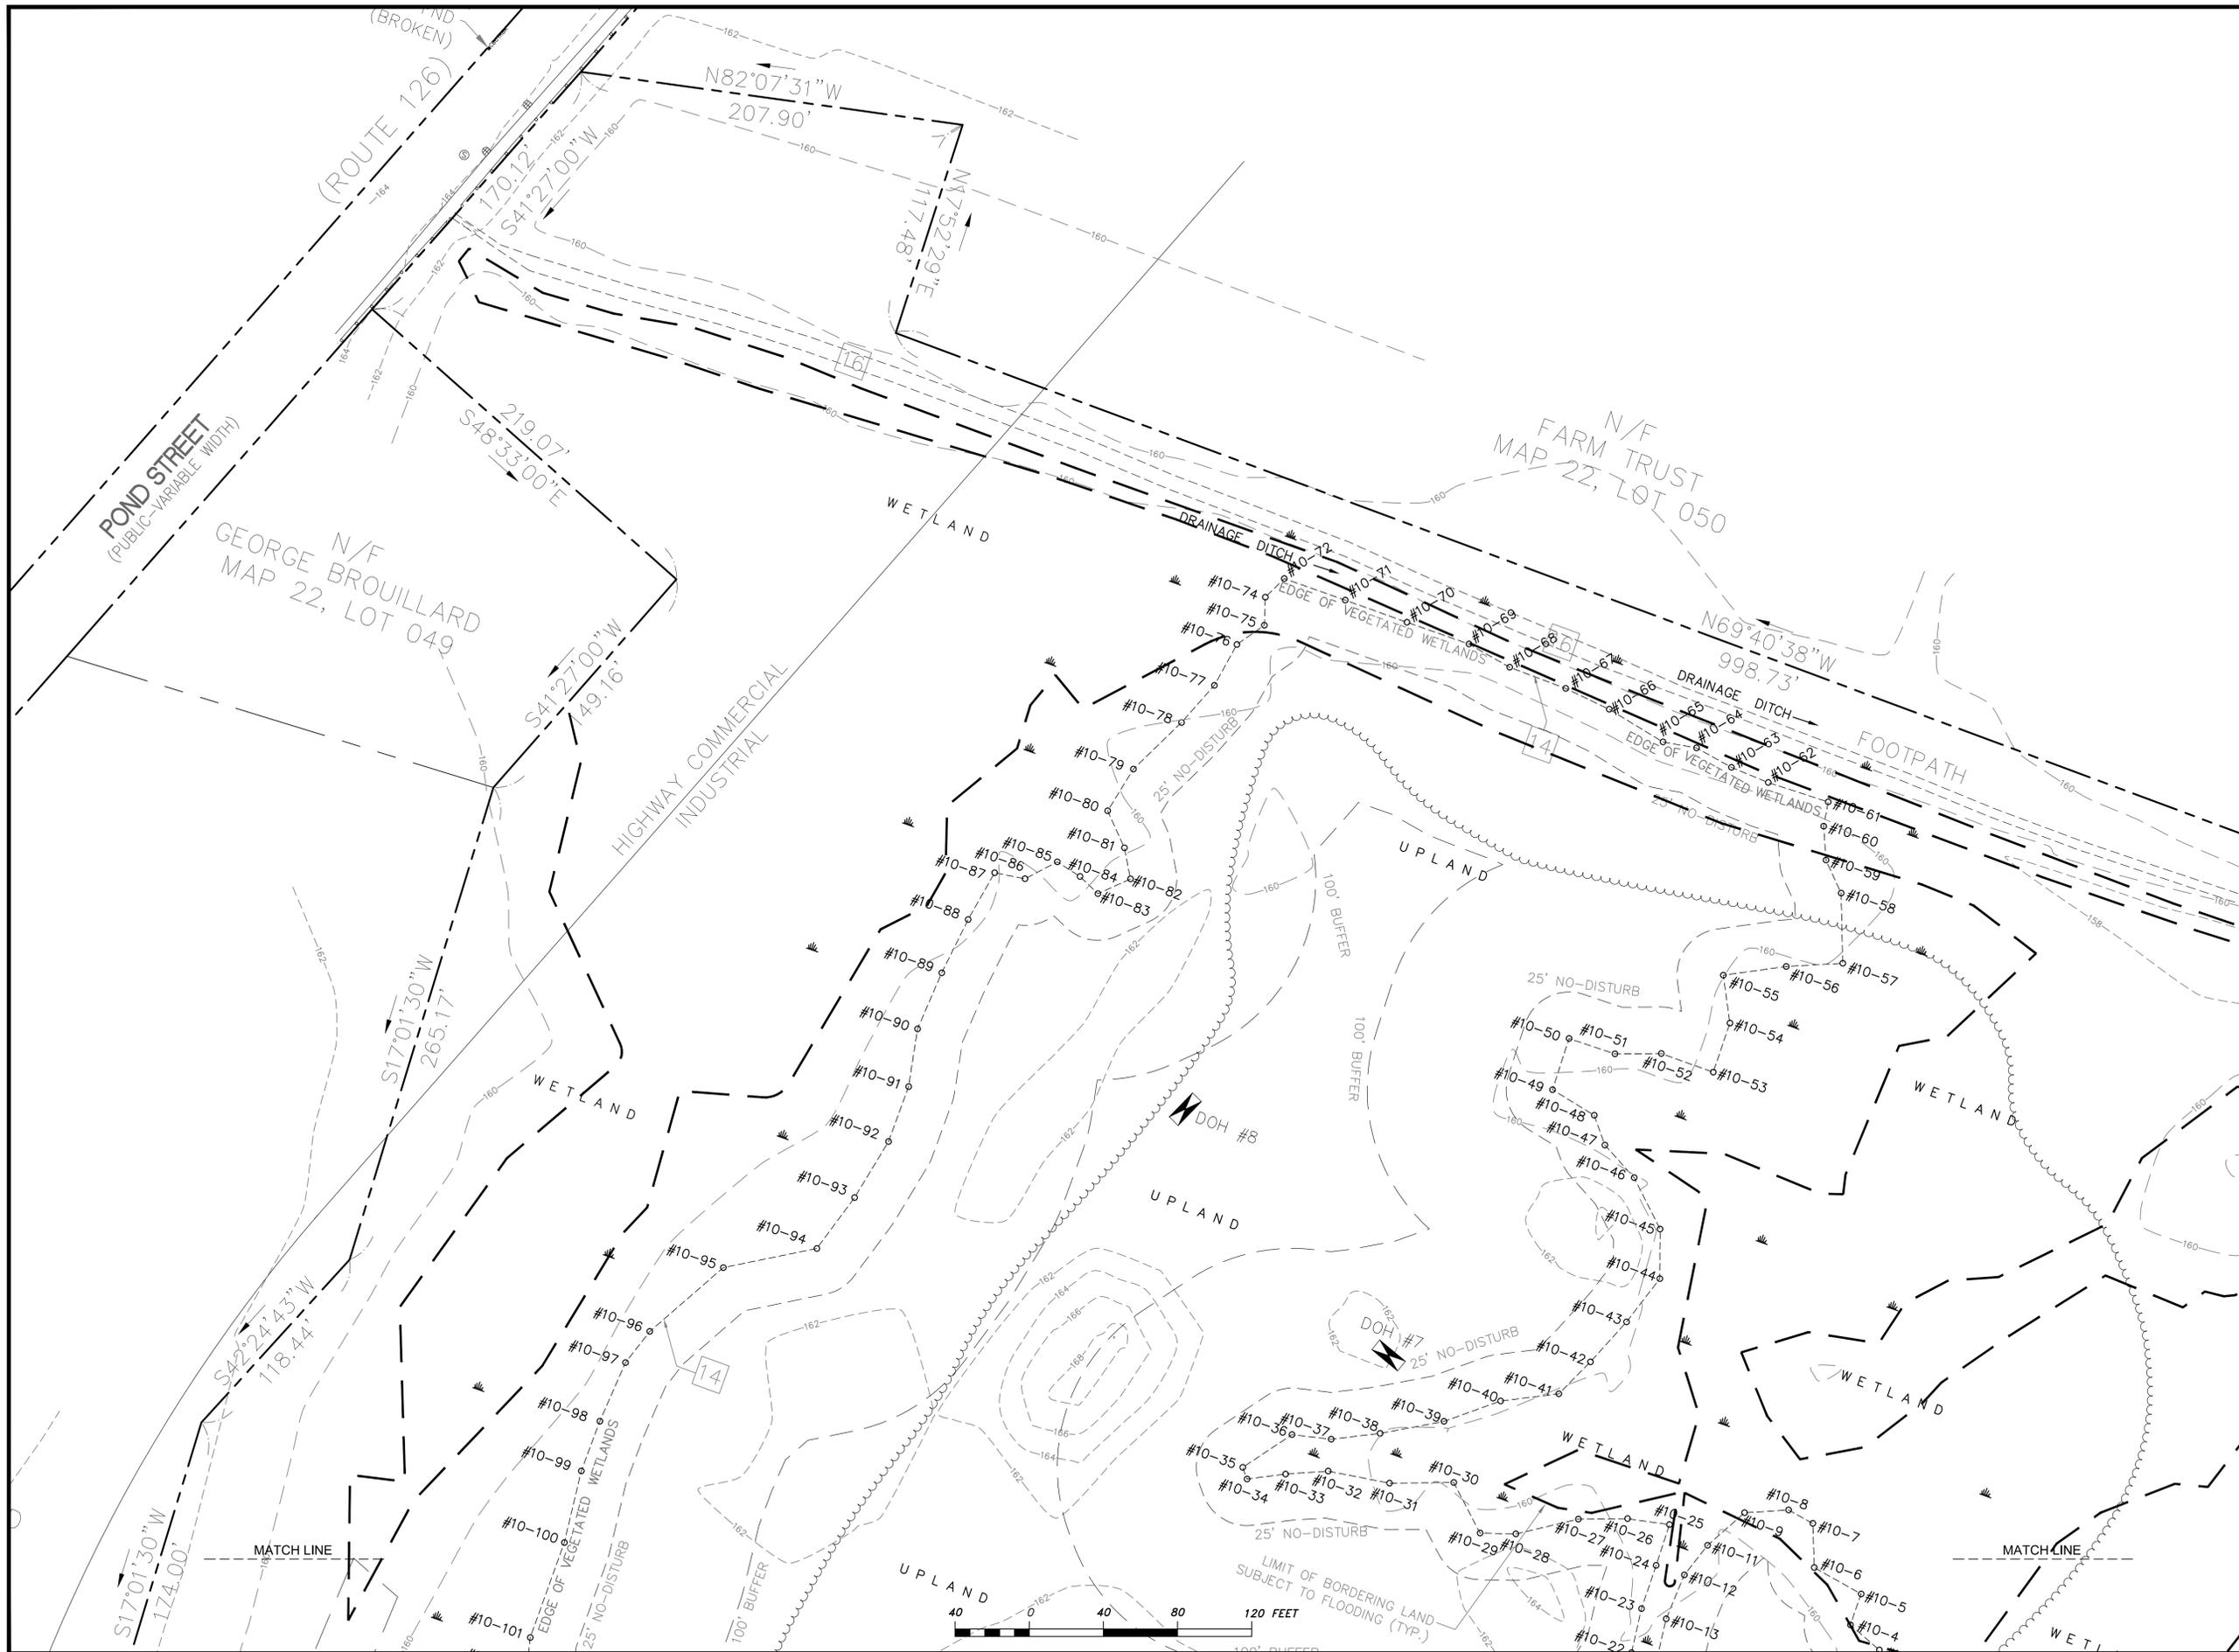
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CIVIL ENGINEERS and LAND SURVEYORS
120 Middlesex Avenue, Suite 207
Somerville, MA 02145
617-776-3359 617-776-7710

Prepared for:
LODESTAR ENRGY, LLC
3 ELLSWORTH PLACE
SUITE 122
AVON, CT, 06001



Project Title:
CENTAURUS SOLAR
IN
ASHLAND, MA

Sheet Title:
EXISTING
CONDITIONS
PLAN II

Date:	9-14-2015
Scale:	1"=40'
Drawn by:	SSW
Checked by:	SBS
Proj. #	2015-017

10/8/2015	PANELS & DRIVEWAY LAYOUT
DATE:	ACTION

SHEET
C1.1

P:\2015 PROJECTS\2015-017 BUTTERFIELD DR. ASHLAND (SOLAR)\ENGINEERING\15-017 C2.0 SITE PREPARATION PLAN.DWG

LEGEND

- | | | | |
|---|------------------------|-------|--------------------------|
| ○ | UTILITY POLE | CLF | CHAIN LINK FENCE |
| ○ | HYDRANT | BIT. | BITUMINOUS |
| ○ | WATER SHUT OFF | CONC. | CONCRETE |
| ○ | WATER GATE | PVC | POLYVINYL CHLORIDE PIPE |
| ○ | CATCH BASIN (CB) | RCP | REINFORCED CONCRETE PIPE |
| ○ | DRAIN MANHOLE (DMH) | CI | CAST IRON PIPE |
| ○ | SEWER MANHOLE (SMH) | VC | VITRIFIED CLAY PIPE |
| ○ | GAS GATE | | |
| ○ | BOLLARD | | |
| ○ | SIGN | | |
| — | CHAIN LINK FENCE | | |
| — | SEWER LINE | | |
| — | GAS LINE | | |
| — | WATER LINE | | |
| — | TELEPHONE LINE | | |
| — | ELECTRIC LINE | | |
| — | DRAIN LINE | | |
| — | VERTICAL GRANITE CURB | | |
| — | VERTICAL CONCRETE CURB | | |

GENERAL NOTES

1. ALL WORK PERFORMED AS PART OF THIS PROJECT SHALL CONFORM TO THE TOWN OF ASHLAND, DEPT. OF PUBLIC WORKS AND ANY OTHER AGENCY WITH AUTHORITY IN THIS AREA.
2. CONTRACTOR TO MAINTAIN WORK AREA IN A CLEAN CONDITION. NO CONSTRUCTION DEBRIS SHALL BE ALLOWED TO ACCUMULATE WITHIN THE WORKSITE AND NO DIRT, GRAVEL, ETC. SHALL BE ALLOWED TO ACCUMULATE ON THE PUBLIC RIGHT-OF-WAY.
3. AREAS OUTSIDE THE LIMITS OF PROPOSED WORK DISTURBED BY THE CONTRACTOR'S OPERATIONS SHALL BE RESTORED BY THE CONTRACTOR TO THEIR ORIGINAL CONDITION AT THE CONTRACTOR'S EXPENSE.
4. ALL EXISTING MONITORING WELLS ARE TO BE MAINTAINED DURING CONSTRUCTION.



~ LOCUS MAP ~
NTS

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Design Consultants, Inc.
CIVIL ENGINEERS AND LAND SURVEYORS
120 Middlesex Avenue, Suite 207
Somerville, MA 02145
617-776-3309 617-776-7710

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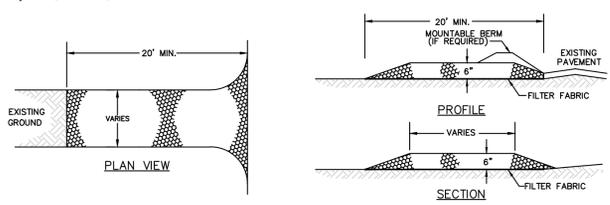
Sheet Title:
SITE PREPARATION PLAN

Date:	9-14-2015
Scale:	1"=80'
Drawn by:	SSW
Checked by:	SBS
Proj. #	2015-017

10/8/2015 PANELS & DRIVEWAY LAYOUT

DATE: ACTION

SHEET C2.0



CONSTRUCTION SPECIFICATIONS

STONE SIZE - SEE GRADATION TABLE

LENGTH - 20 FEET MINIMUM.

THICKNESS - SIX (6) INCHES (MINIMUM).

WIDTH - VARIES

FILTER FABRIC - MIRAFI 600X OR APPROVED EQUAL.

INSTALLATION - THE AREA OF THE ENTRANCE SHOULD BE CLEARED OF ALL VEGETATION, ROOTS, AND OTHER OBJECTIONABLE MATERIAL. A ROAD STABILIZATION FILTER FABRIC CAN BE PLACED ON THE SUBGRADE PRIOR TO THE GRAVEL PLACEMENT TO PREVENT PUMPING. THE GRAVEL SHALL BE PLACED TO THE SPECIFIED DIMENSIONS.

MAINTENANCE - THE ENTRANCE SHALL BE MAINTAINED IN A CONDITION WHICH WILL PREVENT TRACKING OR FLOWING OF SEDIMENT ONTO PUBLIC RIGHTS-OF-WAY. THIS WILL REQUIRE PERIODIC TOP DRESSING WITH ADDITIONAL STONE OR ADDITIONAL LENGTH AS CONDITIONS DEMAND AND REPAIR AND/OR CLEANOUT OF ANY MEASURES USED TO TRAP SEDIMENT. ALL SEDIMENT SPILLED, DROPPED, WASHED OR TRACKED ONTO PUBLIC RIGHTS-OF-WAY MUST BE REMOVED IMMEDIATELY.

CRUSHED STONE GRADATION TABLE

SIEVE SIZE	% PASSING BY WEIGHT
2 inches	100
1 1/2 inches	90-100
1 inch	20-55
3/4 inch	0-15
3/8 inch	0-5

STABILIZED CONSTRUCTION ENTRANCE
NOT TO SCALE

WASTE DISPOSAL



- A. WASTE MATERIALS**
- ALL WASTE MATERIALS SHALL BE COLLECTED AND STORED IN SECURELY LIDDED RECEPTACLES. ALL TRASH AND CONSTRUCTION DEBRIS FROM THE SITE SHALL BE DEPOSITED IN A DUMPSTER. NO CONSTRUCTION WASTE MATERIALS SHALL BE BURIED ON SITE. ALL PERSONNEL SHALL BE INSTRUCTED REGARDING THE CORRECT PROCEDURE FOR WASTE DISPOSAL BY THE SUPERINTENDENT.
- B. HAZARDOUS WASTE**
- ALL HAZARDOUS WASTE MATERIALS SHALL BE DISPOSED OF IN THE MANNER SPECIFIED BY LOCAL OR STATE REGULATION OR BY THE MANUFACTURER. SITE PERSONNEL SHALL BE INSTRUCTED IN THESE PRACTICES BY THE SUPERINTENDENT.
- C. SANITARY WASTE**
- ALL SANITARY WASTE SHALL BE COLLECTED FROM THE PORTABLE UNITS A MINIMUM OF ONCE PER WEEK BY A LICENSED SANITARY WASTE MANAGEMENT CONTRACTOR.

DUST CONTROL

THE CONTRACTOR SHALL BE RESPONSIBLE TO CONTROL DUST THROUGHOUT THE CONSTRUCTION PERIOD. DUST CONTROL METHODS SHALL INCLUDE, BUT NOT LIMITED TO SPRINKLING WATER ON EXPOSED AREAS, COVERING LOADED DUMP TRUCKS LEAVING THE SITE, AND TEMPORARY MULCHING. DUST CONTROL MEASURES SHALL BE UTILIZED SO AS TO PREVENT THE MIGRATION OF DUST FROM THE SITE TO ADJACENT AREAS.



P:\2015 PROJECTS\2015-017 BUTTERFIELD DR. ASHLAND (SOLAR)\DWG_ENGINEERING\15-017 C3.0 SITE PLAN & COVER SHEET.DWG

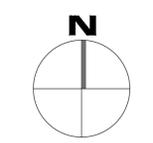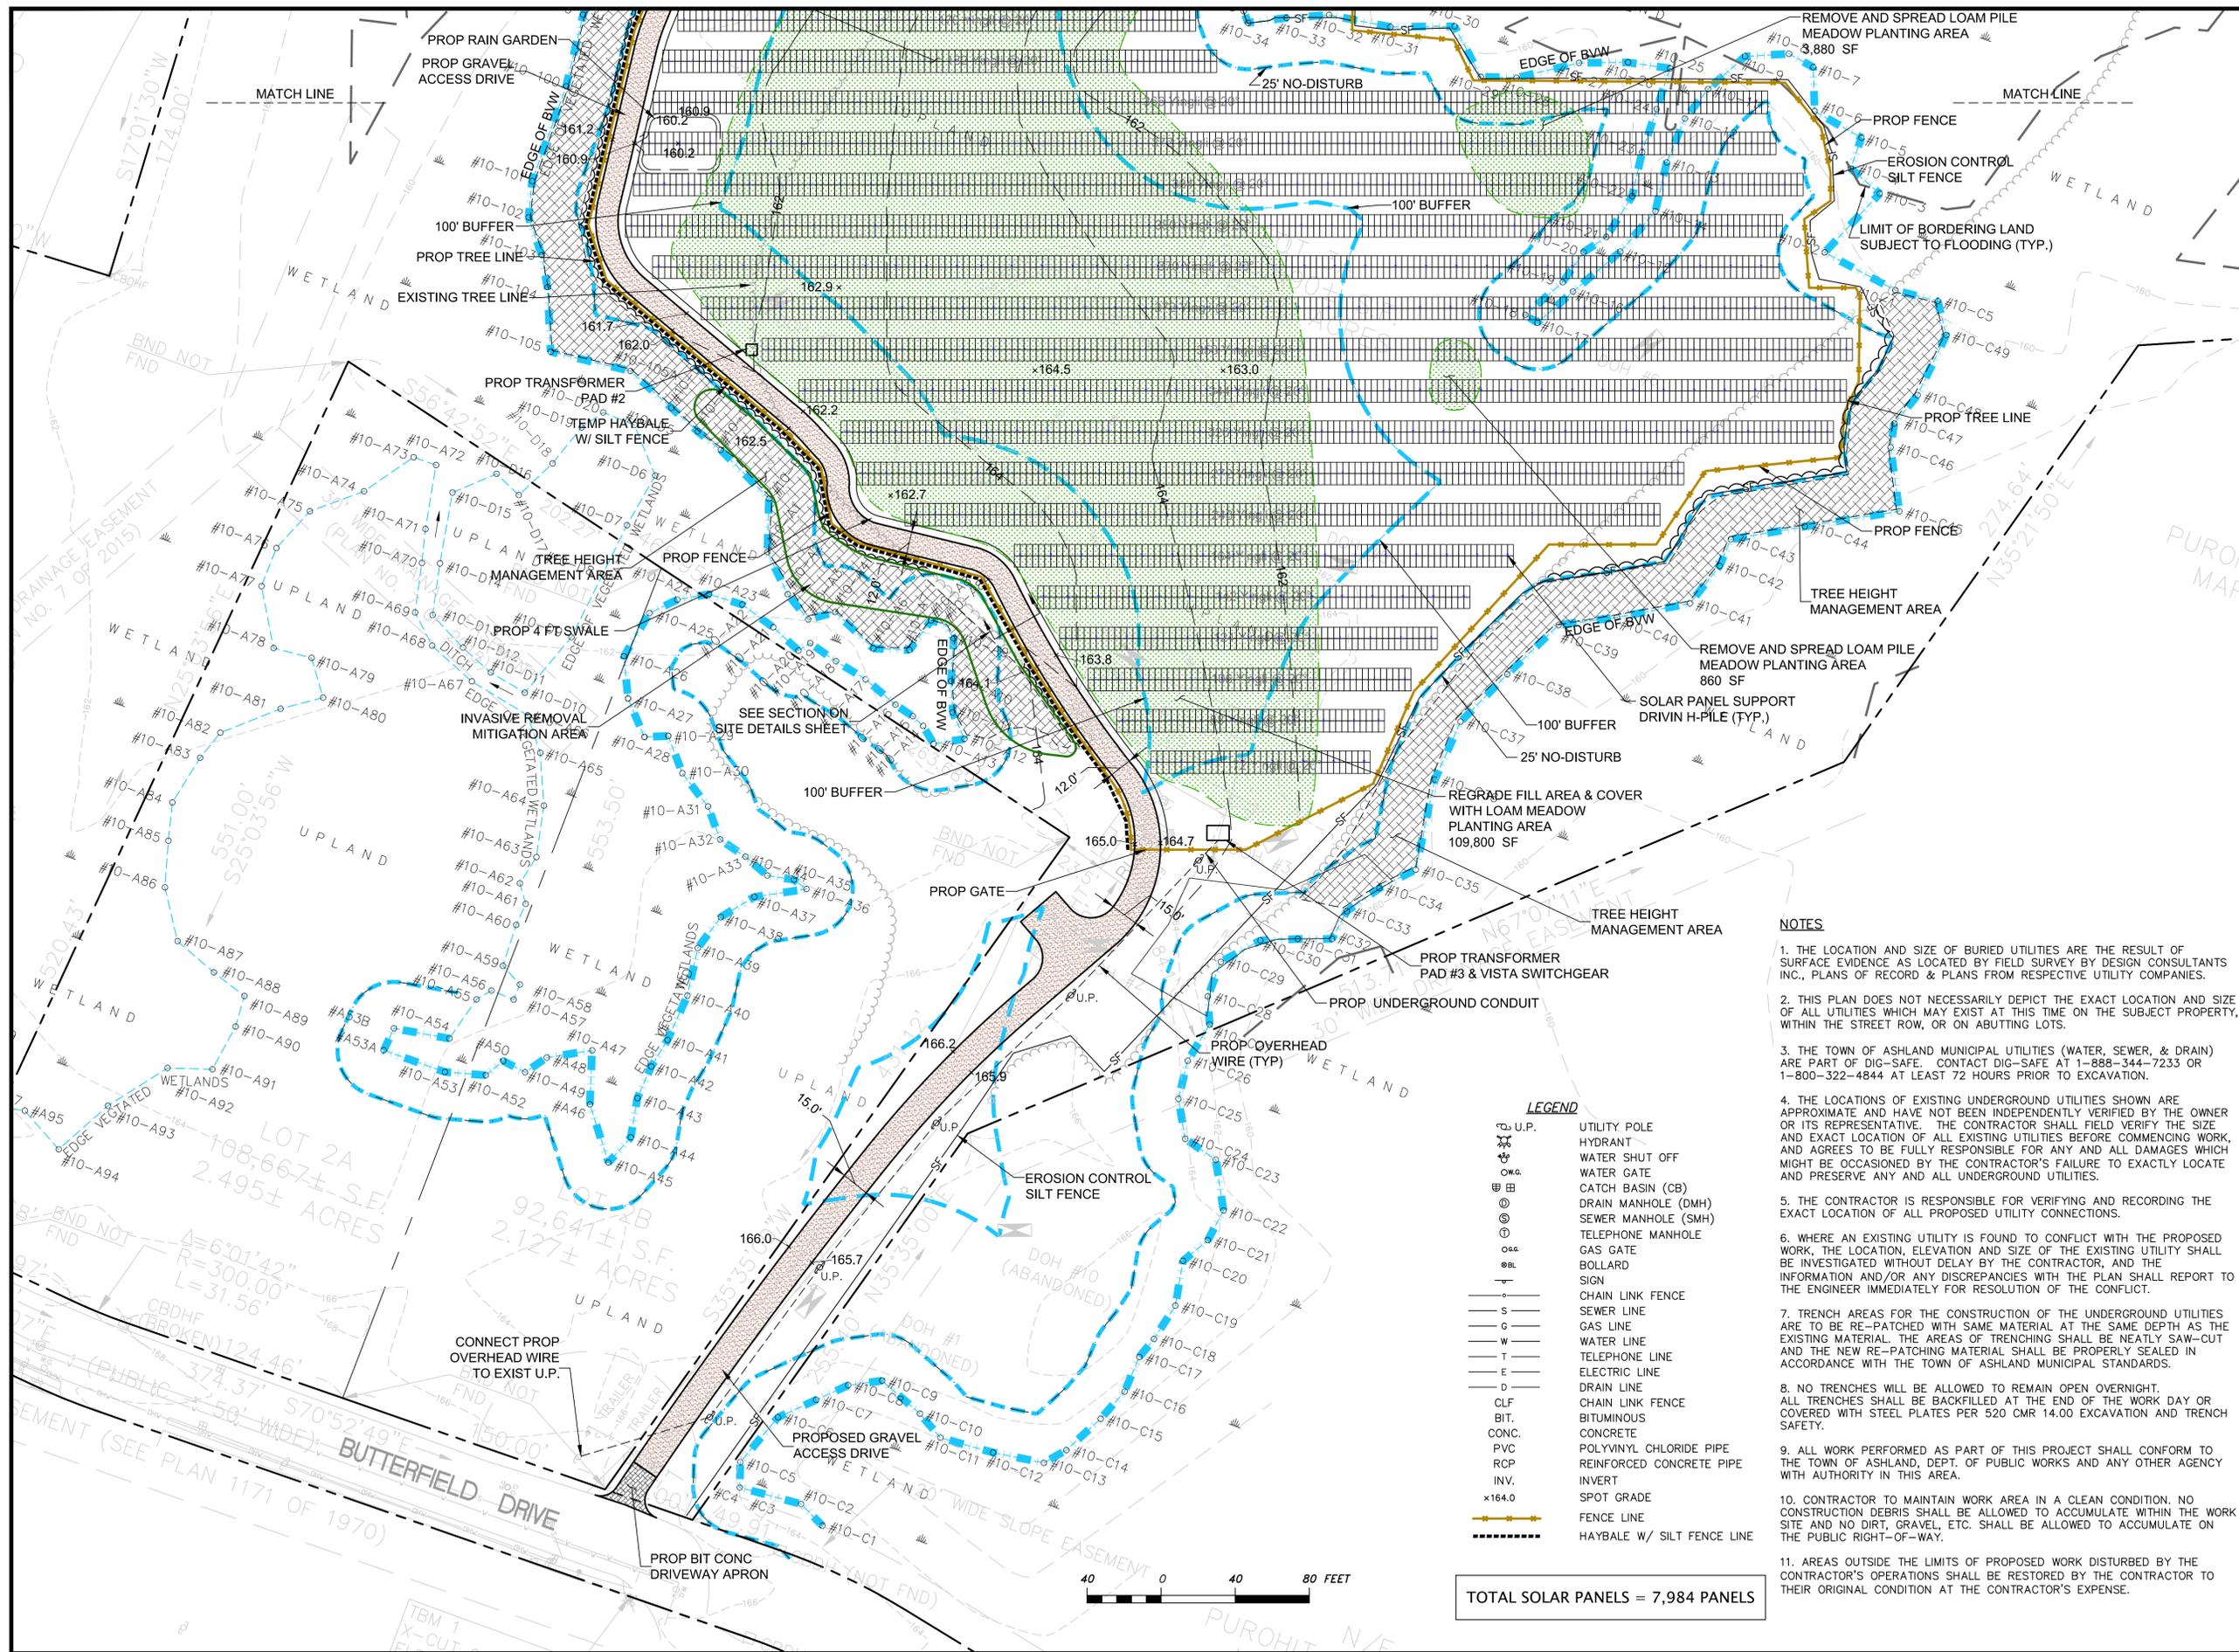


~ LOCUS MAP ~
N15



Prepared by:
Design Consultants, Inc.
CIVIL ENGINEERS and LAND SURVEYORS
120 Middlesex Avenue, Suite 20
Somerville, MA 02145
617-776-3309, 617-776-7710

Prepared for:
LODESTAR ENRGY, LLC
3 ELLSWORTH PLACE
SUITE 122
AVON, CT, 06001

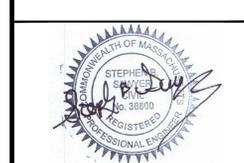

Project Title:
CENTAURUS SOLAR
IN
ASHLAND, MA

Sheet Title:
SITE, GRADING & DRAINAGE PLAN I

Date:	9-14-2015
Scale:	1"=40'
Drawn by:	SSW
Checked by:	SBS
Proj. #	2015-017

10/8/2015	PANELS & DRIVEWAY LAYOUT
DATE:	ACTION
SHEET C-3.0	

- NOTES**
1. THE LOCATION AND SIZE OF BURIED UTILITIES ARE THE RESULT OF SURFACE EVIDENCE AS LOCATED BY FIELD SURVEY BY DESIGN CONSULTANTS INC., PLANS OF RECORD & PLANS FROM RESPECTIVE UTILITY COMPANIES.
 2. THIS PLAN DOES NOT NECESSARILY DEPICT THE EXACT LOCATION AND SIZE OF ALL UTILITIES WHICH MAY EXIST AT THIS TIME ON THE SUBJECT PROPERTY, WITHIN THE STREET ROW, OR ON ABUTTING LOTS.
 3. THE TOWN OF ASHLAND MUNICIPAL UTILITIES (WATER, SEWER, & DRAIN) ARE PART OF DIG-SAFE. CONTACT DIG-SAFE AT 1-888-344-7233 OR 1-800-322-4844 AT LEAST 72 HOURS PRIOR TO EXCAVATION.
 4. THE LOCATIONS OF EXISTING UNDERGROUND UTILITIES SHOWN ARE APPROXIMATE AND HAVE NOT BEEN INDEPENDENTLY VERIFIED BY THE OWNER OR ITS REPRESENTATIVE. THE CONTRACTOR SHALL FIELD VERIFY THE SIZE AND EXACT LOCATION OF ALL EXISTING UTILITIES BEFORE COMMENCING WORK, AND AGREES TO BE FULLY RESPONSIBLE FOR ANY AND ALL DAMAGES WHICH MIGHT BE OCCASIONED BY THE CONTRACTOR'S FAILURE TO EXACTLY LOCATE AND PRESERVE ANY AND ALL UNDERGROUND UTILITIES.
 5. THE CONTRACTOR IS RESPONSIBLE FOR VERIFYING AND RECORDING THE EXACT LOCATION OF ALL PROPOSED UTILITY CONNECTIONS.
 6. WHERE AN EXISTING UTILITY IS FOUND TO CONFLICT WITH THE PROPOSED WORK, THE LOCATION, ELEVATION AND SIZE OF THE EXISTING UTILITY SHALL BE INVESTIGATED WITHOUT DELAY BY THE CONTRACTOR, AND THE INFORMATION AND/OR ANY DISCREPANCIES WITH THE PLAN SHALL REPORT TO THE ENGINEER IMMEDIATELY FOR RESOLUTION OF THE CONFLICT.
 7. TRENCH AREAS FOR THE CONSTRUCTION OF THE UNDERGROUND UTILITIES ARE TO BE RE-PATCHED WITH SAME MATERIAL AT THE SAME DEPTH AS THE EXISTING MATERIAL. THE AREAS OF TRENCHING SHALL BE NEATLY SAW-CUT AND THE NEW RE-PATCHING MATERIAL SHALL BE PROPERLY SEALED IN ACCORDANCE WITH THE TOWN OF ASHLAND MUNICIPAL STANDARDS.
 8. NO TRENCHES WILL BE ALLOWED TO REMAIN OPEN OVERNIGHT. ALL TRENCHES SHALL BE BACKFILLED AT THE END OF THE WORK DAY OR COVERED WITH STEEL PLATES PER 520 CMR 14.00 EXCAVATION AND TRENCH SAFETY.
 9. ALL WORK PERFORMED AS PART OF THIS PROJECT SHALL CONFORM TO THE TOWN OF ASHLAND, DEPT. OF PUBLIC WORKS AND ANY OTHER AGENCY WITH AUTHORITY IN THIS AREA.
 10. CONTRACTOR TO MAINTAIN WORK AREA IN A CLEAN CONDITION. NO CONSTRUCTION DEBRIS SHALL BE ALLOWED TO ACCUMULATE WITHIN THE WORK SITE AND NO DIRT, GRAVEL, ETC. SHALL BE ALLOWED TO ACCUMULATE ON THE PUBLIC RIGHT-OF-WAY.
 11. AREAS OUTSIDE THE LIMITS OF PROPOSED WORK DISTURBED BY THE CONTRACTOR'S OPERATIONS SHALL BE RESTORED BY THE CONTRACTOR TO THEIR ORIGINAL CONDITION AT THE CONTRACTOR'S EXPENSE.


LEGEND

U.P.	UTILITY POLE
HYDRANT	HYDRANT
WATER SHUT OFF	WATER SHUT OFF
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CATCH BASIN (CB)	CATCH BASIN (CB)
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BOLLARD	BOLLARD
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CONC.	CONCRETE
PVC	POLYVINYL CHLORIDE PIPE
ROP	REINFORCED CONCRETE PIPE
INV.	INVERT
x164.0	SPOT GRADE
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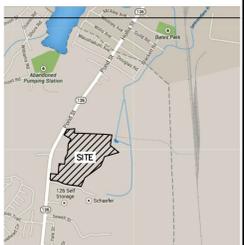


TOTAL SOLAR PANELS = 7,984 PANELS

P:\2015 PROJECTS\2015-017 BUTTERFIELD DR. ASHLAND (SOLAR)\DWG_ENGINEERING\15-017 C3.0 SITE PLAN & COVER SHEET.DWG

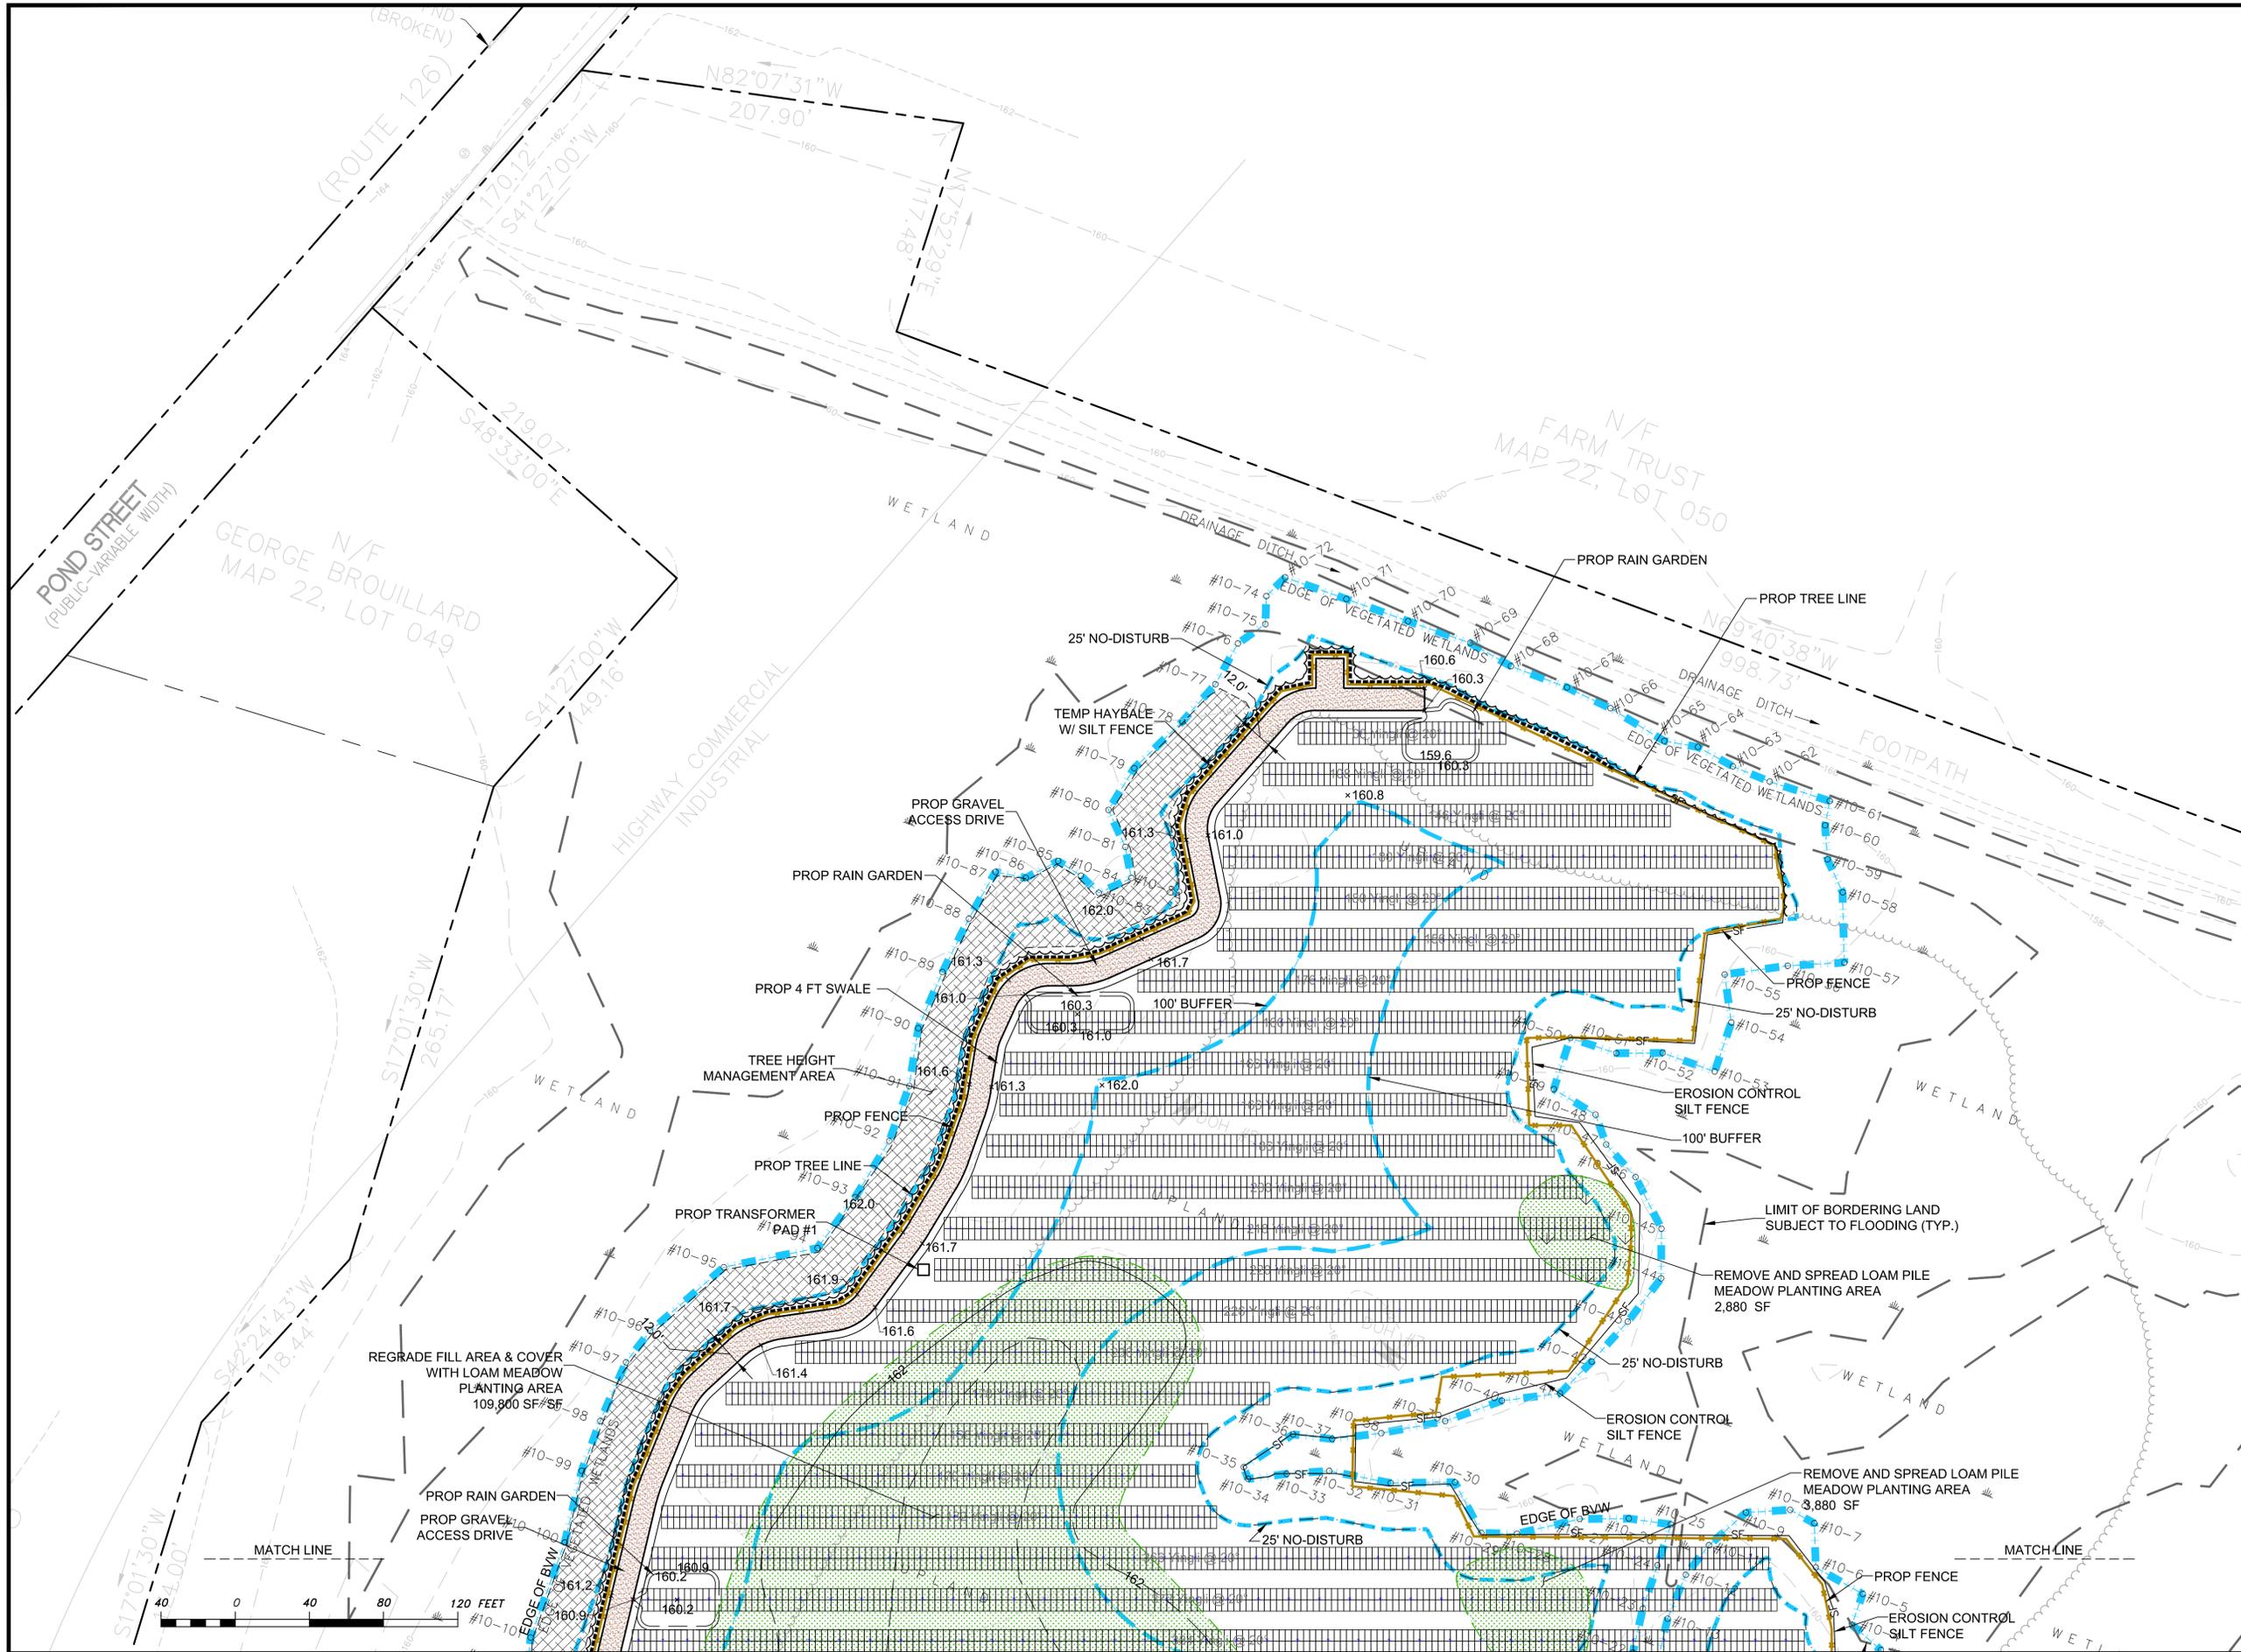

~ LOCUS MAP ~
NTS



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Date:	9-14-2015
Scale:	1"=40'
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Checked by:	SBS
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10/8/2015	PANELS & DRIVEWAY LAYOUT
DATE:	ACTION

SHEET
C3.1

SOIL TEST INFORMATION

BUTTERFIELD DRIVE, ASHLAND
DATE OF TESTS: NOVEMBER 1, 2013

SOILS EVALUATOR: WAYNE KEEFNER, DESIGN CONSULTANTS INC.
(SE#1189, SINCE 1997)

LEGEND:










ESHW= ESTIMATED SEASONAL HIGH GROUNDWATER
WPF= WEEPING FROM PIT FACE
SWH= STANDING WATER IN THE HOLE
DOH=DEEP OBSERVATION HOLE

▽ = SEASONAL HIGH GROUNDWATER

* DOH-1 WAS ABANDONED DUE TO WHAT APPEARED TO BE A BURIED FOUNDATION.


* ESHGW IS UNKNOWN IN DOH-2. MOTTLES ARE ABOVE A HORIZON, NOT YET DEFINED IN FILL LAYER.

* DOH-10 WAS ABANDONED DUE TO FILL PRESENT TO A DEPTH OF 8'.

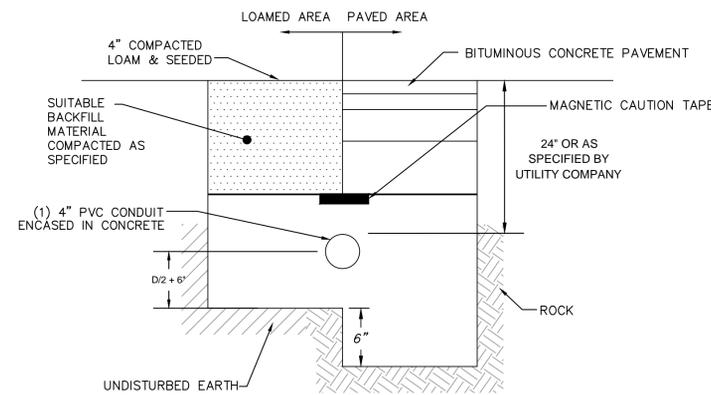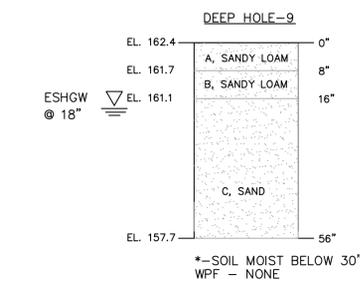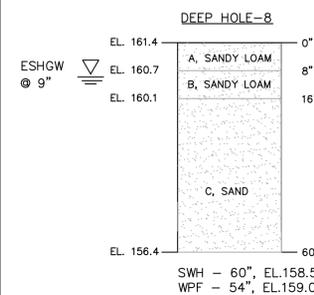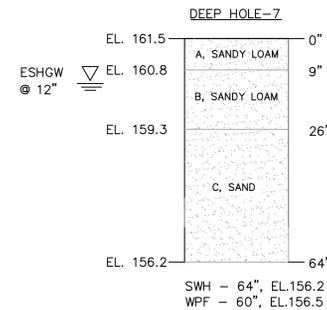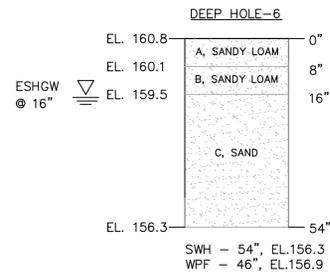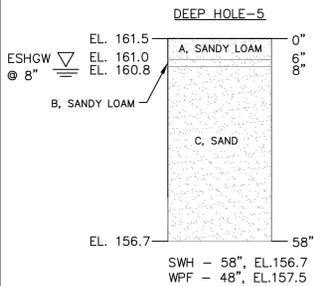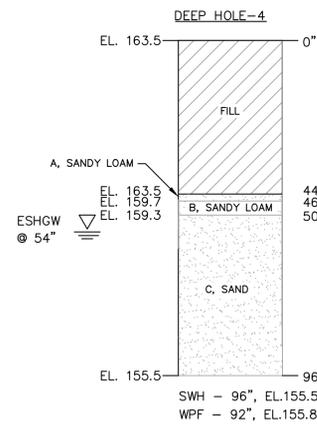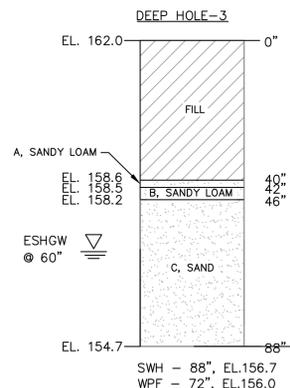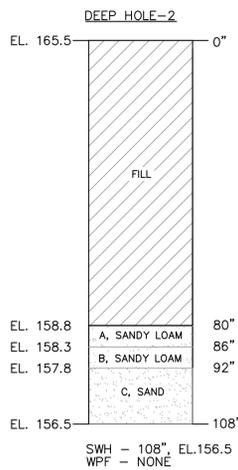

NOTE:
FINAL SIZE, LOCATION AND NUMBER OF CONDUITS SHALL BE DETERMINED BY THE SERVICE PROVIDER.

TYPICAL ELECTRIC & COMMUNICATIONS TRENCH
NOT TO SCALE

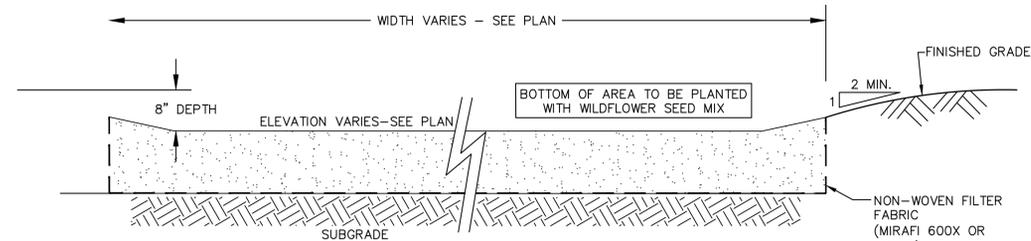

NOTE:
SEE PLAN DETAIL AND SCHEDULE FOR PLANTING DETAIL


RAIN GARDEN DETAIL
NOT TO SCALE

SOIL MIX SPECIFICATIONS


THE SOIL MIX FOR RAIN GARDEN AREAS SHALL BE A MIXTURE OF SAND COMPOST AND SOIL.
0-40% SAND,
0-20-30% TOPSOIL, AND
0-30-40% COMPOST.

THE SOIL MIX MUST BE UNIFORM, FREE OF STONES, STUMPS, ROOTS OR SIMILAR OBJECTS LARGER THAN 2 INCHES. CLAY CONTENT SHOULD NOT EXCEED 5%. SOIL PH SHOULD GENERALLY BE BETWEEN 5.5-6.5, A RANGE THAT IS OPTIMAL FOR MICROBIAL ACTIVITY AND ADSORPTION OF NITROGEN, PHOSPHORUS, AND OTHER POLLUTANTS.


USE SOILS WITH 1.5% TO 3% ORGANIC CONTENT AND MAXIMUM 500-PPM SOLUBLE SALTS. THE SAND COMPONENT SHOULD BE GRAVELLY SAND THAT MEETS ASTM D 422.

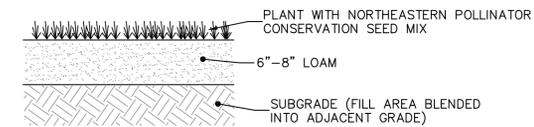

NEW PLANTED AREA SECTION
NOT TO SCALE

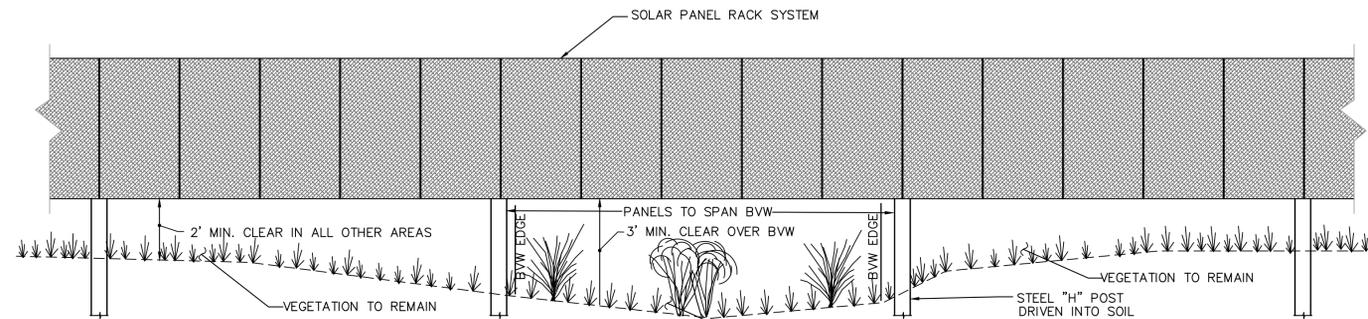

WETLAND FINGER CROSSING DETAIL
NOT TO SCALE

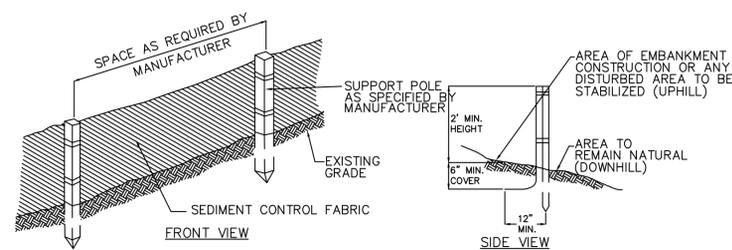

NOTES:


1. THE GEOTEXTILE FABRIC SHALL MEET THE DESIGN CRITERIA FOR BEST MANAGEMENT PRACTICE FOR SILT FENCES.
2. THE HEIGHT OF THE BARRIER SHALL NOT EXCEED 36 INCHES.
3. WHEN JOINTS ARE NECESSARY, FILTER CLOTH SHALL BE SPliced TOGETHER ONLY AT A SUPPORT POST, WITH A MINIMUM 6-INCH OVERLAP, AND SECURELY SEALED. SEE MANUFACTURER'S RECOMMENDATIONS.
4. POSTS SHALL BE SPACED A MAXIMUM OF 10 FEET APART AT THE BARRIER LOCATION AND DRIVEN SECURELY INTO THE GROUND (MINIMUM OF 16 INCHES). WHEN EXTRA STRENGTH FABRIC IS USED WITHOUT THE WIRE SUPPORT FENCE, POST SPACING SHALL BE AS MANUFACTURER RECOMMENDS.
5. A TRENCH SHALL BE EXCAVATED APPROXIMATELY 6 INCHES WIDE AND 6 INCHES DEEP ALONG THE LINE OF POSTS AND UPSLOPE FROM THE BARRIER IN ACCORDANCE WITH RECOMMENDATIONS.
6. THE FABRIC SHALL NOT EXTEND MORE THAN 36 INCHES ABOVE THE ORIGINAL GROUND SURFACE, AND WILL EXTEND TO A MINIMUM OF 8 INCHES INTO THE TRENCH. FILTER FABRIC SHALL NOT BE STAPLED INTO EXISTING TREES.
7. THE TRENCH SHALL BE BACKFILLED AND THE SOIL COMPACTED OVER THE FILTER FABRIC.
8. FILTER BARRIERS SHALL BE REMOVED WHEN THEY HAVE SERVED THEIR USEFUL PURPOSE, BUT NOT BEFORE THE UPSLOPE AREA HAS BEEN PERMANENTLY STABILIZED.
9. FILTER BARRIERS SHALL BE INSPECTED IMMEDIATELY AFTER EACH RAINFALL, AND AT LEAST DAILY DURING PROLONGED RAINFALL, ANY REQUIRED REPAIRS SHALL BE MADE IMMEDIATELY.
10. SHOULD THE FABRIC DECOMPOSE OR BECOME INEFFECTIVE PRIOR TO THE END OF THE EXPECTED USABLE LIFE AND THE BARRIER STILL BE NECESSARY, THE FABRIC SHALL BE REPLACED PROMPTLY.
11. SEDIMENT DEPOSITS SHOULD BE REMOVED WHEN THEY REACH APPROXIMATELY ONE-THIRD THE HEIGHT OF THE BARRIER.
12. ANY SEDIMENT DEPOSITS REMAINING IN PLACE AFTER THE SILT FENCE OR FILTER BARRIER IS NO LONGER REQUIRED, SHALL BE DRESSED TO CONFORM TO THE EXISTING GRADE, PREPARED AND SEEDED.

TEMPORARY CONSTRUCTION SILT FENCE
NOT TO SCALE

LOCUS MAP

Prepared by:
Design Consultants, Inc.
CIVIL ENGINEERS AND LAND SURVEYORS
120 Middlesex Avenue, Suite 207
Somerville, MA 02145
617-776-3359; 617-776-7710

Prepared for:
LODESTAR ENGERY, LLC
3 ELLSWORTH PLACE
SUITE 122
AVON, CT, 06001

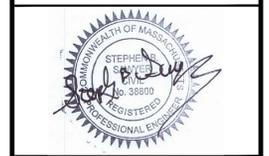



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CENTAURUS SOLAR
IN
ASHLAND, MA

Sheet Title:
SITE DETAILS I


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Scale:	N.T.S.
Drawn by:	SSW
Checked by:	SBS
Proj. #	2015-017

10/8/2015	PANELS & DRIVEWAY LAYOUT
DATE:	ACTION


SHEET
C4.0

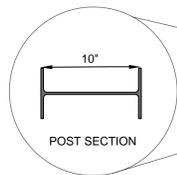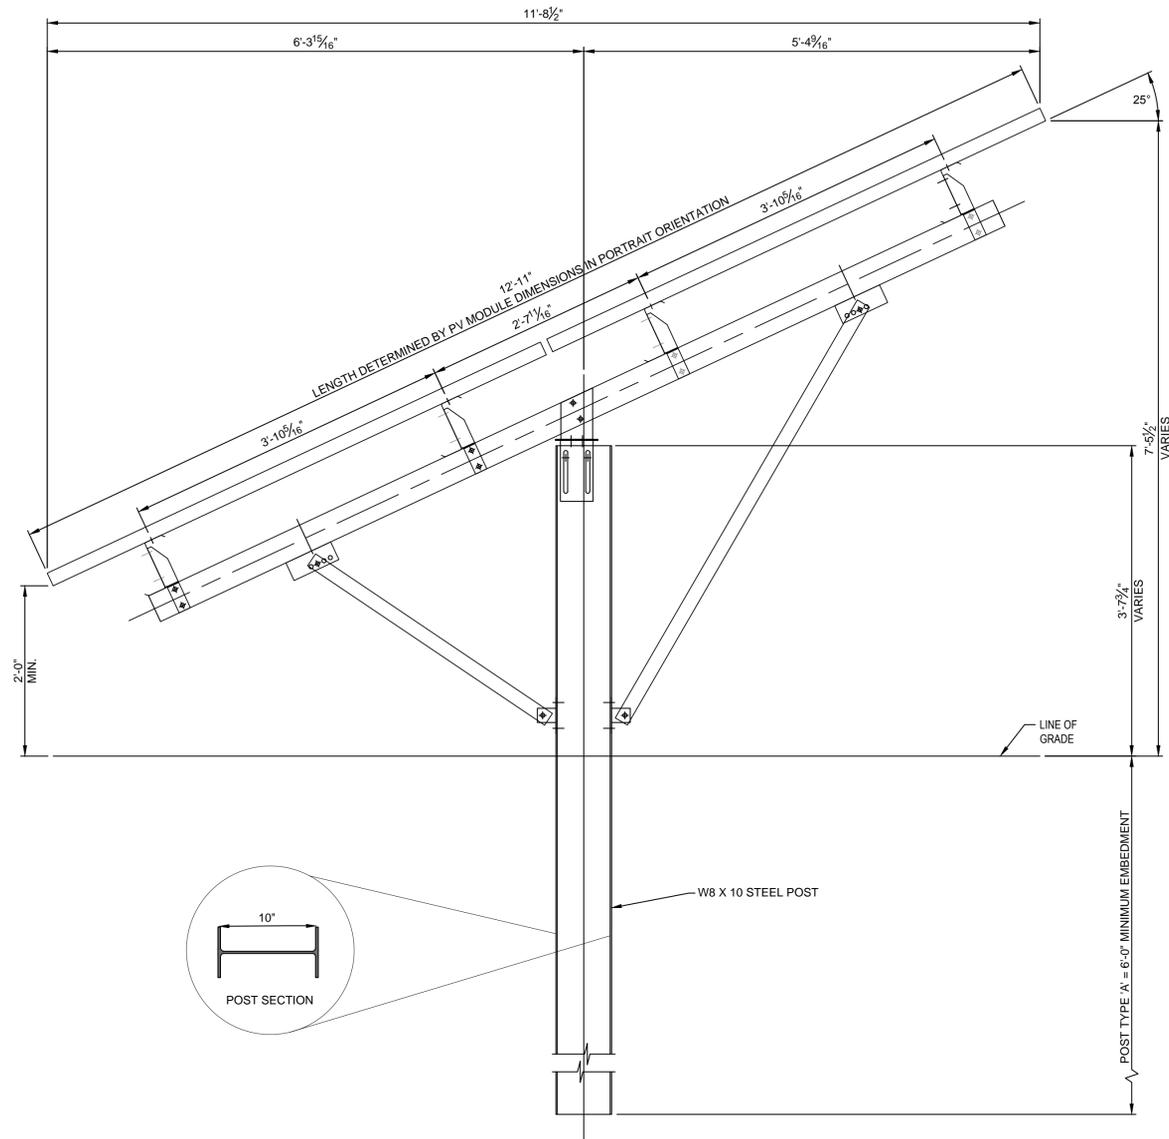


SOLAR PANEL AND PILE SUPPORT SECTION
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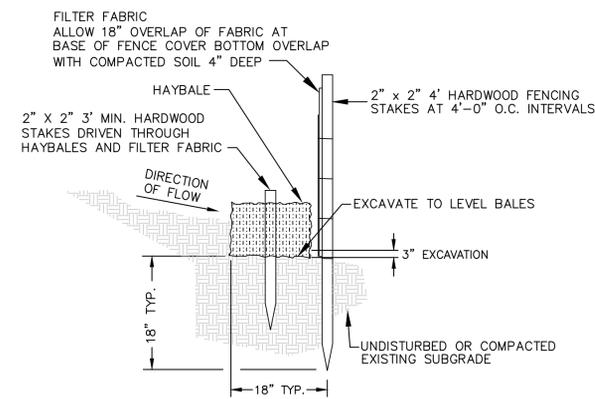
GRAVEL DRIVE
NOT TO SCALE

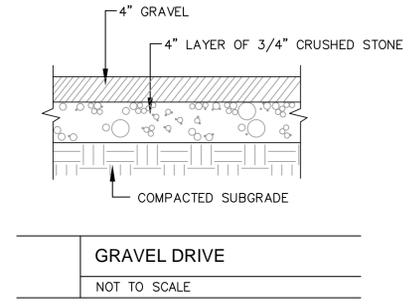


SOLAR ARRAY SPACING & RACKING
NOT TO SCALE

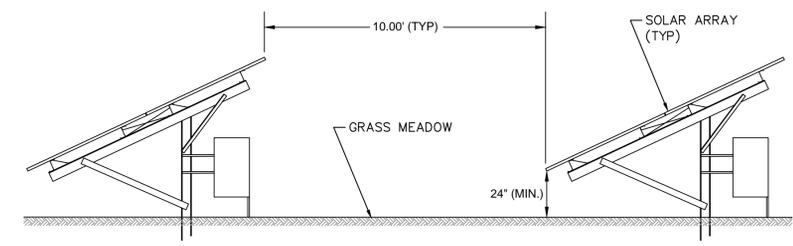

PROPOSED GRAVEL ACCESS DRIVE
NOT TO SCALE

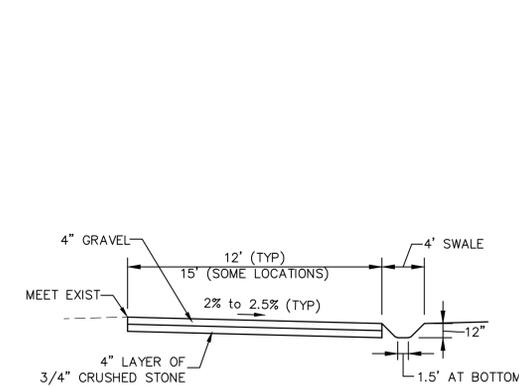

HAYBALE WITH SILT FENCE
NOT TO SCALE

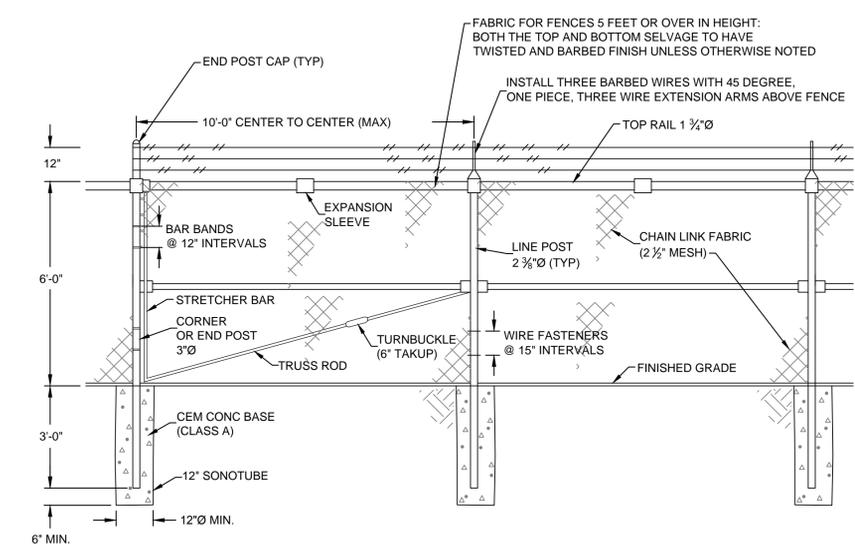


NOTES: ALL FENCE MATERIALS SHALL BE HOT-DIPPED GALVANIZED

CHAIN LINK FENCE
NOT TO SCALE

~ LOCUS MAP ~
N.T.S.

Prepared by:
Design Consultants, Inc.
CIVIL ENGINEERS and LAND SURVEYORS
120 Middlesex Avenue, Suite 20
Somerville, MA 02145
617-776-3300 / 617-776-7710

Prepared for:
LODESTAR ENRGY, LLC
3 ELLSWORTH PLACE
SUITE 122
AVON, CT, 06001

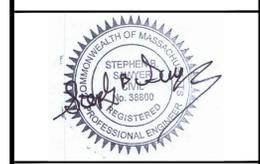

Project Title:
CENTAURUS SOLAR
IN
ASHLAND, MA

Sheet Title:
SITE DETAILS II

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10/8/2015 PANELS & DRIVEWAY LAYOUT
DATE: ACTION

SHEET C4.1