NEAL LOT A

ARCHITECTURAL ABBREVIATIONS

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ABV	ABOVE	D	DRAIN	FRT	FIRE RESISTANT TREATED	М	METER	PSF	POUNDS PER SQUARE FOOT	ТВ	TACK BOARD	
ACOL		DBL	DOUBLE	FT	FOOT	MAS	MASONRY	PSI	POUNDS PER SQUARE INCH	TOC	TOP OF CURB	
ADJ	ADJUSTABLE	DEMO	DEMOLISH, DEMOLITION	FURR	FURRING	MAX	MAXIMUM	PT	PRESSURE TREATED	TOSC	TOP OF STRUCTURAL STEEL	
AFF	ABOVE FINISH FLOOR	DEPT	DEPARTMENT	FV	FIELD VERIFY	MDF	MEDIUM DENSITY FIBER BOARD	• •		TEL	TELEPHONE	
ALUM	ALUMINUM		DRINKING FOUNTAIN	FWC	FABRIC WALL COVERING	MED	MEDIUM	QT	QUARRY TILE	THK	THICK	
ALT	ALTERNATE	DIA or Ø	DIAMETER	1.00	TABING WALL COVERING	MEMB	MEMBRANE	QTB	QUARRY TILE BASE	ТОВ	TOP OF BEAM	
ANOE		DIA OI Ø	DIMENSION	GA	GAUGE	MTL	METAL	QID	QUARRY TILL DAGE	ТОР	TOP OF PAVEMENT	
		DIV	DIVISION	GALV	GAUGE GALVANIZED		MANUFACTURER	DI	RIGER		TOP OF PAVEMENT TOP OF MASONRY	
APPR		DIV				MFGR		RI	RISER	TOM		
AWP	ACOUSTICAL WALL PANEL	DL	DEAD LOAD	GB	GRAB BAR	MH	MANHOLE	R	RADIUS	TOS	TOP OF STEEL (BOTTOM OF ROOF DECK)	
		DN	DOWN	GC	GENERAL CONTRACTOR	MIN	MINIMUM	RB	RUBBER BASE	TP	TOILET PARTITION	
BD	BOARD	DS	DOWN SPOUT	GCLU	GLAZED CMU	MISC	MISCELLANEOUS	RCP	REFLECTED CEILING PLAN	TV	TELEVISION	
BLDG	BUILDING	DSP	DRY STAND PIPE	GI	GALVANIZED IRON	MM	MILLIMETER	RD	ROOF DRAIN	TYP	TYPICAL	
BOT	BOTTOM	DTL	DETAIL	GL	GLASS	MO	MASONRY OPENING	REF	REFERENCE	TZ	TERRAZZO	
BW	BOTH WAYS	DWG	DRAWING	GLB	GLASS BLOCK	MOD	MODULAR	REFR	REFRIGERATOR	TZB	TERRAZZO BASE	
BM	BENCH MARK			GMT	GLASS MOSAIC TILE	MTD	MOUNT(ED) (ING)	REINF	REINFORCING			
		F	EAST	GMTW	GLASS MOSAIC TILE WALL	MUL	MULLION	REQ	REQUIRE(D) (ING)	UC	UNDERCUT	
C	CHANNEL	EA	EACH	GR	GRADE	MOL	MOLLION	REV	REVISION	UNO	UNLESS OTHERWISE NOTED	
	CUBICAL CURTAIN		EPOXY FLOOR	GYP	GYPSUM	N	NORTH	RH	RIGHT HAND	USC	UNDER SEPARATE CONTRACT	
CC			EPOXY FLOOR BASE	GYP BD	GYPSUM BOARD		NATURAL	RM		030		
CK	CORK	EFB		GTF BD	GTFSUM BOARD	NAT			ROOM(S)			
CAB	CABINET	EJ	EXPANSION JOINT	HC	HOLLOW CORE	NIC	NOT IN CONTRACT	ROW	RIGHT OF WAY	VAR	VARNISH	
CB	CHALK BOARD	EG	END GUARD	HDR	HEADER	NO or #	NUMBER	RVWC	RIGID VINYL WALL COVERING	VB	VAPOR BARRIER	
CFCI	CONTRACTOR FURNISH CONTRACTOR INSTALL	EL	ELEVATION		HARDWARE	NOM	NOMINAL			VB	VINYL BASE	
CFOI	CONTRACTOR FURNISH OWNER INSTALL	ET	EPOXY TERRAZZO FLOOR	HDW		NRC	NOISE REDUCTION COEFFICIENT	S	SOUTH	VCT	VINYL COMPOSITION TILE	
CFT	CUBIC FOOT	ETB	EPOXY TERRAZZO BASE	HDWD	HARDWOOD	NTS	NOT TO SCALE	SB	SPLASH BLOCK	VERT	VERTICAL	
CG	CORNER GUARD	ELECT	ELECTRICAL	HGT	HEIGHT			SC	SOLID CORE	VEST	VESTIBULE	
CL, 🗲	CENTER LINE	EM	ENTRANCE MAT	HM	HOLLOW METAL	OC	ON CENTER	SCHED	SCHEDULE	VT	VINYL TILE	
CLG	CEILING	EMER	EMERGENCY	HORIZ	HORIZONTAL	OD	OUTSIDE DIAMETER	SECT	SECTION	VTR	VENT THROUGH ROOF	
CI	CAST IRON	ENCL	ENCLOSURE	HP	HIGH POINT	OFD	OVERFLOW ROOF DRAIN	SHR	SHOWER	VWC	VINYL WALL COVERING	
CLO	CLOSET	EP	EPOXY PAINT	HR	HANDRAIL	OFF	OFFICE	SIM	SIMILAR			
	CLEAR	EQ	EQUAL	HVAC	HEATING VENTILATION AIR CONDITIONING	OFOI	OWNER FURNISH OWNER INSTALL	SPECS	SPECIFICATION(S)	۱۸/	WEST	
CLR										vv		
CMP	CROWN MOLDING PAINTED	EQUIP	EQUIPMENT	ID	INSIDE DIAMETER	OFCI	OWNER FURNISH CONTRACTOR INSTALL	SPK	SPEAKER	W/	WITH	
CMS	CROWN MOLDING STAINED	EWC	ELECTRIC WATER COOLER	INCL	INCLUDING	OVH	OVERHEAD	SQ	SQUARE	WBP	WOOD BASE PAINTED	
CMT	CERAMIC MOSAIC TILE	EXP	EXPANSION	INSUL	INSULATION	OH	OPPOSITE HAND	SS	STAINLESS STEEL	WBS	WOOD BASE STAINED	
CMTE	CERAMIC MOSAIC TILE BASE	EXIST	EXISTING	INT	INTERIOR	OPNG	OPENING	ST	STONE	WC	WATER CLOSET	
CMTV		EXT	EXTERIOR	IPS	IRON PIPE SIZE	OPP	OPPOSITE	STC	STONE COUNTERTOP	WD	WOOD	
CMU	CONCRETE MASONRY UNIT			10				STW	STONE WALL	WDS	WOOD STAINED	
CO	CASED OPENING	FA	FIRE ALARM	.1	JOIST	Р	PAINT(ED)	STB	STONE BASE	WIN	WINDOW	
COL	COLUMN	FBO	FURNISHED BY OTHERS	JAN	JANITOR	PARA	PARALLEL	STC	STAINED CONCRETE	W/O	WITHOUT	
CONC	CONCRETE	FD	FLOOR DRAIN	JAN		PBD	PARTICLE BOARD	STD	STANDARD	WP	WOOD PANELING PREFINISHED	
CONS			FIRE EXTINGUISHER	JI	JOINT	PCF	POUNDS PER CUBIC FOOT	STL	STEEL		WOOD PANELING PAINTED	
CONS	CHAIR RAIL	FEC	FIRE EXTINGUISHER CABINET	KIT	KITCHEN		PERFORATED	STO	STEEL		WOOD PANELING FAINTED	
		FEC		KIT		PERF				WPS		
CORF	R CORRIDOR	FFE	FINISH FLOOR ELEVATION	KO	KNOCKOUT	PERI	PERIMETER	STRUCT	STRUCTURAL	WS	WATER STOP	
CPT	CARPET	FHC	FIRE HOSE CABINET			PFL	POUNDS PER LINEAR FOOT	SV	SHEET VINYL	WSCT	WAINSCOT	
CPTB	CARPET BASE	FHVC	FIRE HOSE VALVE CABINET	L	LENGTH/LONG	PL	PLATE	SVB	SHEET VINYL COVED BASE	WT	WEIGHT	
СТ	CERAMIC TILE	FE	FINISHED END	LAB	LABORATORY	PLAM	PLASTIC LAMINATE	SYM	SYMMETRICAL	WWF	WELDED WIRE FABRIC	
CTB	CERAMIC TILE BASE	FLR	FLOOR	LAM	LAMINATE	PLAS	PLASTER	SYS	SYSTEM			
CTW	CERAMIC TILE WALL	FOC	FACE OF CONCRETE	LH	LEFT HAND	PLYWD	PLYWOOD					
CTSK	COUNTERSINK	FOF	FACE OF FINISH	LI	LINOLEUM	PP	PORCELAIN PAVER					
CYD	CUBIC YARD	FOM	FACE OF MASONRY	LIB	LINOLEUM COVED BASE	PPB	PORCELAIN PAVER BASE					
	-	FOS	FACE OF STUDS			PPW	PORCELAIN PAVER WALL					
		FPRF	FIREPROOFING	LL	LIVE LOAD	PR	PAIR					
						111						

DRAWING INDEX - PERMIT

ARCHITECTURAL				
A0.00	COVER SHEET			
A0.1	NOTES			
A1.0	ACCESSIBILITY PLAN			
A1.1	LOT PLAN			
A1.2	SITE PLAN			
A1.4	IMPERVIOUS COVER			
A3.1	FIRST FLOOR- BLDG A			
A3.2	SECOND FLOOR - BLDG A			
A3.4	FIRST FLOOR - BLDG B			
A3.5	SECOND FLOOR - BLDG B			
A4.0	MCMANSION ELEVATIONS			
A4.6	3D SECTIONS			
A6.0	WINDOWS & DOORS BLDG 1			
A6.1	WINDOWS & DOORS BLDG 2			




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REVISIONS NO. DESCRIPTION

DATE



NEAL LOT A

3409 NEAL ST AUSTIN , TX 78702 COVER SHEET

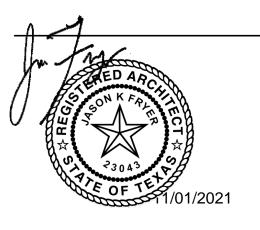SHEET	A0.00
SCALE	1/4" = 1'-0"
ISSUE DATE	08/16/21
JOB #	2015
DRAWN BY	TL

GENERAL PROJECT NOTES

CONSTRUCTION DOCUMENTS MAKE NO WARRENT AS TO EXISTING CONDITIONS. CONTRACTOR IS RESPONSIBLE FOR FIELD VERIFYING ALL EXISTING CONSTRUCTION AND FRAMING PRIOR TO DEMOLITION AND CONSTRUCTION. CONTRACTOR IS RESPONSIBLE FOR COORDINATING ALL NEW CONSTRUCTION WITH EXISTING CONDITIONS.

THE CONTRACTOR SHALL FURNISH ALL LABOR, MATERIALS, TOOLS, EQUIPMENT, AND RELATED ITEMS REQUIRED TO COMPLETE THE DEMOLITION WORK AS INDICATED BY THE CONTRACT DOCUMENTS.

3. CONTRACTOR TO VERIFY ALL DIMENSIONS.

4. ALL ACCESSIBLE ROUTES (OTHER THAN RAMPS) SHALL NOT EXCEED A SLOPE OF 1:20, AND CROSS SLOPES SHALL NOT EXCEED A SLOPE OF 1:50

THE DRAWINGS INDICATE BUILDING CONDITIONS PER EXISTING DRAWINGS AND ACTUAL PROJECT INVESTIGATION. THE CONTRACTOR SHALL ANTICIPATE POSSIBLE SLIGHT DEVIATION FROM THESE DRAWINGS. REFER TO ARCHITECTURAL & MEP DRAWINGS AND DETAILS FOR EXTENT OF DEMOLITION.

THE CONTRACTOR SHALL SUPERVISE AND DIRECT THE WORK, USING HIS BEST SKILL AND ATTENTION. HE SHALL BE SOLELY RESPONSIBLE FOR ALL MEANS. METHODS, TECHNIQUES, SEQUENCES AND PROCEDURES AND FOR COORDINATING ALL PORTIONS OF THE WORK UNDER THE CONTRACT.

INSTALL TEMPORARY DUST PARTITIONS WITH DOORS FOR CONSTRUCTION ACCESS AROUND AREAS OF WORK SO THAT OPERATIONS IN EXISTING ADJACENT AREAS REMAIN DUST FREE AND ACCESSIBLE TO BUILDING OCCUPANTS. MAINTAIN IN PLACE UNTIL COMPLETION OF CONSTRUCTION.

REMOVE ALL BUILDING PARTS AND/OR OTHER ITEMS TO ALLOW FOR THE INSTALLATION AND CONNECTION OF NEW WORK. COORDINATE THE WORK WITH THE HVAC, PLUMBING AND ELECTRICAL DEMOLITION DRAWINGS.

ARCHITECTURAL SYMBOLS

PROTECT EXISTING VEGETATION, INCLUDING EXISTING TREES DURING CONSTRUCTION. REVEGETATE DAMAGED AREAS ADJACENT TO NEW CONSTRUCTION; CONTRACTOR SHALL MAINTAIN VEGETATED AREAS FOR 3 WEEKS AFTER INITIAL PLANTING

10 REFER TO MECHANICAL, PLUMBING AND ELECTRICAL DRAWINGS FOR OTHER WORK.

11 SEAL ALL PENETRATIONS, NEW AND EXISTING, ABOVE CEILINGS AT RATED FIRE WALLS IN AREAS OF WORK.

GENERAL NOTES

ALL CEILINGS TO BE MINIMUM 8'-0" AFF, UNO ALL CEILINGS TO BE 5/8" GYPSUM, UNO

NEW SMOKE DETECTORS (S) TO BE INSTALLED AS INDICATED & NO CLOSER THAN 3' TO AN AIR SOURCE, PER IRC R314

NEW CARBON MONOXIDE DETECTORS (C) TO BE INSTALLED AS INDICATED & NO CLOSER THAN 3' TO AN AIR SOURCE, PER IRC R315

LOCAL EXHAUST SYSTEMS (E) INDICATED ON PLAN IN BATHROOMS, TO BE VENTED DIRECTLY TO THE OUTDOORS PER IRC R303.3

LIGHT FIXTURES IN CLOSETS TO COMPLY WITH 4003.12

LIGHT SWITCHES & ENVIRONMENTAL CONTROLS MUST BE NO HIGHER THAN 48" ABOVE THE INTERIOR FLOOR LEVEL

STAIR DESIGN CONFIGURATION AND CONSTRUCTION TO COMPLY WITH ALL 2021 IRC

9. ALL DOORS TO BE INSTALLED 4" FROM ADJACENT PERPINDICULAR DOOR, UNO

ARCHITECURAL LINETYPES

REQUIREMENTS.

		CTURAL STINDULS
NEW CONSTRUCTION	X	WALL TAG
EXISTING CONSTRUCTION	100	DOOR TAG
— — — — HIDDEN LINE		WINDOW TAG
1 HOUR FIRE BARRIER	W1 ROOM NAME Length x Width	ROOM TAG
Image: state stat		KEYNOTE
2 HOUR FIRE BARRIER		DEMO KEYNOTE
FIRE/SMOKE PARTITIONS	[?]	
		SPECIAL EQUIPMENT
Image:	<u>1t</u>	PLUMBING FIXTURE
FIRE WALLS 2 HOURS	L-1	LIGHTING FIXTURE
3 HOURS	XXXX-1	FLOOR TAG
	#	GRID
ARCHITECTURAL MATERIALS	<u>/#\</u>	REVISION
	1. A3.01	BUILDING ELEVATION
	1	
	1 A101 1	INTERIOR ELEVATION
	A.F.F. 0'-0"	ELEVATION TAG
INSULATION, RIGID		LEVEL
PLYWOOD		
FINISH GRADE HARDWOOD	(1) (A1.1)	CALLOUT
WOOD FRAMING THROUGH MEMBER WOOD FRAMING	#	SECTION
	#	SECTION

VISITABILITY NOTES

- PER ORDINANCE NO. 20140130-21, IN REFERENCE TO LEVEL 1 BATHROOM.
- MINIMUM CLEAR OPENING OF 30" IS REQUIRED FOR BATHROOMS PER R320.4
- LATERAL 2" X 6" OR LARGER NOMINAL WOOD BLOCKING MUST BE INSTALLED FLUSH WITH STUD EDGES OF BATHROOM WALLS
- THE CENTERLINE OF THE BLOCKING MUST BE 34" FROM AND PARALLEL TO THE INTERIOR FLOOR LEVEL, EXCEPT FOR THE PORTION OF WALL LOCATED DIRECTLY **BEHIND THE LAVATORY**
- ALL ACCESSIBLE ROUTES (OTHER THAN RAMPS) SHALL NOT EXCEED A SLOPE OF 1:20, AND CROSS SLOPES SHALL NOT EXCEED A SLOPE OF 1:50.
- LIGHT SWITCHES AND ENVIRONMENTAL CONTROLS MUST BE NO HIGHER THAN 48 INCHES ABOVE THE INTERIOR FLOOR LEVEL
- OUTLETS AND RECEPTACLES MUST BE A MINIMUM OF 15 INCHES ABOVE THE INTERIOR FLOOR LEVEL, EXCEPT FOR FLOOR OUTLETS AND RECEPTACLES
- VISITABILITY ROUTES MUST BE ACCESSIBLE BY A ROUTE WITH A MINIMUM CLEAR OPENING OF 32 INCHES BEGINING AT THE VISITABLE ENTRANCE

GENERAL WINDOW NOTES


- WINDOWS MUST HAVE GUARDS OR SAFETY GLAZING IF THEY MEET ONE OF THE FOLLOWING FOUR (4) CONDITIONS: AREA OF GLAZING IS 9 SF OR LARGER, SILL HEIGHT IS LESS THAN 18" AFF, HEAD HEIGHT IS MORE THAN 36" AFF AND GLAZING IS WITHIN 36" OF A WALKWAY PER IRC R308.4.3
- WINDOWS WITHIN 24" INCHES OF ALL DOORS AND WITH A SILL LESS THAN 60" TO BE SAFETY GLAZING PER IRC R308.4.2
- ALL OTHER WINDOWS TO HAVE SAFETY GLAZING AS NOTED
- EGRESS WINDOWS TO BE A MINIMUM SIZE OF 20" X 24" / 5.7 SQ FT, (5 SQ FT FOR GRADE LEVEL EGRESS) PER IRC R310
- IF BOTTOM OF THE CLEAR OPENING OF AN OPERABLE WINDOW OPENING IS LOCATED LESS THAN 24 INCHES ABOVE THE FINISH FLOOR AND GREATER THAN 72 INCHES ABOVE THE FINISHED GRADE THE WINDOW OPENING 1. WILL NOT ALLOW 4" DIAMETER SPHERE TO PASS THROUGH THE OPENING OR 2. WILL BE PROVDIED WITH WINDOW OPENING CONTROL DEVICES OR FALL PREVENTION DEVICES

GENERAL STAIR NOTES

- . STAIRS TO COMPLY WITH IRC 2021
- STAIRWAY WIDTH TO BE A MINIMUM OF 36" HANDRAILS SHALL NOT PROJECT MORE THAN 4 1/2" INTO CLEAR WIDTH
- MINIMUM HEADROOM TO BE 6' -8"

EDGES

- 4. STAIRWAY VERTICAL RISE NOT TO EXCEED 12'-7"
- MAXIMUM RISER HEIGHT TO BE 7 3/4" MEASURED VERTICALLY BETWEEN LEADING
- MINIMUM TREAD DEPTH TO BE 10" MEASURED VERTICALLY BETWEEN VERTICAL SURFACES
- LANDINGS ARE REQUIRED AT THE TOP AND BOTTOM OF EACH STAIRWAY -MINIMUM WIDTH AND DEPTH SHALL NOT BE LESS THAN THE MINIMUM WIDTH OF THE STAIR SERVED
- HANDRAILS SHALL BE PROVIDED ON AT LEAST ONE SIDE OF EACH CONTINUOUS STAIR RUN
- HANDRAILS ADJACENT TO WALLS WILL HAVE A MINIMUM OF 1 1/2" CLEAR SPACE **BETWEEN WALL**
- 10 TYPE 1 HANDRAIL: CIRCULAR GRIP SIZE TO HAVE AN OUTSIDE DIAMETER OF 1 1/2" TO 2" - IF NOT CIRCULAR, GRIP TO HAVE A MAXIMUM CROSS SECTION DIMENSION OF 2 1/4" WITH A PERIMETER BETWEEN 4' AND 6 1/4"
- 1 WHERE GUARDRAILS ARE USED AS HANDRAILS AT STAIRS GUARDRAILS SHALL NOT BE LESS THAN 34" AND NO MORE THAN 36" IN HEIGHT
- 12 AT ALL OTHER LOCATIONS WHERE GUARDRAILS ARE LOCATED THEY WILL BE A MINIMUM OF 36" IN HEIGHT
- 13 GUARDRAILS SHALL BE DESIGNED SO A 4" SPHERE SHALL NOT BE ABLE TO PASS

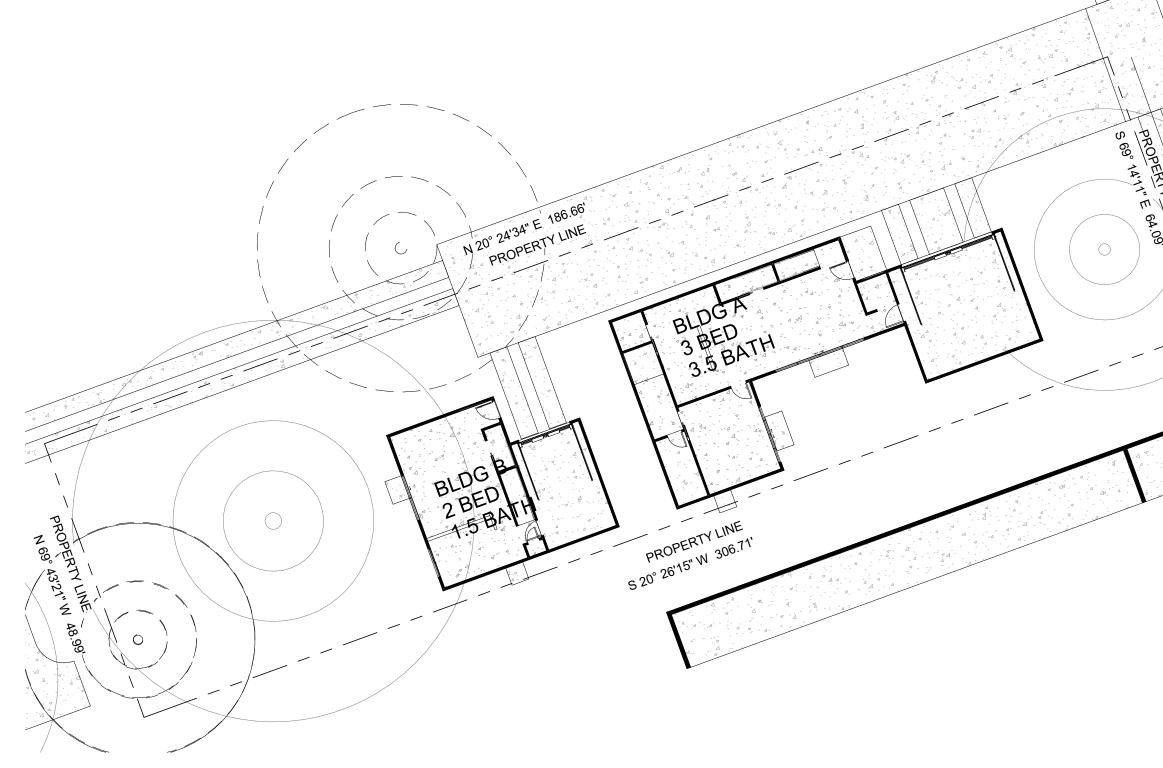

PLAN NORTH TRUE NORTH



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NO. DESCRIPTION

DATE




NEAL LOT A


3409 NEAL ST AUSTIN, TX 78702 NOTES

<u>SCALE (FOR 24" X 3</u>6") SCALE (FOR 11' X 17") HALF INDICATED ISSUE DATE JOB # DRAWN BY



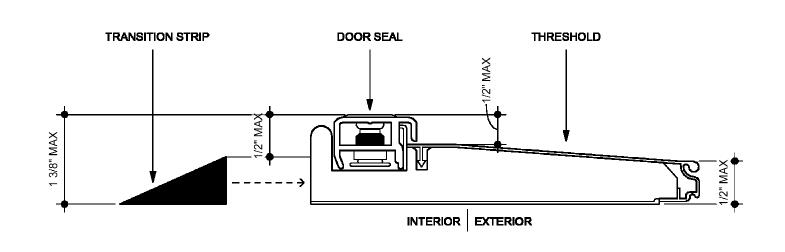


CoA APPROVED THRESHOLD DETAIL

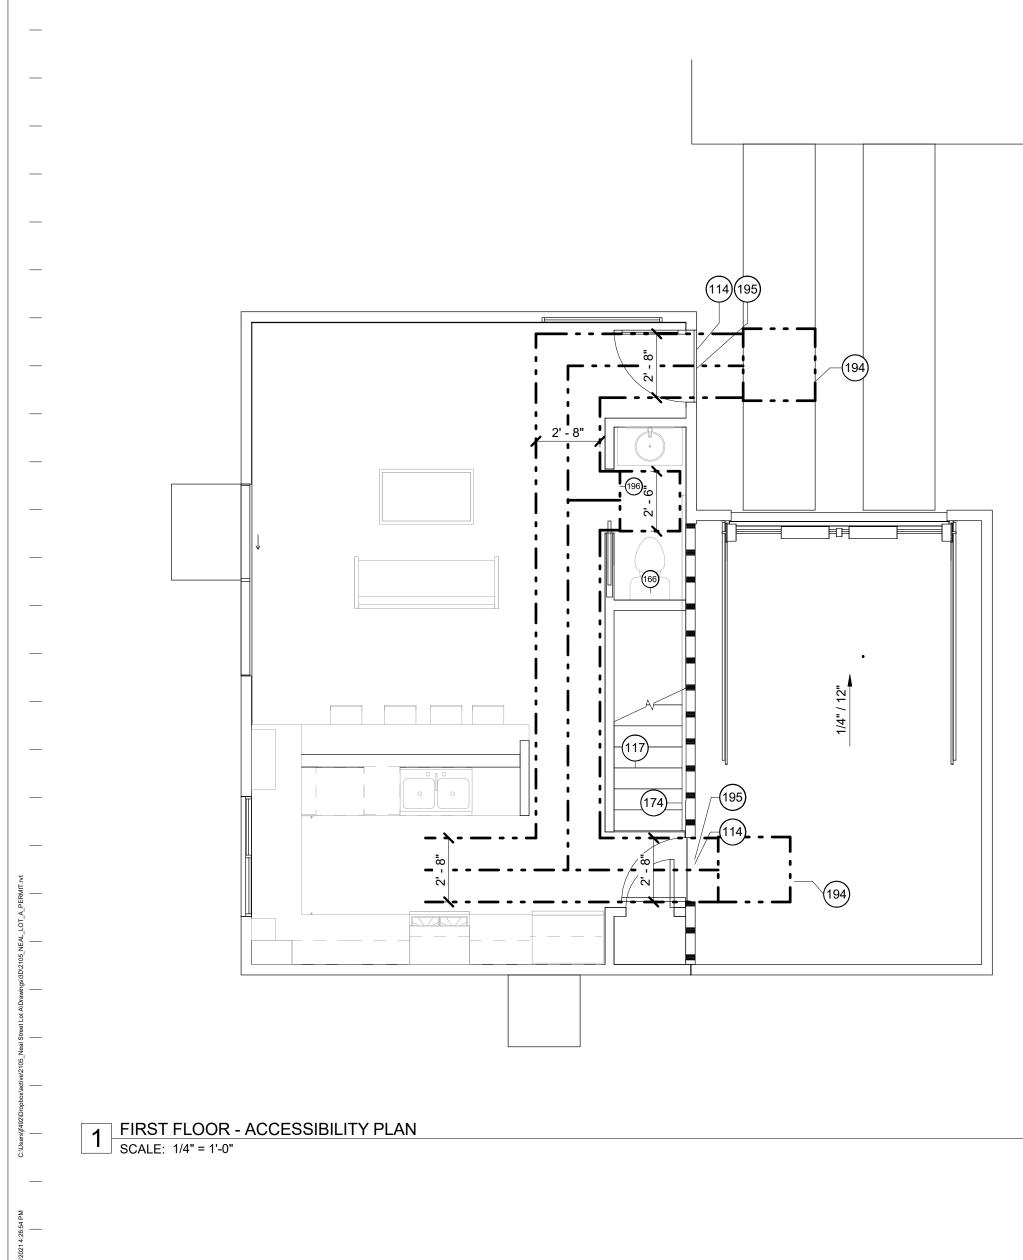

VISITABILITY NOTES

PER ORDINANCE NO. 20140130-21, IN REFERENCE TO LEVEL 1 BATHROOM.

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- ALL ACCESSIBLE ROUTES (OTHER THAN RAMPS) SHALL NOT EXCEED A SLOPE OF 1:20, AND CROSS SLOPES SHALL NOT EXCEED A SLOPE OF 1:50.
- LIGHT SWITCHES AND ENVIRONMENTAL CONTROLS MUST BE NO HIGHER THAN 48 INCHES ABOVE THE INTERIOR FLOOR LEVEL
- OUTLETS AND RECEPTACLES MUST BE A MINIMUM OF 15 INCHES ABOVE THE INTERIOR FLOOR LEVEL, EXCEPT FOR FLOOR OUTLETS AND RECEPTACLES
- VISITABILITY ROUTES MUST BE ACCESSIBLE BY A ROUTE WITH A MINIMUM CLEAR OPENING OF 32 INCHES BEGINING AT THE VISITABLE ENTRANCE

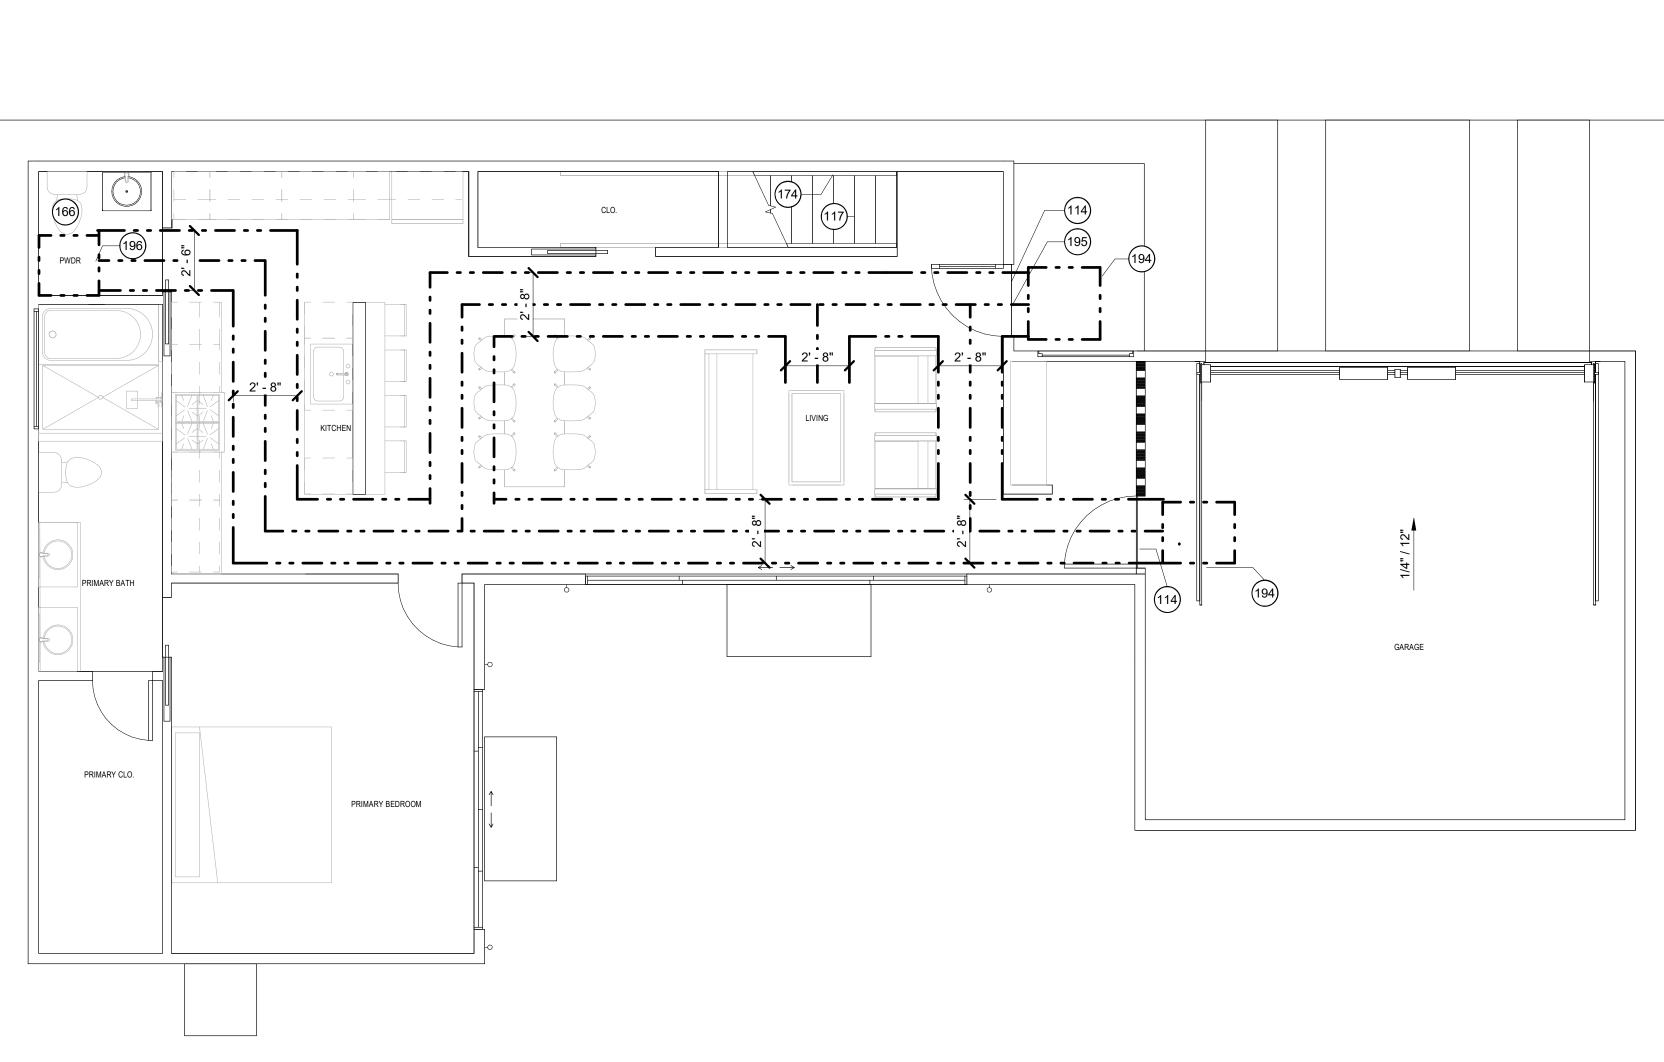

KEYNOTE LEGEND

114 VISITABLE ENTRANCE WITH MIN 32" CLEAR DOOR OPENING. NO STEP THRESHOLD, SLAB TO BE FLUSH AT ENTRYWAYS, STRUCTURAL DOCUMENTS TO COORDINATE WITH ARCHITECTURAL- REFERENCE COA THRESHOLD DETAIL 117 STAIRS TO COMPLY WITH IRC 2021 - REFERENCE GENERAL NOTES MIN 15" CLEAR FROM CENTERLINE OF TOILET TO WALL AND CABINET - IN 166 COMPLIANCE WITH IRC R307.1 AND 2021 UPC - BATHROOM TO EXHAUST TO EXTERIOR - 2X6 NOMINAL WOOD BLOCKING PROVIDED AT 34" CENTERLINE ABOVE FINISHED FLOOR ALONG BATHROOM WALLS, EXCEPT BEHIND TOILET 174 HANDRAILS TO COMPLY WITH IRC 2021 - REFERENCE GENERAL STAIR NOTES 194 LANDING - 3'-0" X 3'-0" 195 PATH OF TRAVEL - 1:50 SLOPE WITH 0 CROSS-SLOPE

196 30" x 30" CLEAR SPACE IN FRONT OF TOILET



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REVISION


DATE

NO. DESCRIPTION




NEAL LOT A

3409 NEAL ST AUSTIN , TX 78702 ACCESSIBILITY PLAN

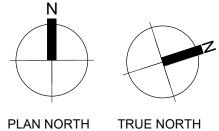


SHEET	A1.0
SCALE (FOR 24" X 36")	As indicated
SCALE (FOR 11' X 17")	HALF INDICATED
ISSUE DATE	08/16/21
JOB #	2015
DRAWN BY	TL

 $[\]neg$

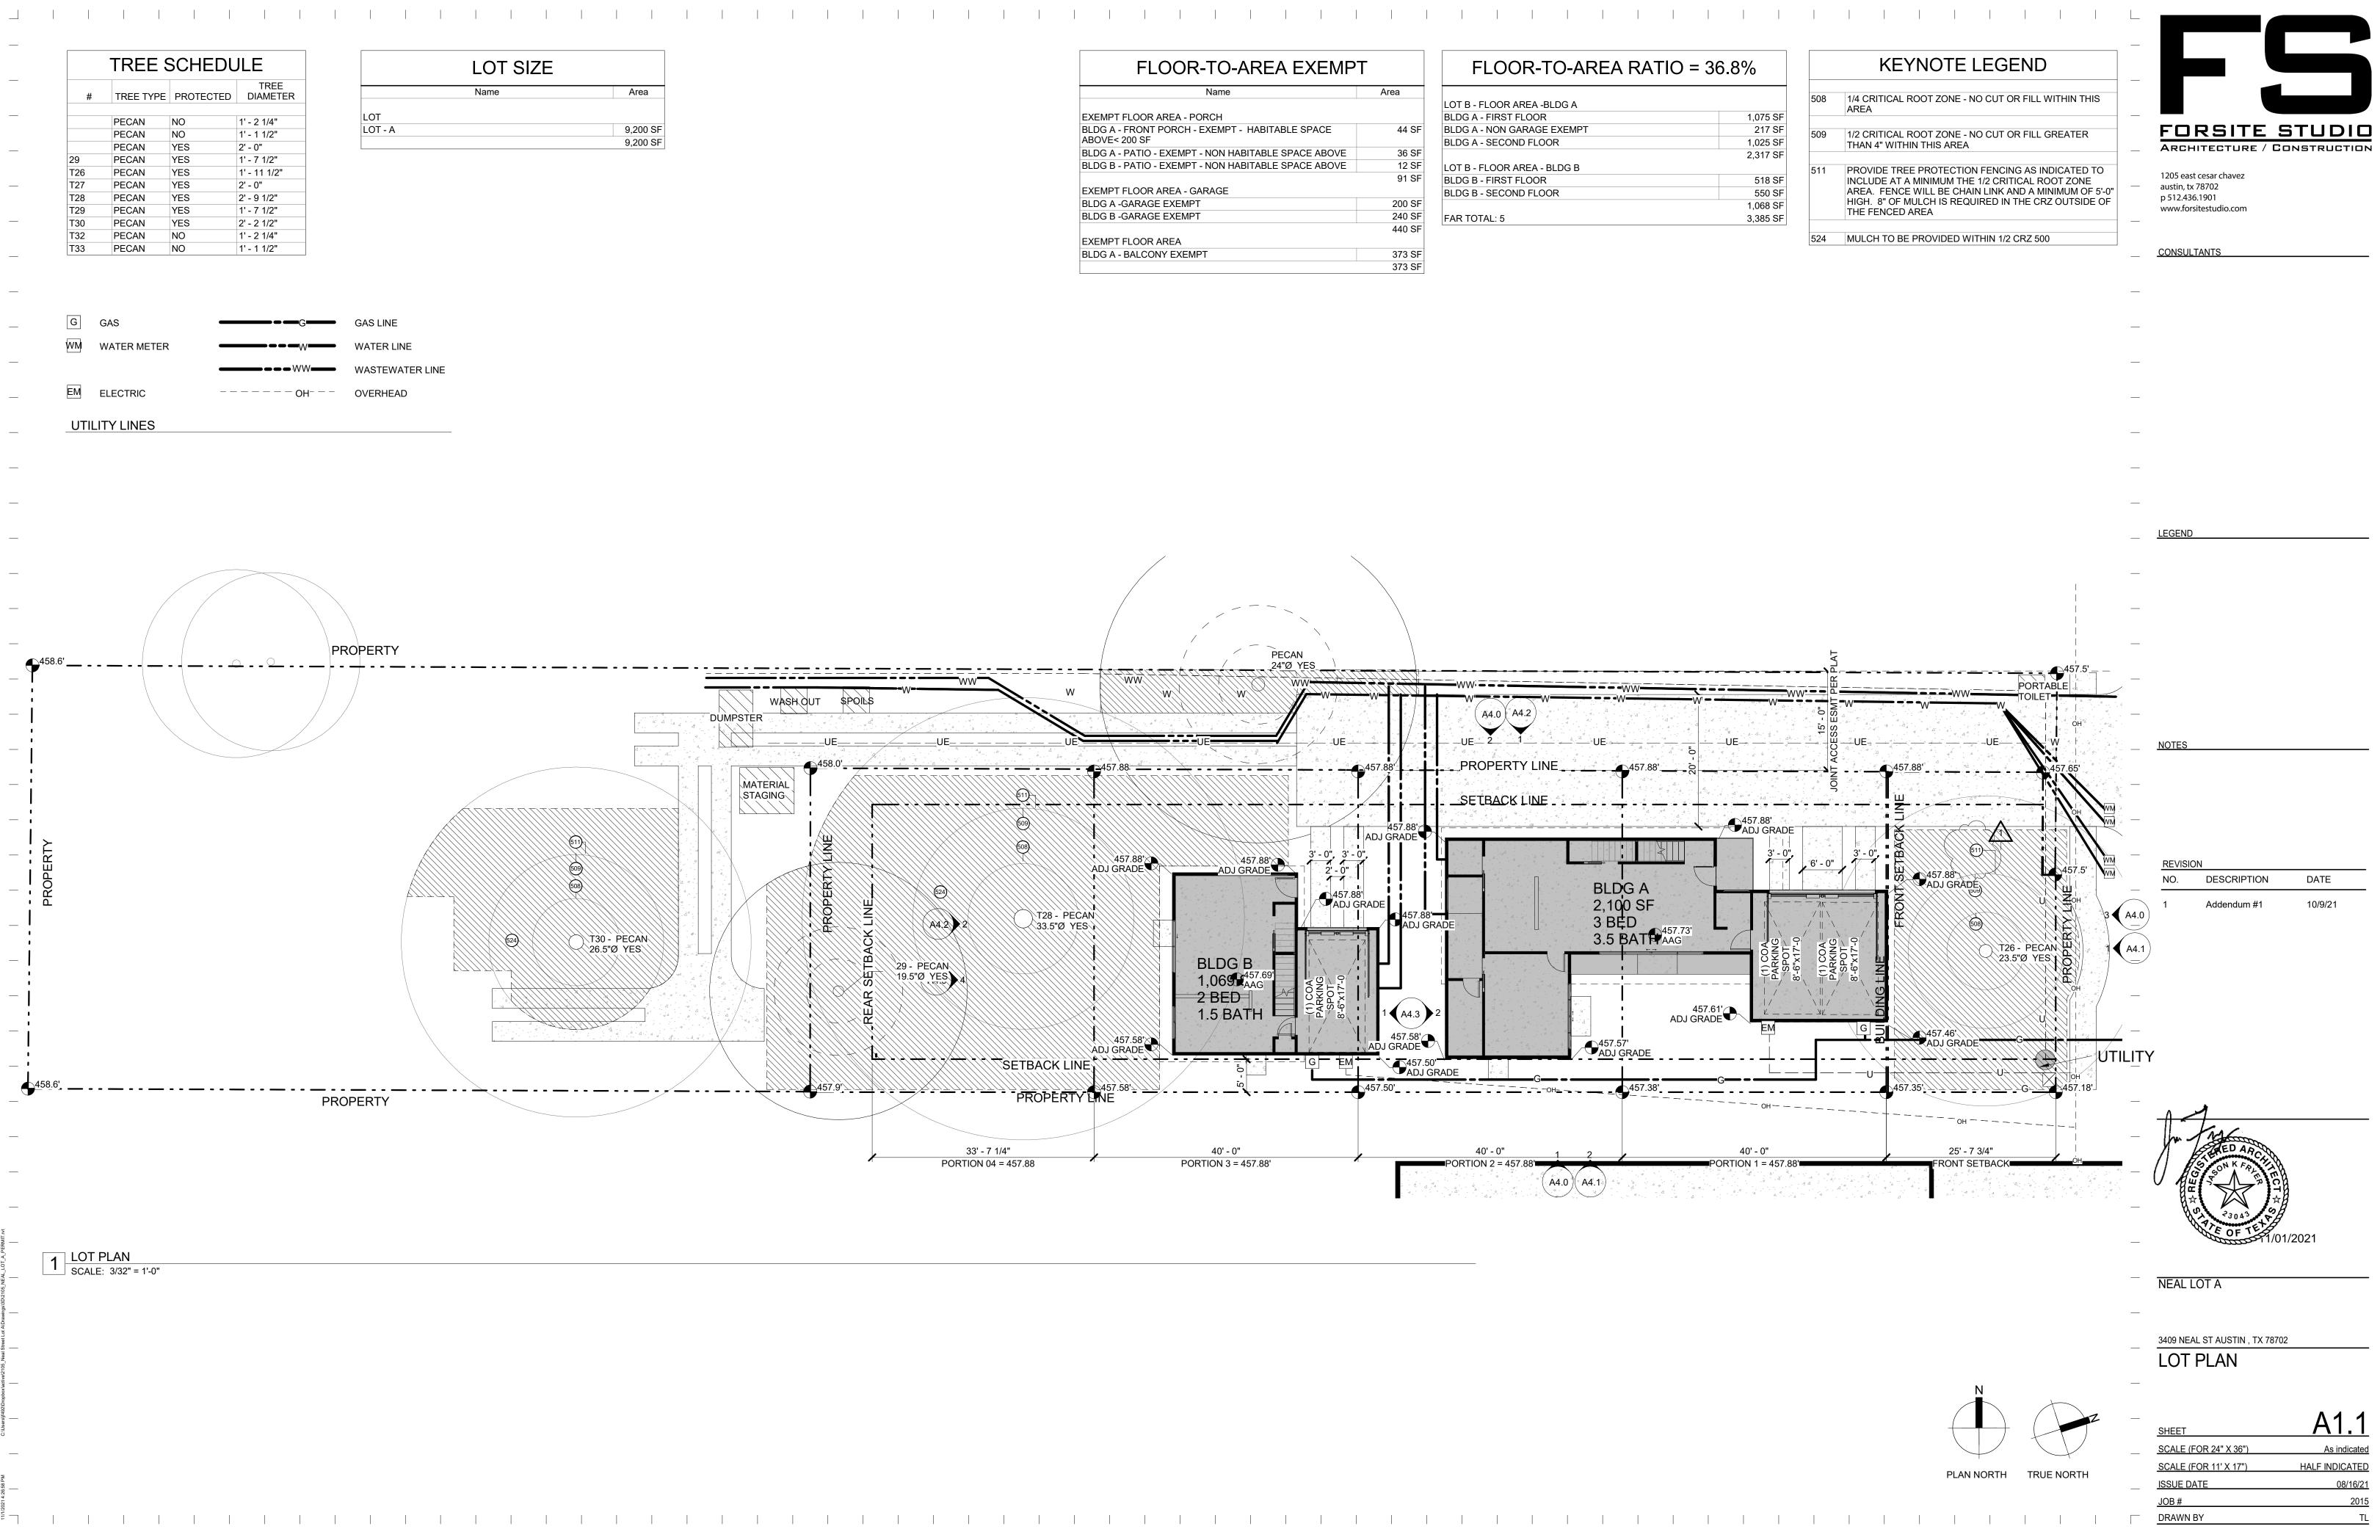

Hamo	/ 104
EXEMPT FLOOR AREA - PORCH	
BLDG A - FRONT PORCH - EXEMPT - HABITABLE SPACE ABOVE< 200 SF	44 SF
BLDG A - PATIO - EXEMPT - NON HABITABLE SPACE ABOVE	36 SF
BLDG B - PATIO - EXEMPT - NON HABITABLE SPACE ABOVE	12 SF
	91 SF
EXEMPT FLOOR AREA - GARAGE	
BLDG A -GARAGE EXEMPT	200 SF
BLDG B -GARAGE EXEMPT	240 SF
	440 SF
EXEMPT FLOOR AREA	
BLDG A - BALCONY EXEMPT	373 SF

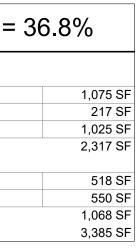

	KEYNOTE LEGEND
508	1/4 CRITICAL ROOT ZONE - NO CUT OR FILL WITHIN THIS AREA
509	1/2 CRITICAL ROOT ZONE - NO CUT OR FILL GREATER THAN 4" WITHIN THIS AREA
511	PROVIDE TREE PROTECTION FENCING AS INDICATED TO INCLUDE AT A MINIMUM THE 1/2 CRITICAL ROOT ZONE AREA. FENCE WILL BE CHAIN LINK AND A MINIMUM OF 5 HIGH. 8" OF MULCH IS REQUIRED IN THE CRZ OUTSIDE (THE FENCED AREA




TREE SCHEDULE						
# TREE TYPE PROTECTED DIAMETER						
PECAN NO 1' - 2 1/4"						
	PECAN	NO	1' - 1 1/2"			
	PECAN	YES	2' - 0"			
29	PECAN	YES	1' - 7 1/2"			
T26	PECAN	YES	1' - 11 1/2"			
T27	PECAN	YES	2' - 0"			
T28	PECAN	YES	2' - 9 1/2"			
T29	PECAN	YES	1' - 7 1/2"			
T30	PECAN	YES	2' - 2 1/2"			
T32	PECAN	NO	1' - 2 1/4"			
Т33	PECAN	NO	1' - 1 1/2"			

G GAS

EM ELECTRIC

GAS LINE WATER LINE


UTILITY LINES,

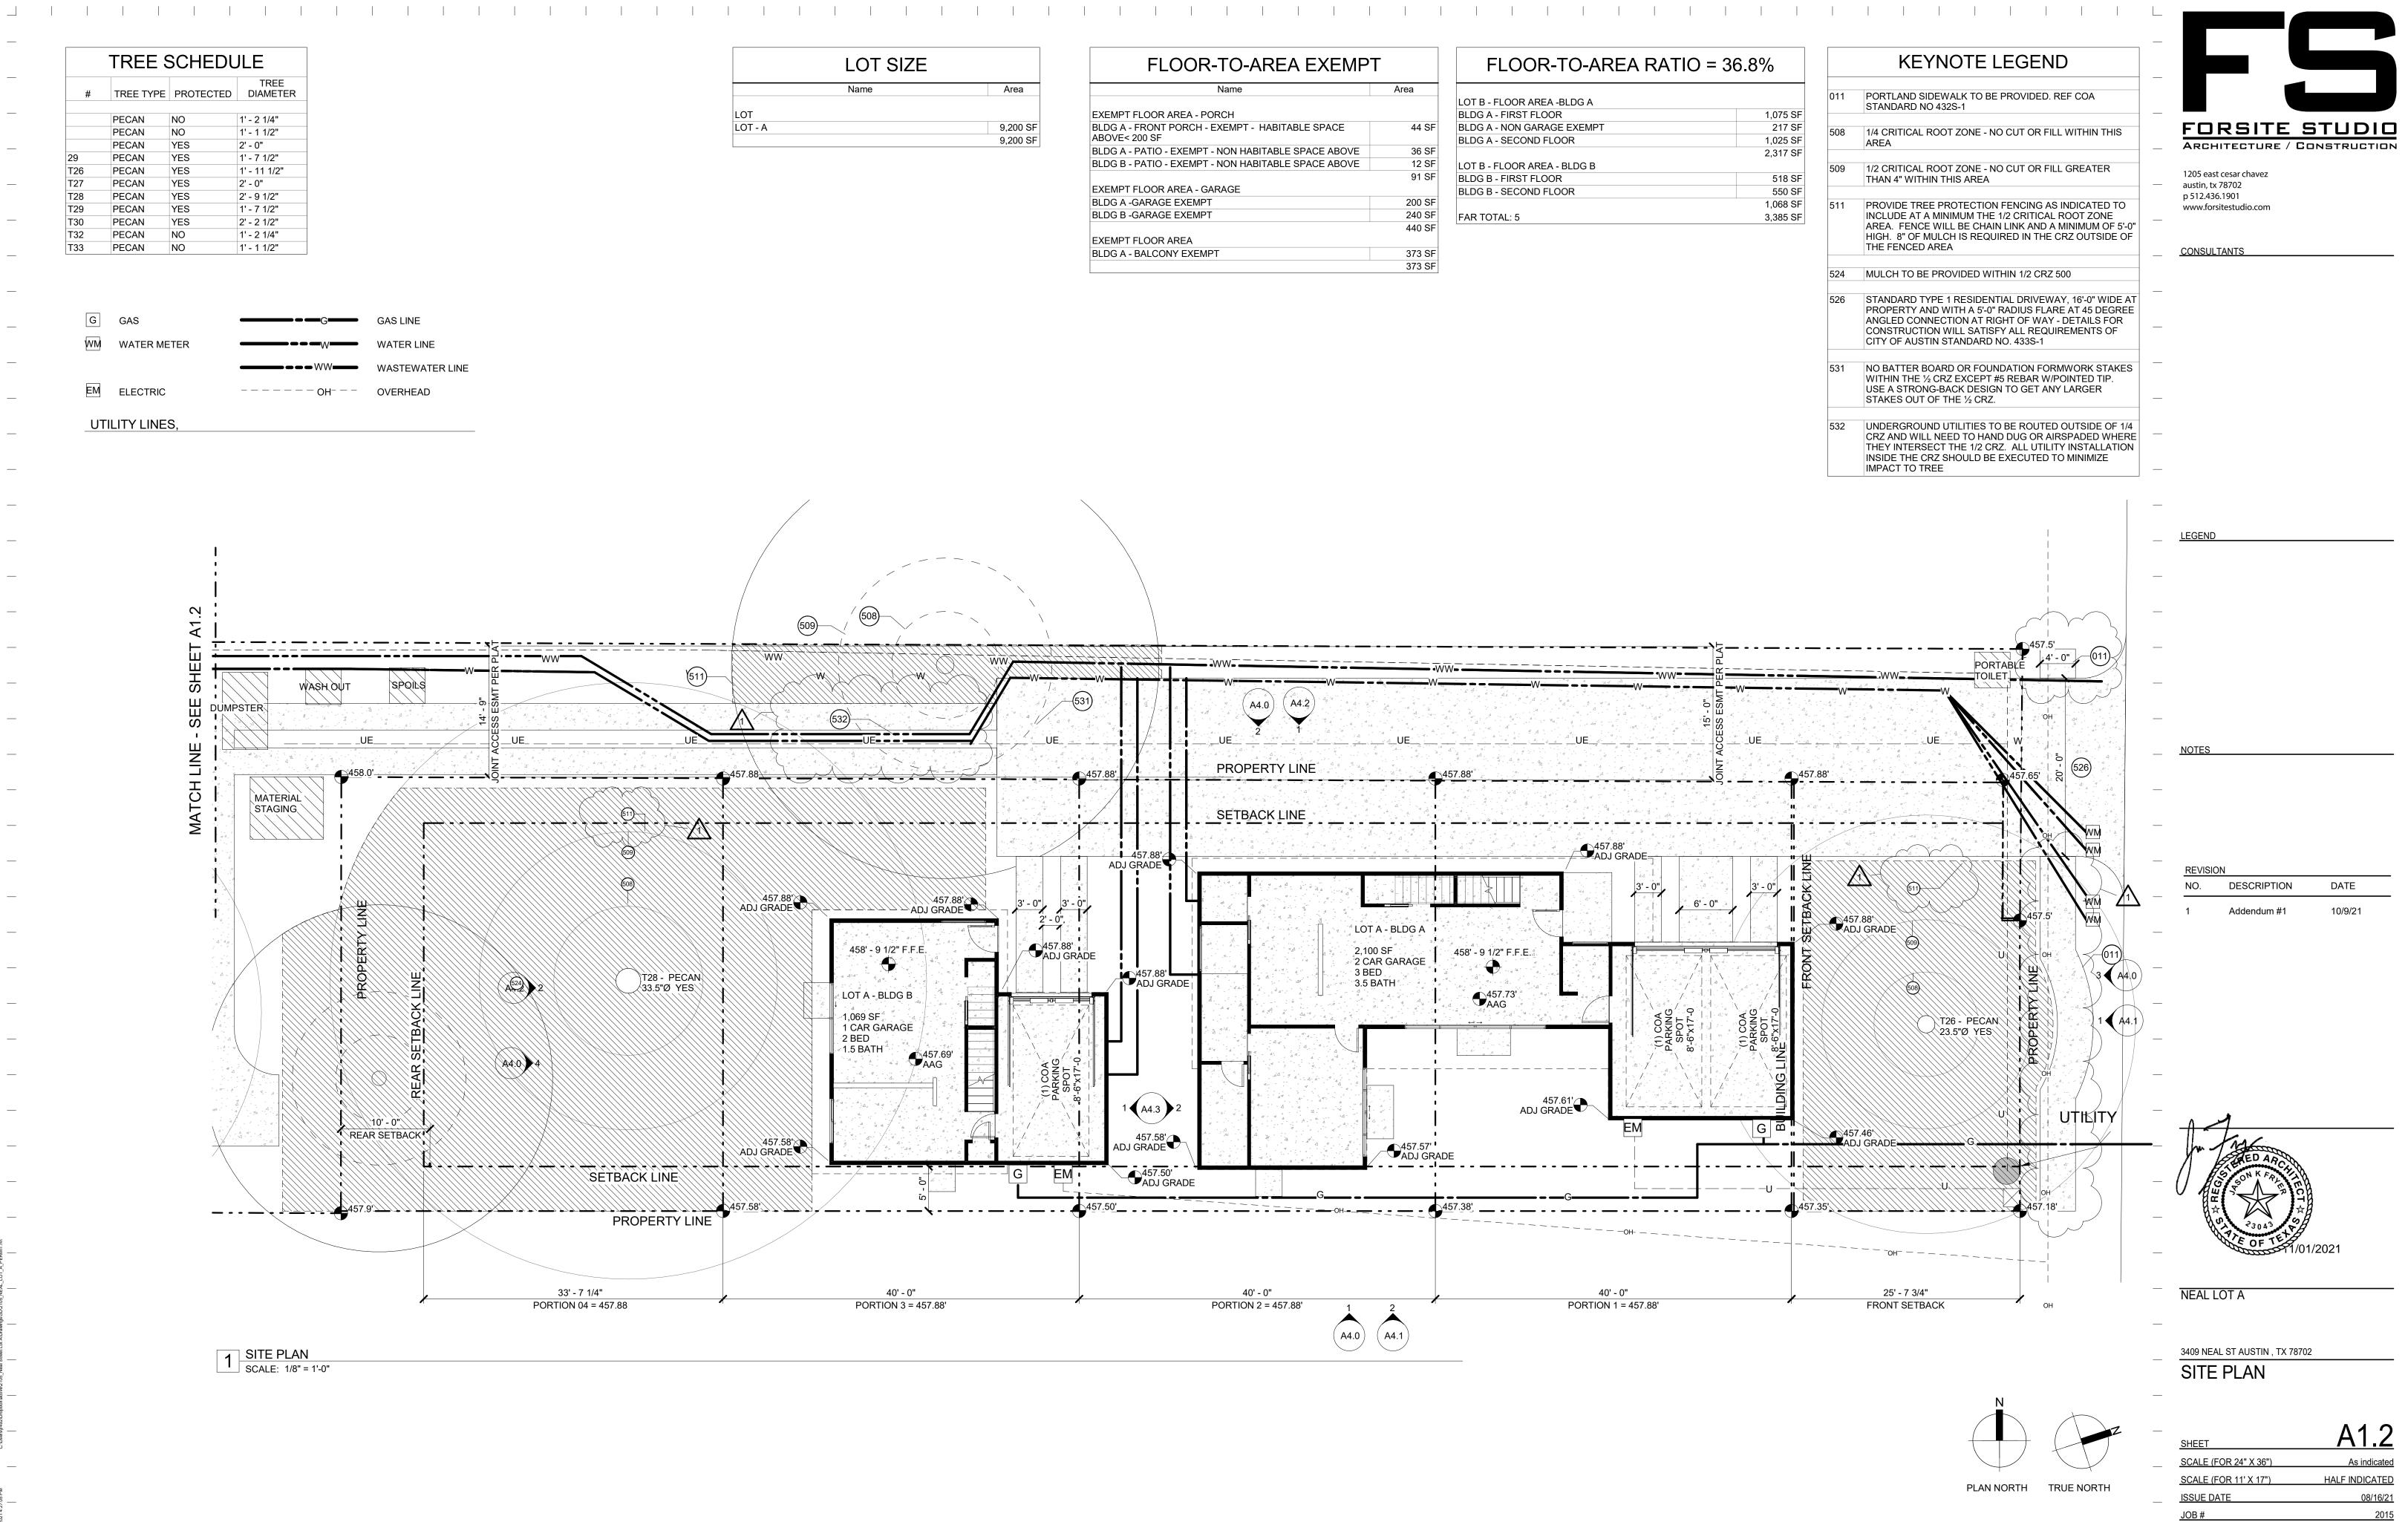

LOT SIZE	
Name	Area
	9,200 SF 9,200 SF
	9,200 SF

EXEMPT FLOOR AREA - PORCH	
BLDG A - FRONT PORCH - EXEMPT - HABITABLE SPACE ABOVE< 200 SF	44 SF
BLDG A - PATIO - EXEMPT - NON HABITABLE SPACE ABOVE	36 SF
BLDG B - PATIO - EXEMPT - NON HABITABLE SPACE ABOVE	12 SF
	91 SF
EXEMPT FLOOR AREA - GARAGE	
BLDG A -GARAGE EXEMPT	200 SF
BLDG B -GARAGE EXEMPT	240 SF
	440 SF
EXEMPT FLOOR AREA	
BLDG A - BALCONY EXEMPT	373 SF

DRAWN BY

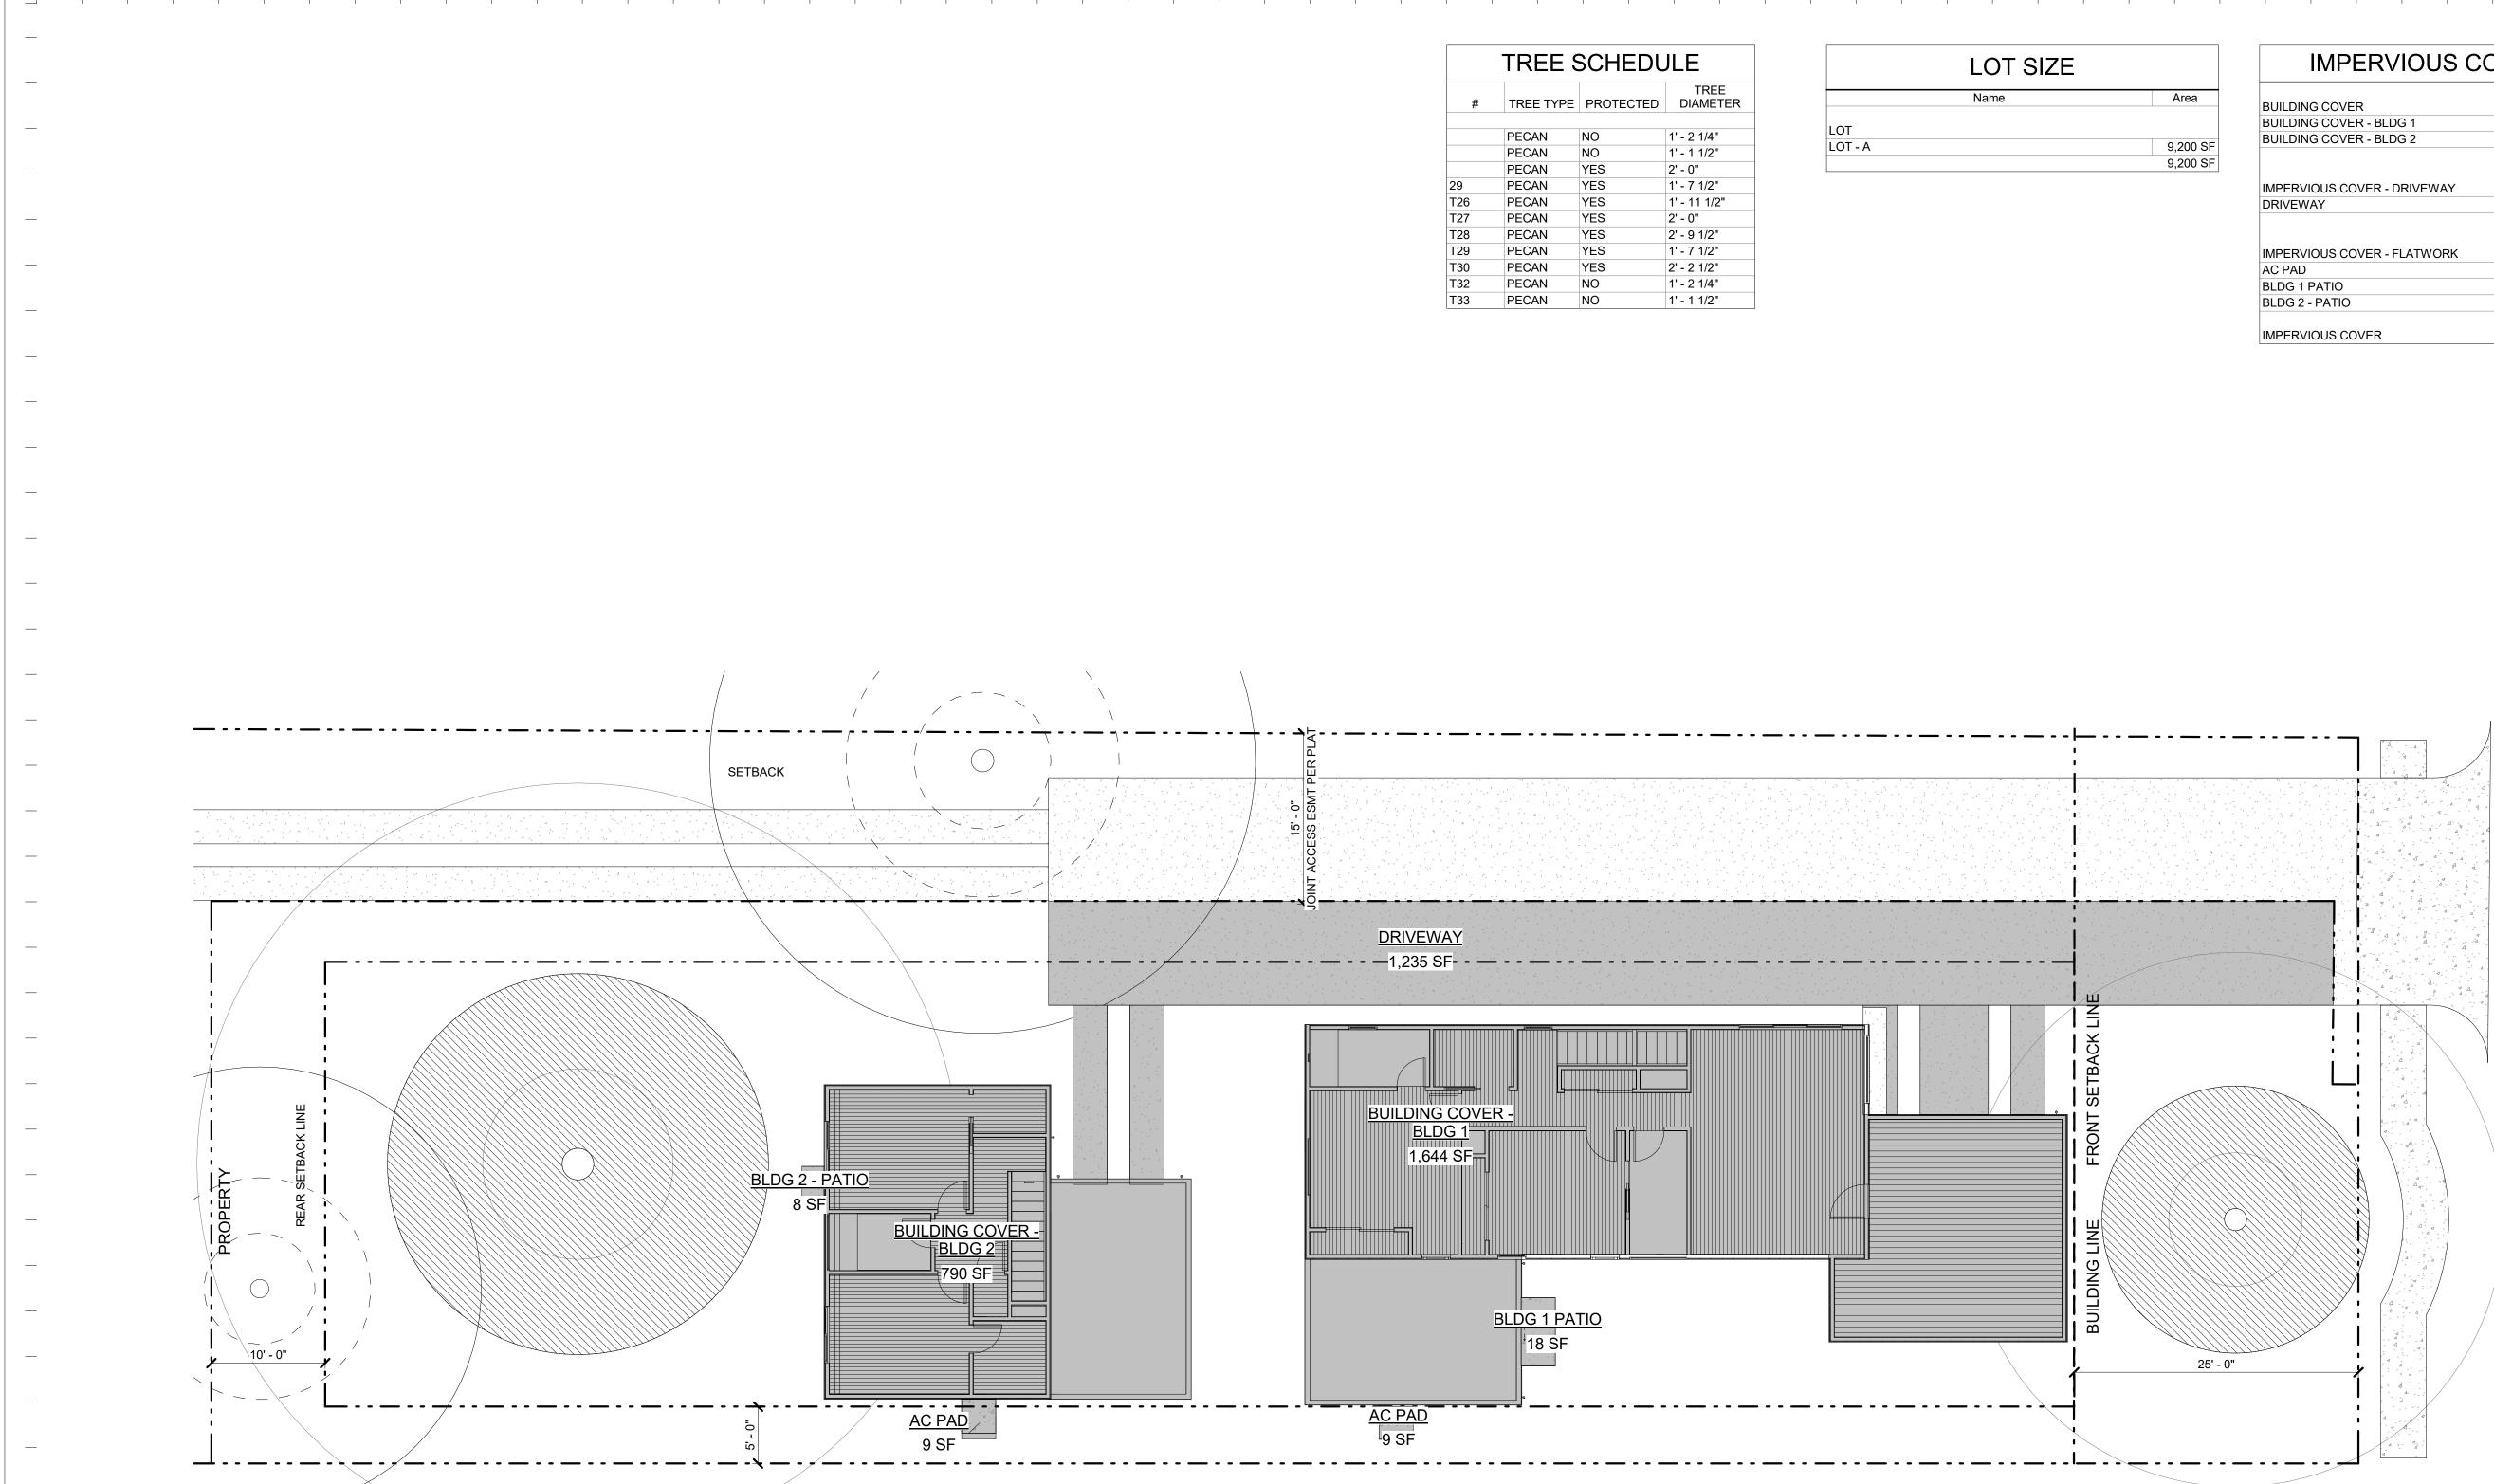



	TREE SCHEDULE						
#	# TREE TYPE PROTECTED DIAMETER						
	PECAN	NO	1' - 2 1/4"				
	PECAN	NO	1' - 1 1/2"				
	PECAN	YES	2' - 0"				
29	PECAN	YES	1' - 7 1/2"				
T26	PECAN	YES	1' - 11 1/2"				
T27	PECAN	YES	2' - 0"				
T28	PECAN	YES	2' - 9 1/2"				
T29	PECAN	YES	1' - 7 1/2"				
T30	PECAN	YES	2' - 2 1/2"				
T32	PECAN	NO	1' - 2 1/4"				
T33	PECAN	NO	1' - 1 1/2"				

LO	SIZE
Name	Area
LOT	
LOT LOT - A	9,200 SF
	9,200 SF

DRAWN BY

IMPERVIOUS COVER = 40.35%

BUILDING COVER	
BUILDING COVER - BLDG 1	1,644 S
BUILDING COVER - BLDG 2	790 S
	2,435 S
IMPERVIOUS COVER - DRIVEWAY	
DRIVEWAY	1,235 S
	1,235 S
IMPERVIOUS COVER - FLATWORK	
AC PAD	18 S
BLDG 1 PATIO	18 S
BLDG 2 - PATIO	8 S
	44 S
IMPERVIOUS COVER	3,713 S




CONSULTANTS


REVISION NO. DESCRIPTION DATE

NEAL LOT A

3409 NEAL ST AUSTIN , TX 78702 **IMPERVIOUS COVER**

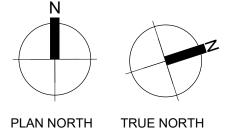



SHEET	A1.4
SCALE (FOR 24" X 36")	1/8" = 1'-0
SCALE (FOR 11' X 17")	HALF INDICATE
ISSUE DATE	08/16/2
JOB #	201
DRAWN BY	т

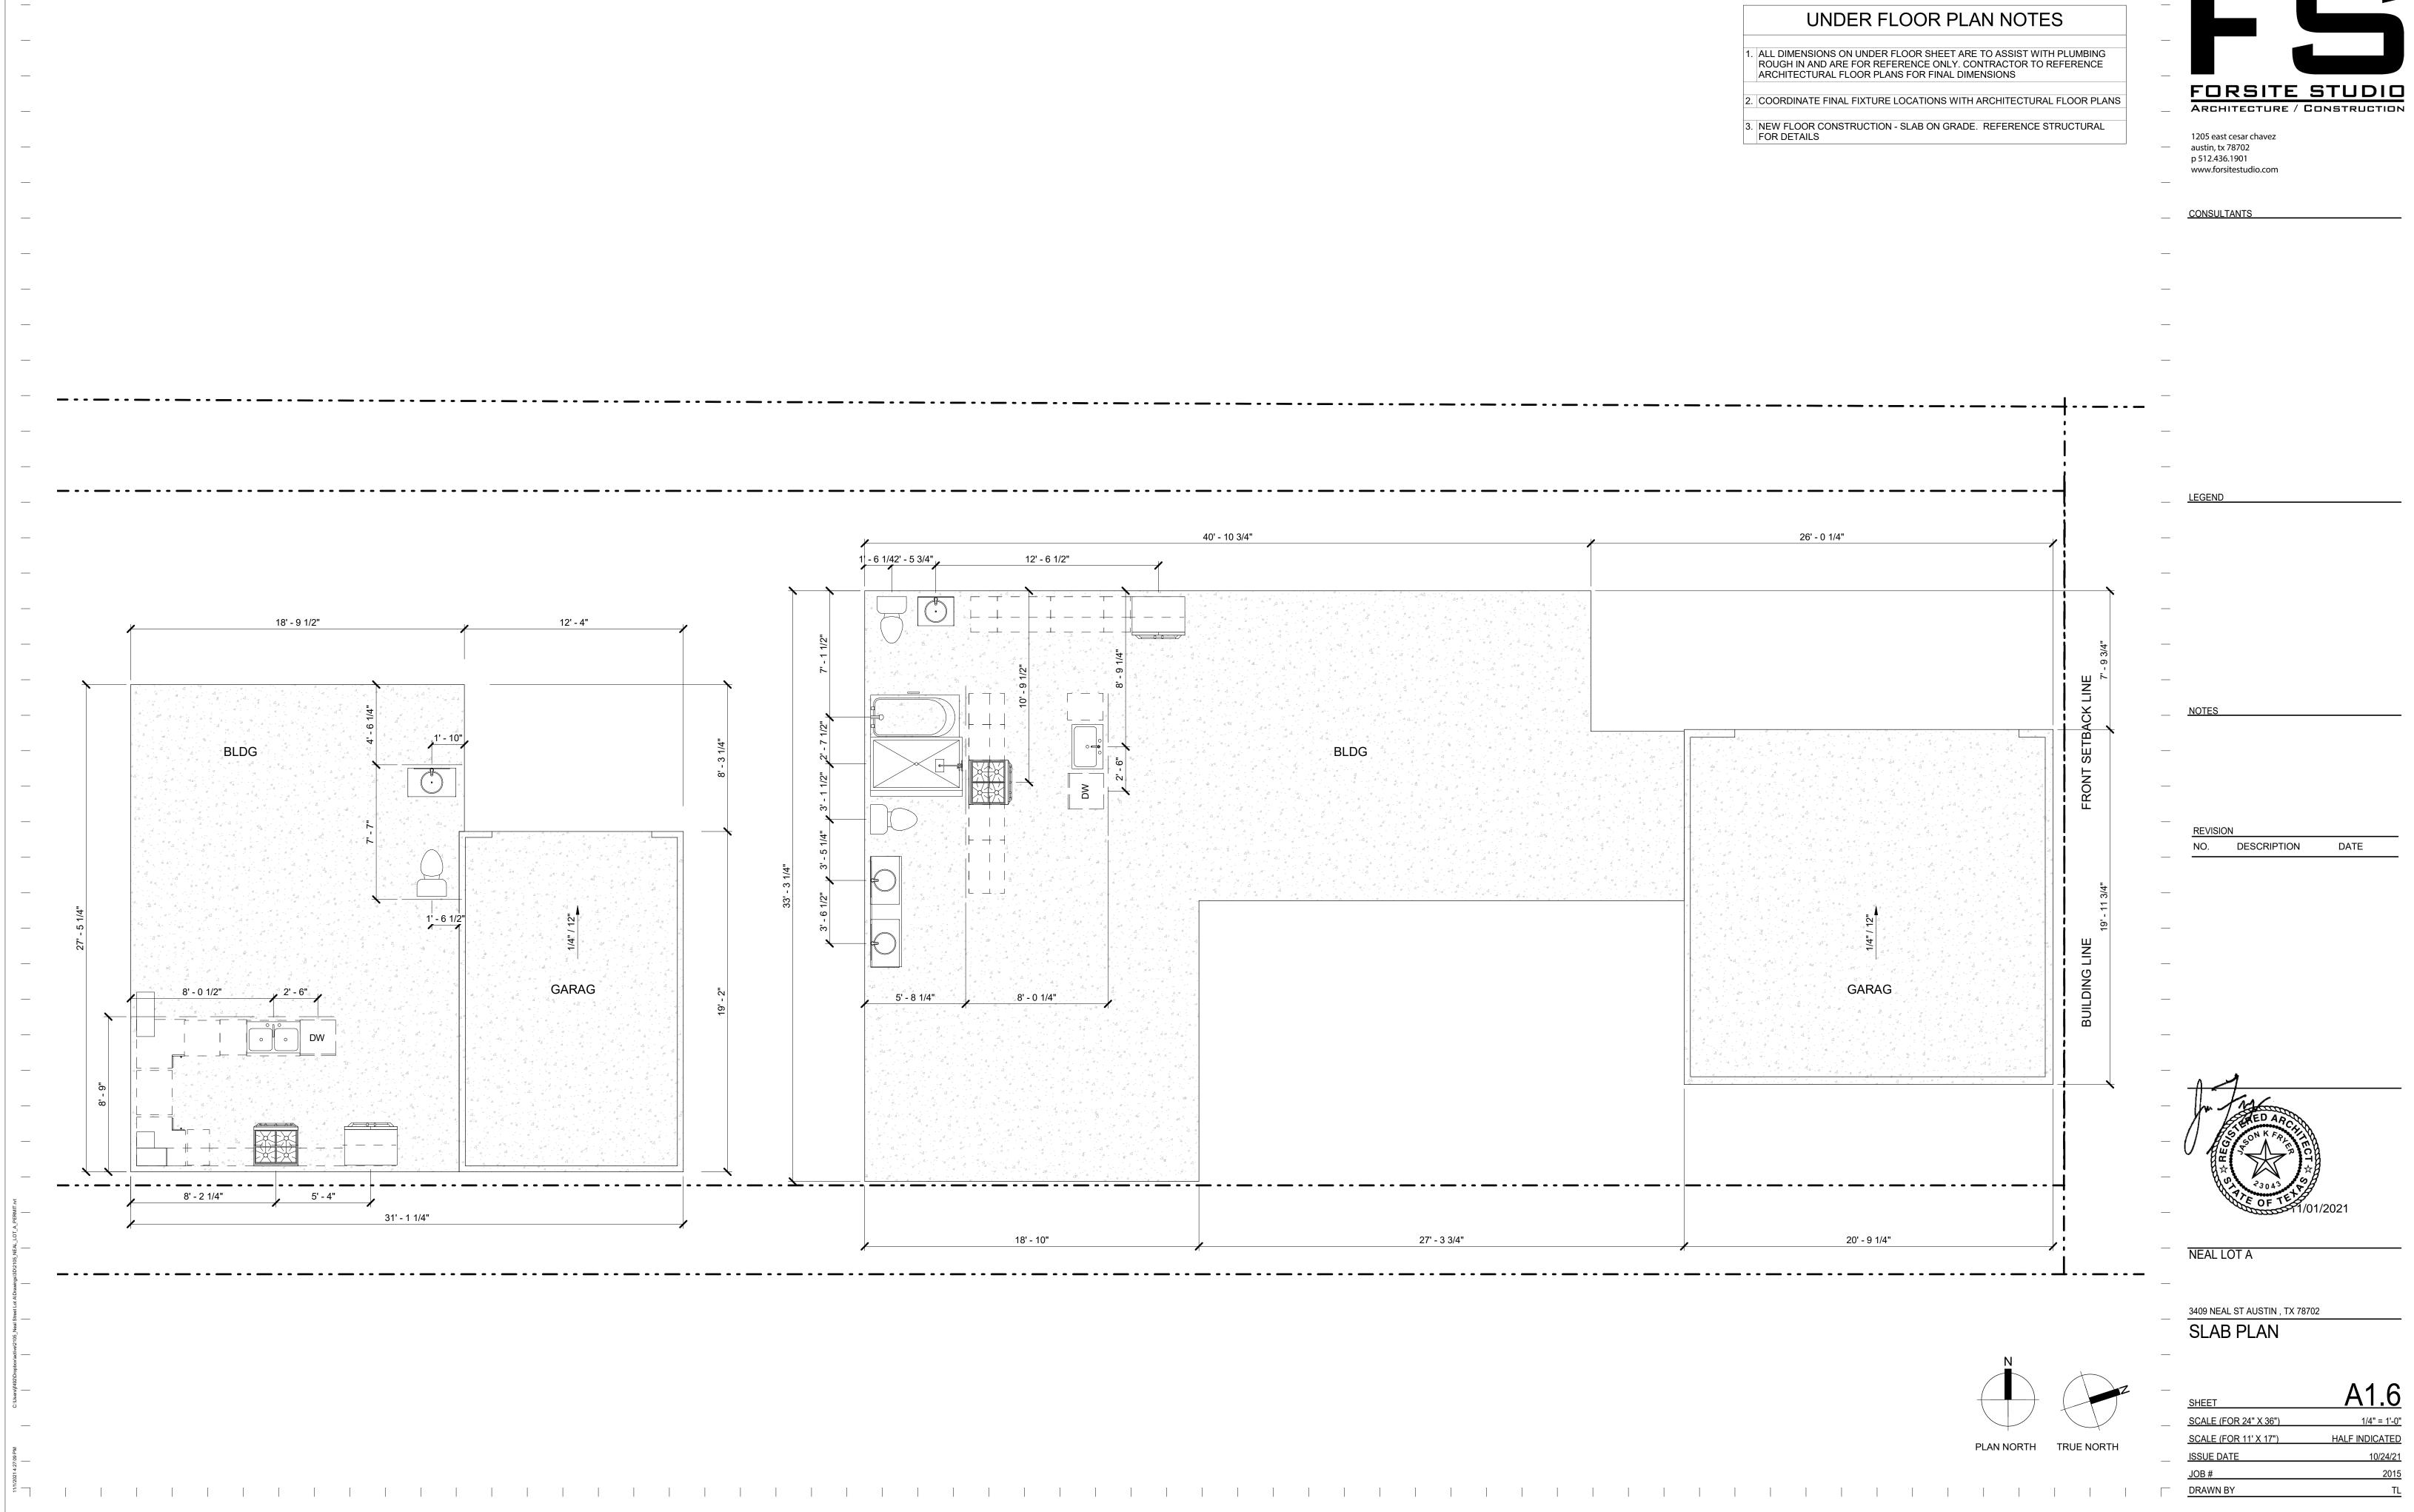





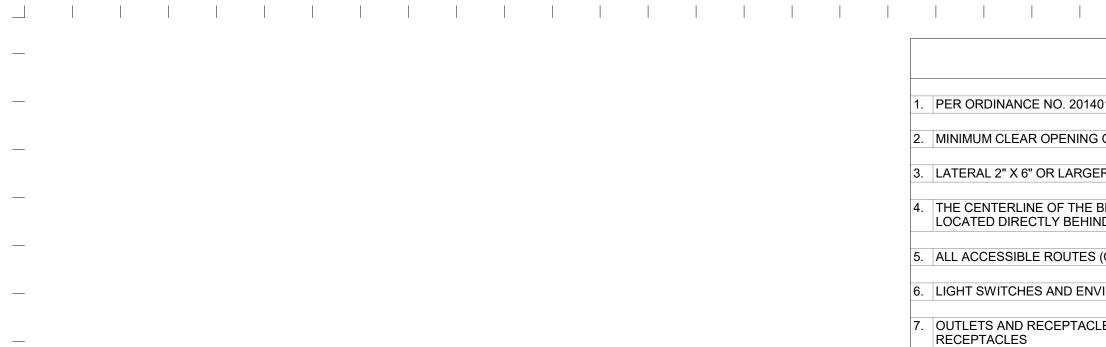

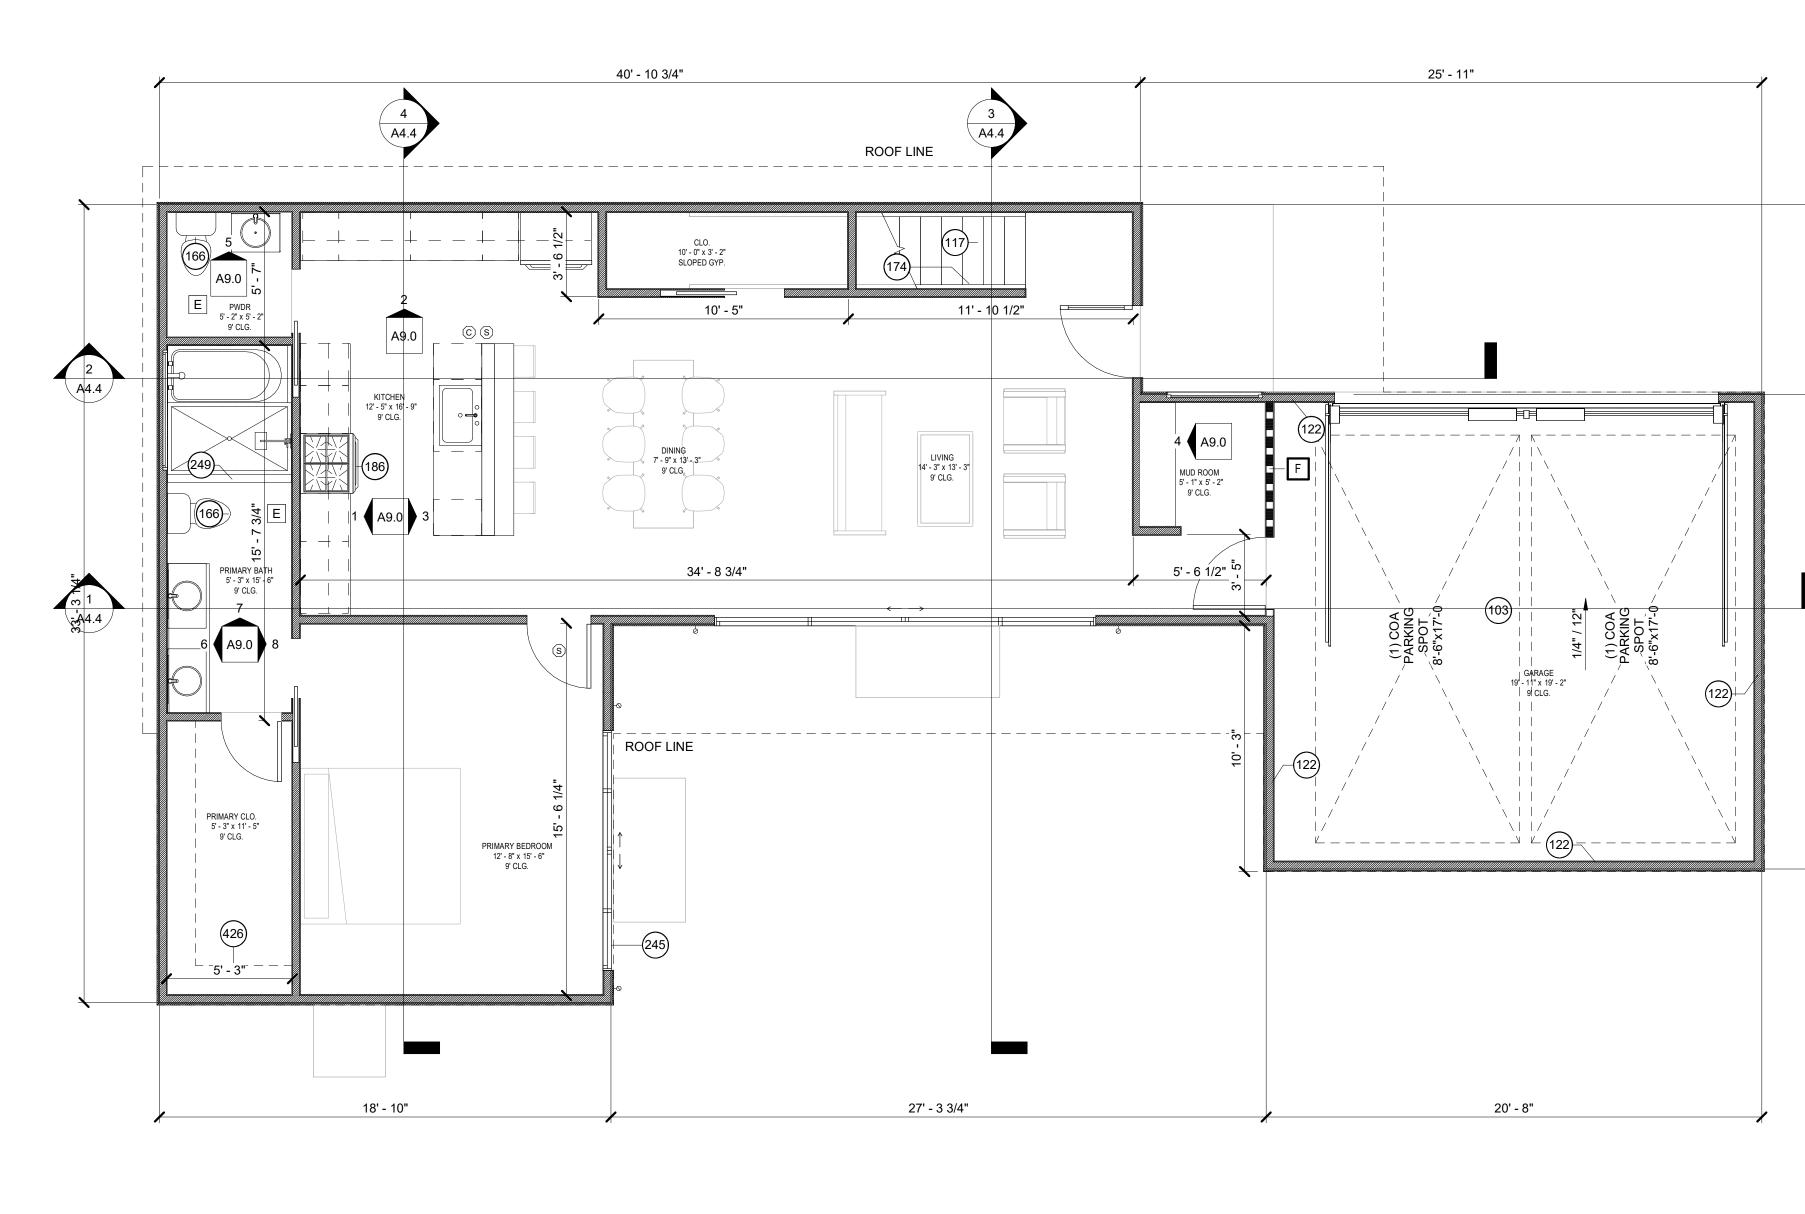



VISITABILI	TY NOTES.
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. PER ORDINANCE NO. 20140130-21, IN REFERENCE TO LEVEL 1 BATHROOM.

MINIMUM CLEAR OPENING OF 30" IS REQUIRED FOR BATHROOMS PER R320.4

3. LATERAL 2" X 6" OR LARGER NOMINAL WOOD BLOCKING MUST BE INSTALLED FLUSH WITH STUD EDGES OF BATHROOM WALLS

THE CENTERLINE OF THE BLOCKING MUST BE 34" FROM AND PARALLEL TO THE INTERIOR FLOOR LEVEL, EXCEPT FOR THE PORTION OF WALL LOCATED DIRECTLY BEHIND THE LAVATORY

- ALL ACCESSIBLE ROUTES (OTHER THAN RAMPS) SHALL NOT EXCEED A SLOPE OF 1:20, AND CROSS SLOPES SHALL NOT EXCEED A SLOPE OF 1:50.
- 6. LIGHT SWITCHES AND ENVIRONMENTAL CONTROLS MUST BE NO HIGHER THAN 48 INCHES ABOVE THE INTERIOR FLOOR LEVEL
- OUTLETS AND RECEPTACLES MUST BE A MINIMUM OF 15 INCHES ABOVE THE INTERIOR FLOOR LEVEL, EXCEPT FOR FLOOR OUTLETS AND

8. VISITABILITY ROUTES MUST BE ACCESSIBLE BY A ROUTE WITH A MINIMUM CLEAR OPENING OF 32 INCHES BEGINING AT THE VISITABLE ENTRANCE

1.	ALL INTERIOR WALLS TO BE TYPE "A". 4 1/2" ASSEMBLY WITH 1/2" GYP. BOARD, 3 1/2" WOOD STUD, 1/2" GYP. BOARD, UNO.
2.	ALL WALLS TAGGED "F" TO BE FIRE RATED TO 1 HOUR: 1/2" TYPE X GYP. 3 1/2" WOOD STUD AND 1/2" TYPE X GYP, UNO
3.	ALL EXTERIOR WALLS TO BE TYPE "B". 5" ASSEMBLY WITH 1, GYP. BOARD, 3 1/2" WOOD STUD, 1/2" SHEETHING, 1/2" HORIZONTAL HARDY BOARD, UNO.
4.	ALL SWING DOORS TO BE LOCATED 4" OFF OF ADJACENT WALL, UNO
5.	ALL POCKET DOORS TO BE LOCATED 1" FROM ADJACENT WALL, UNO

6. ALL CLOSET DOORS TO BE CENTERED ON CLOSET, UNO

	KEYNOTE LEGEND
103	CEILING TO HAVE 1-HOUR FIRE RATED CONSTRUCTION -
	5/8" TYPE X GYP BOARD ON GARAGE CEILING
117	STAIRS TO COMPLY WITH IRC 2021 - REFERENCE GENERA NOTES
122	INTERIOR OF WALL TO BE A MINIMUM OF 1/2' GYP ON GARAGE SIDE OF WALL WHERE IT SUPPORTS THE FLOOR ABOVE
166	MIN 15" CLEAR FROM CENTERLINE OF TOILET TO WALL
100	AND CABINET - IN COMPLIANCE WITH IRC R307.1 AND 202 UPC - BATHROOM TO EXHAUST TO EXTERIOR - 2X6 NOMINAL WOOD BLOCKING PROVIDED AT 34" CENTERLIN ABOVE FINISHED FLOOR ALONG BATHROOM WALLS, EXCEPT BEHIND TOILET
174	HANDRAILS TO COMPLY WITH IRC 2021 - REFERENCE
1/4	GENERAL STAIR NOTES
186	VENT HOOD ABOVE RANGE - EXHAUST TO EXTERIOR
245	EGRESS DOOR
249	SHOWER CURB - DOUBLE 2X4 TO BE INSTALLED AT FRAMING
426	CUSTOM BUILT-IN SHELVING



CONSULTANTS


REVISION

NO. DESCRIPTION DATE




NEAL LOT A

3409 NEAL ST AUSTIN , TX 78702 FIRST FLOOR- BLDG A

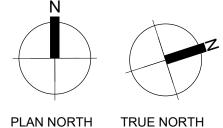




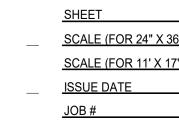


	A3.1
' X 36")	1/4" = 1'-0"
<u>X 17")</u>	HALF INDICATED
	08/16/21
	2015



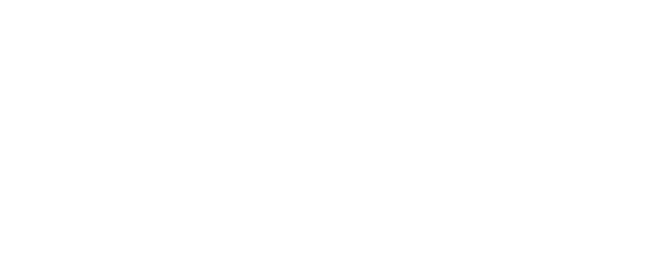



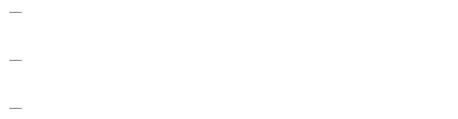

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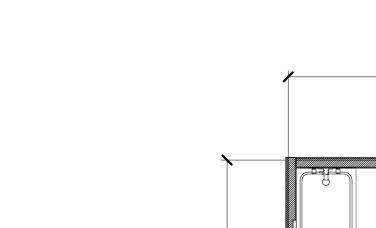
















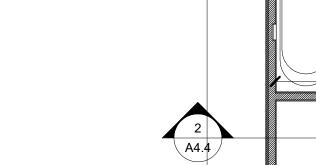

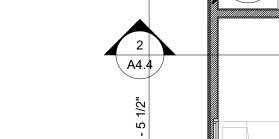

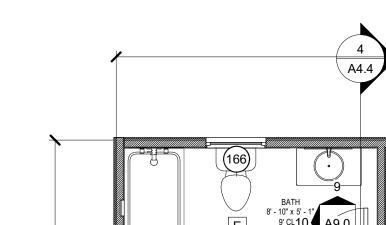

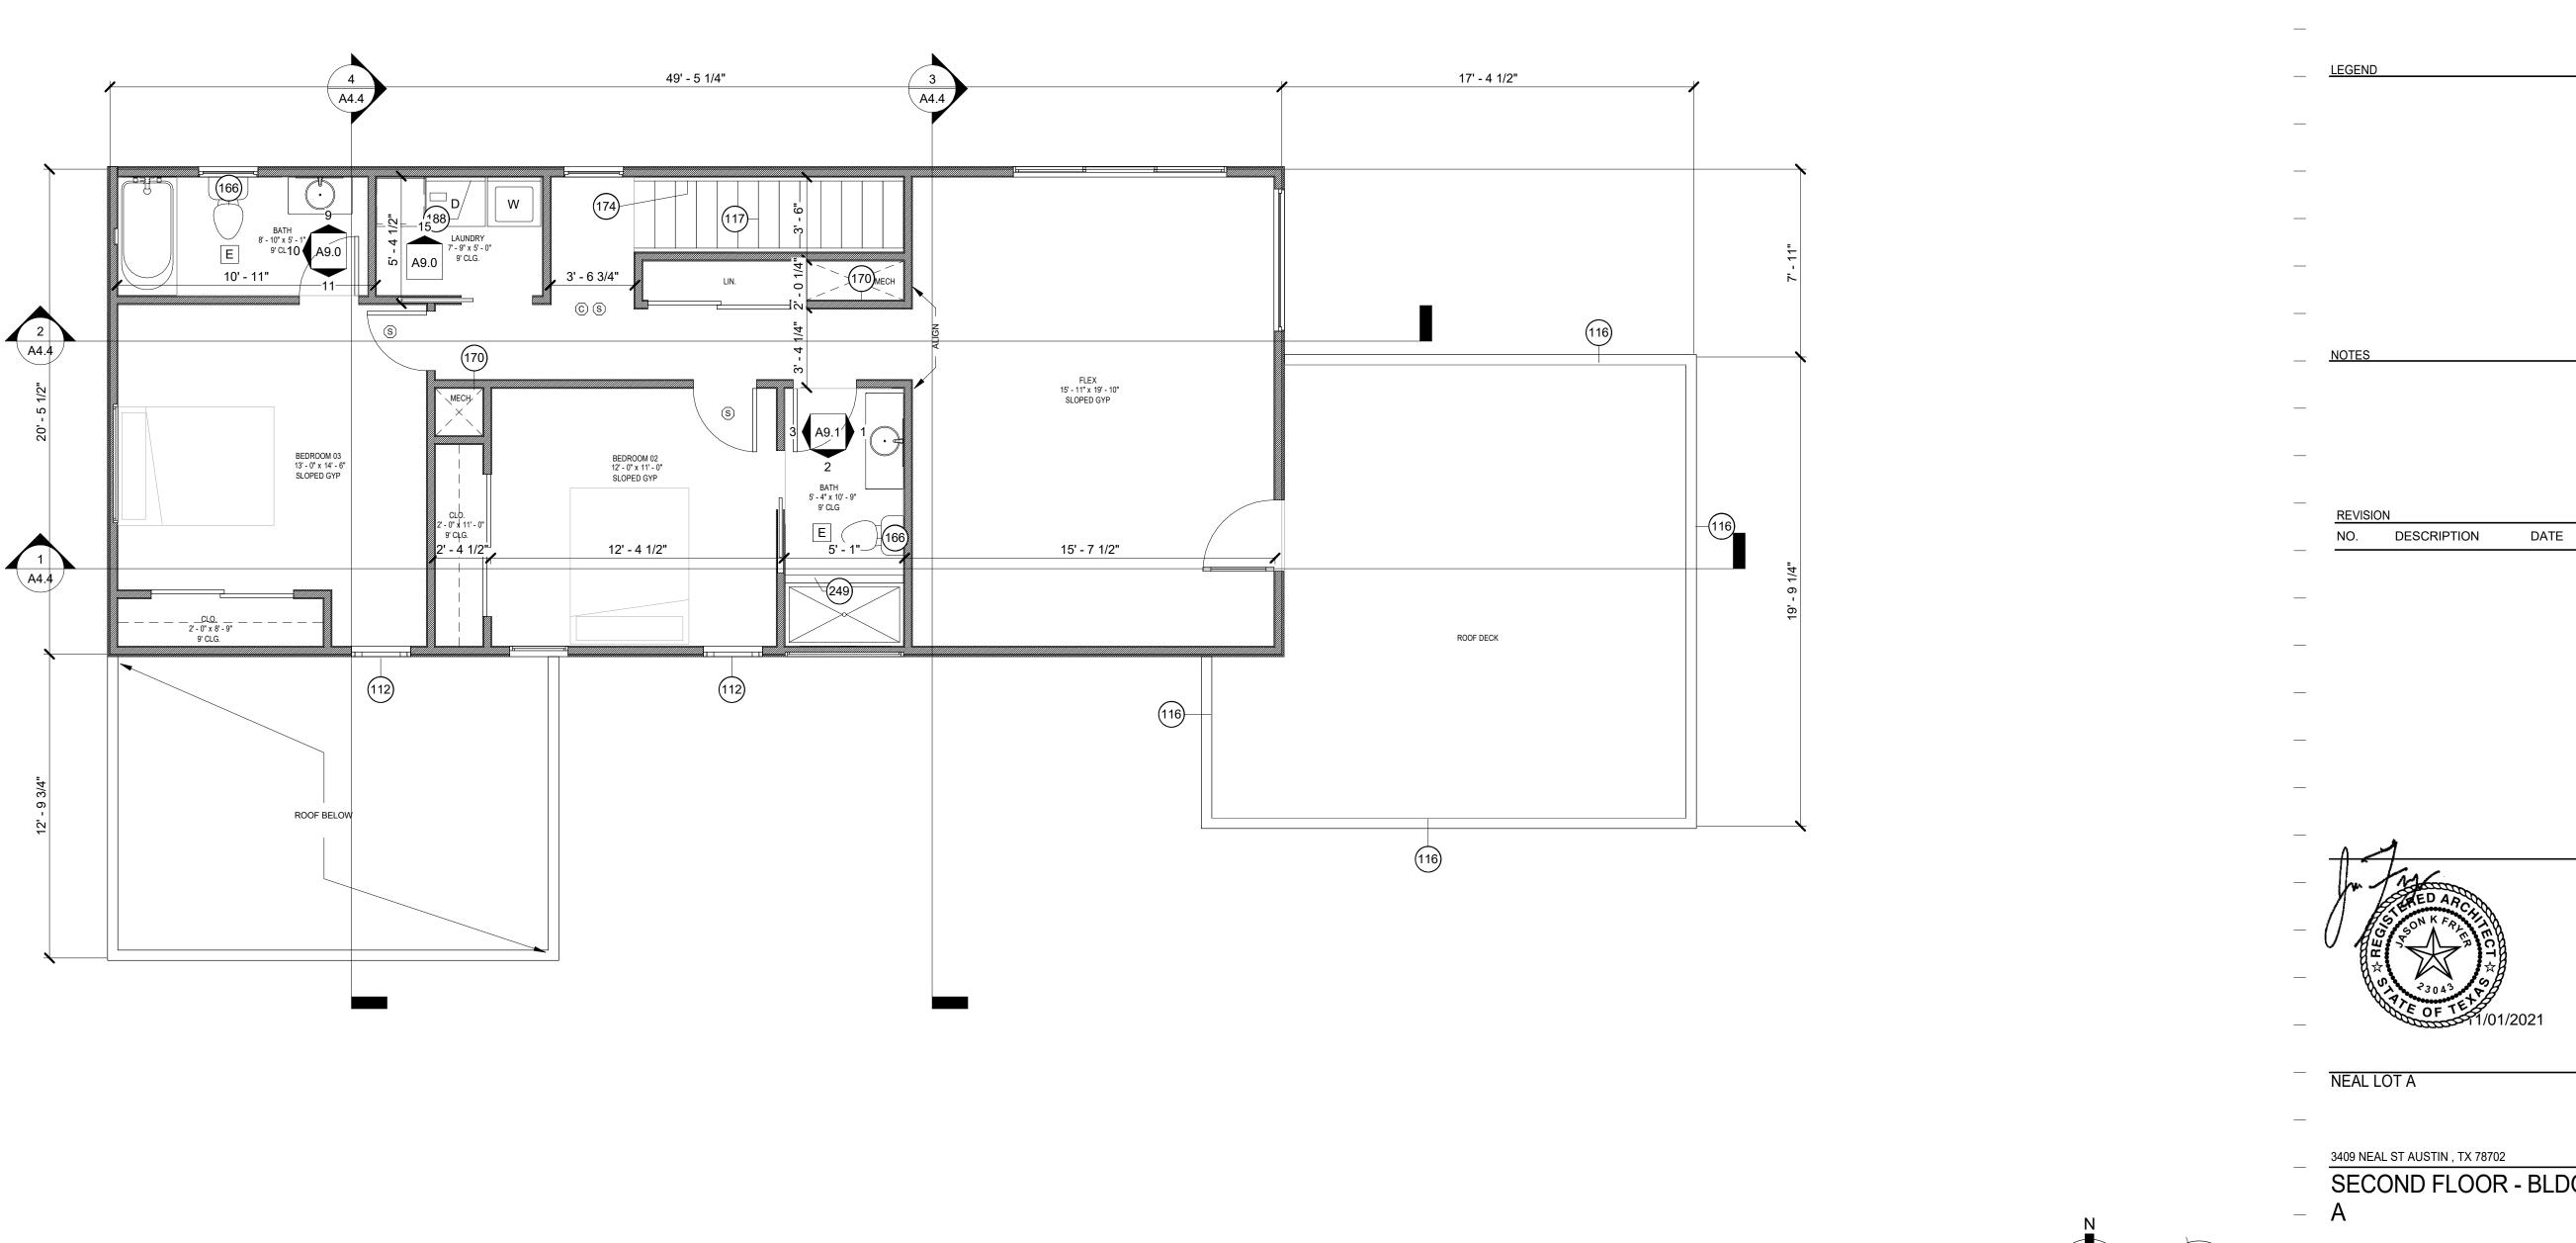

1 LOT A - BLDG A - SECOND FLOOR SCALE: 1/4" = 1'-0"

	GENERAL PLAN NOT
1.	ALL INTERIOR WALLS TO BE TYPE "A". 4 1/2" ASS 1/2" GYP. BOARD, 3 1/2" WOOD STUD, 1/2" GYP. E
2.	ALL WALLS TAGGED "F" TO BE FIRE RATED TO 1 TYPE X GYP. 3 1/2" WOOD STUD AND 1/2" TYPE 2
3.	ALL EXTERIOR WALLS TO BE TYPE "B". 5" ASSE GYP. BOARD, 3 1/2" WOOD STUD, 1/2" SHEETHIN HORIZONTAL HARDY BOARD, UNO.
4.	ALL SWING DOORS TO BE LOCATED 4" OFF OF A WALL, UNO
5.	ALL POCKET DOORS TO BE LOCATED 1" FROM A WALL, UNO

6. ALL CLOSET DOORS TO BE CENTERED ON CLOS

ΓES		KEYNOTE LEGEND
SEMBLY WITH BOARD, UNO.	112	EGRESS WINDOW - MINIMUM SIZE 5.7SF, 24"H X 20"W
1 HOUR: 1/2"	116	PER R312 - MINIMUM GUARDRAIL HEIGHT 36"
X GYP, UNO	117	STAIRS TO COMPLY WITH IRC 2021 - REFERENCE GENERAL NOTES
EMBLY WITH 1/2" NG, 1/2"	166	MIN 15" CLEAR FROM CENTERLINE OF TOILET TO WALL AND CABINET - IN COMPLIANCE WITH IRC R307.1 AND 2021
ADJACENT		UPC - BATHROOM TO EXHAUST TO EXTERIOR - 2X6 NOMINAL WOOD BLOCKING PROVIDED AT 34" CENTERLINE ABOVE FINISHED FLOOR ALONG BATHROOM WALLS, EXCEPT BEHIND TOILET
ADJACENT	170	MECHANICAL CHASE
	170	MECHANICAL CHASE
DSET, UNO	174	HANDRAILS TO COMPLY WITH IRC 2021 - REFERENCE GENERAL STAIR NOTES
	188	DRYER EXHAUSTED TO EXTERIOR
	249	SHOWER CURB - DOUBLE 2X4 TO BE INSTALLED AT FRAMING




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SECOND FLOOR - BLDG

SHEET	A3.2
SCALE (FOR 24" X 36")	1/4" = 1'-0"
SCALE (FOR 11' X 17")	HALF INDICATED
ISSUE DATE	08/16/21
JOB #	2015
DRAWN BY	TL





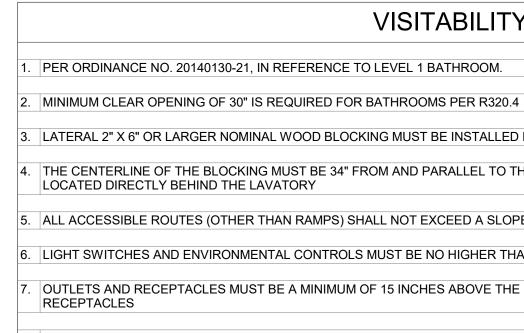

VISITABILITY NOTES.

3. LATERAL 2" X 6" OR LARGER NOMINAL WOOD BLOCKING MUST BE INSTALLED FLUSH WITH STUD EDGES OF BATHROOM WALLS

4. THE CENTERLINE OF THE BLOCKING MUST BE 34" FROM AND PARALLEL TO THE INTERIOR FLOOR LEVEL, EXCEPT FOR THE PORTION OF WALL


5. ALL ACCESSIBLE ROUTES (OTHER THAN RAMPS) SHALL NOT EXCEED A SLOPE OF 1:20, AND CROSS SLOPES SHALL NOT EXCEED A SLOPE OF 1:50.

6. LIGHT SWITCHES AND ENVIRONMENTAL CONTROLS MUST BE NO HIGHER THAN 48 INCHES ABOVE THE INTERIOR FLOOR LEVEL

7. OUTLETS AND RECEPTACLES MUST BE A MINIMUM OF 15 INCHES ABOVE THE INTERIOR FLOOR LEVEL, EXCEPT FOR FLOOR OUTLETS AND RECEPTACLES

8. VISITABILITY ROUTES MUST BE ACCESSIBLE BY A ROUTE WITH A MINIMUM CLEAR OPENING OF 32 INCHES BEGINING AT THE VISITABLE ENTRANCE

1 2. A	ALL INTERIOR WALLS TO BE TYPE "A". 4 1/2" ASSEMBLY WITH 1/2" GYP. BOARD, 3 1/2" WOOD STUD, 1/2" GYP. BOARD, UNO.
1 2. A	1/2" GYP. BOARD, 3 1/2" WOOD STUD, 1/2" GYP. BOARD, UNO. ALL WALLS TAGGED "F" TO BE FIRE RATED TO 1 HOUR: 1/2"
	TYPE X GYP. 3 1/2" WOOD STUD AND 1/2" TYPE X GYP, UNO
3. A	ALL EXTERIOR WALLS TO BE TYPE "B". 5" ASSEMBLY WITH 1/2"
C	GYP. BOARD, 3 1/2" WOOD STUD, 1/2" SHEETHING, 1/2" HORIZONTAL HARDY BOARD, UNO.
	ALL SWING DOORS TO BE LOCATED 4" OFF OF ADJACENT WALL, UNO
5. A	ALL POCKET DOORS TO BE LOCATED 1" FROM ADJACENT
V	WALL, UNO

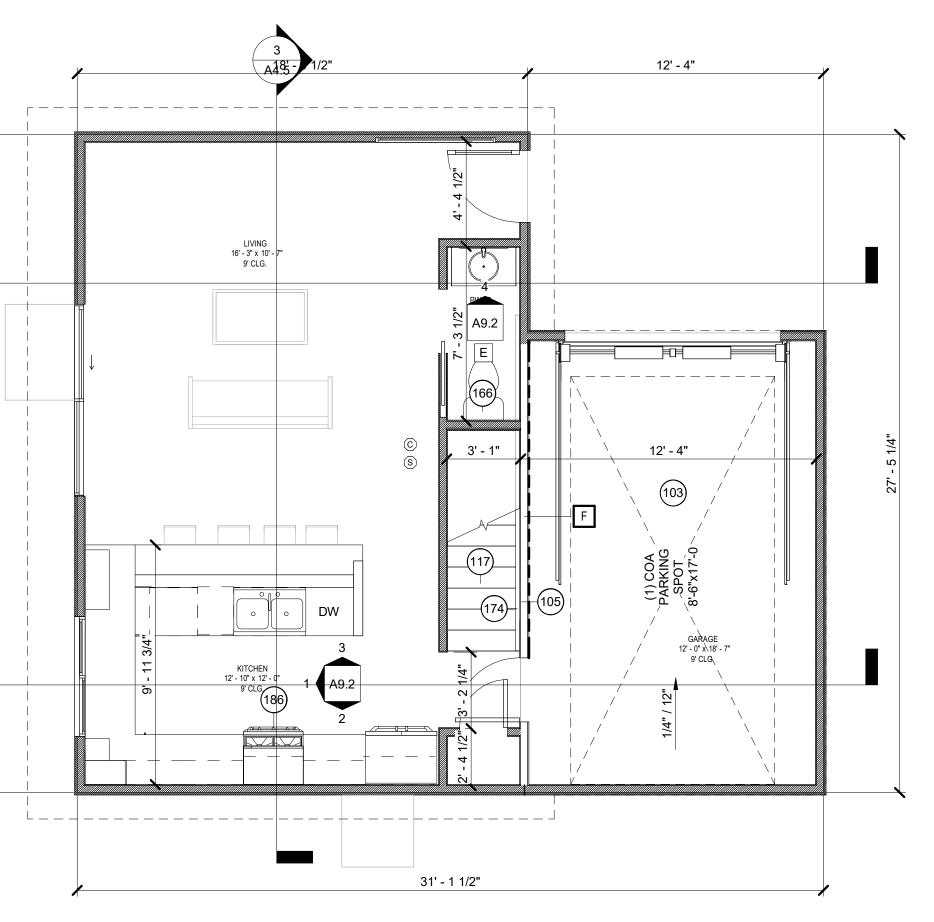


	KEYNOTE LEGEND
103	CEILING TO HAVE 1-HOUR FIRE RATED CONSTRUCTION - 5/8" TYPE X GYP BOARD ON GARAGE CEILING
105	WALL TO HAVE 1-HOUR FIRE RATED CONSTRUCTION - TO DECK
117	STAIRS TO COMPLY WITH IRC 2021 - REFERENCE GENERAL NOTES
166	MIN 15" CLEAR FROM CENTERLINE OF TOILET TO WALL AND CABINET - IN COMPLIANCE WITH IRC R307.1 AND 2021 UPC - BATHROOM TO EXHAUST TO EXTERIOR - 2X6 NOMINAL WOOD BLOCKING PROVIDED AT 34" CENTERLINE ABOVE FINISHED FLOOR ALONG BATHROOM WALLS, EXCEPT BEHIND TOILET
174	HANDRAILS TO COMPLY WITH IRC 2021 - REFERENCE GENERAL STAIR NOTES
186	VENT HOOD ABOVE RANGE - EXHAUST TO EXTERIOR



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REVISION NO. DESCRIPTION DATE NEAL LOT A 3409 NEAL ST AUSTIN , TX 78702 FIRST FLOOR - BLDG B



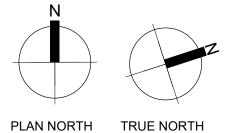

SCALE (FOR 24" X 36") SCALE (FOR 11' X 17") ISSUE DATE JOB # DRAWN BY


A3.4 1/4" = 1'-0" HALF INDICATED 08/16/21 2015


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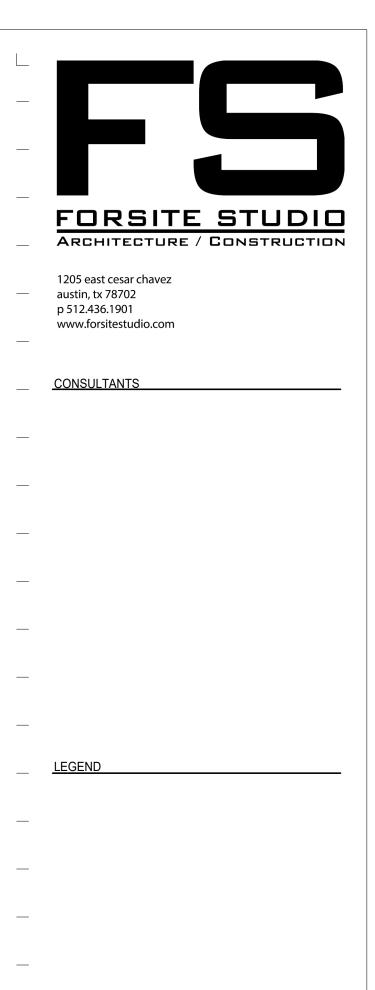
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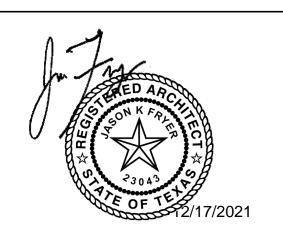


1 LOT A - BLDG B - SECOND FLOOR SCALE: 1/4" = 1'-0"

	KEYNOTE LEGEND
112	EGRESS WINDOW - MINIMUM SIZE 5.7SF, 24"H X 20"W
117	STAIRS TO COMPLY WITH IRC 2021 - REFERENCE GENERAL NOTES
166	MIN 15" CLEAR FROM CENTERLINE OF TOILET TO WALL AND CABINET - IN COMPLIANCE WITH IRC R307.1 AND 2021 UPC - BATHROOM TO EXHAUST TO EXTERIOR - 2X6 NOMINAL WOOD BLOCKING PROVIDED AT 34" CENTERLINE ABOVE FINISHED FLOOR ALONG BATHROOM WALLS, EXCEPT BEHIND TOILET
170	MECHANICAL CHASE
174	HANDRAILS TO COMPLY WITH IRC 2021 - REFERENCE GENERAL STAIR NOTES
188	DRYER EXHAUSTED TO EXTERIOR
249	SHOWER CURB - DOUBLE 2X4 TO BE INSTALLED AT FRAMING
	GENERAL PLAN NOTES
	L INTERIOR WALLS TO BE TYPE "A". 4 1/2" ASSEMBLY WITH 2" GYP. BOARD, 3 1/2" WOOD STUD, 1/2" GYP. BOARD, UNO.
1/2 2. Al	L INTERIOR WALLS TO BE TYPE "A". 4 1/2" ASSEMBLY WITH
 1/2 2. AL TN 3. AL G¹ 	L INTERIOR WALLS TO BE TYPE "A". 4 1/2" ASSEMBLY WITH 2" GYP. BOARD, 3 1/2" WOOD STUD, 1/2" GYP. BOARD, UNO. L WALLS TAGGED "F" TO BE FIRE RATED TO 1 HOUR: 1/2" (PE X GYP. 3 1/2" WOOD STUD AND 1/2" TYPE X GYP, UNO
1/2 2. AL TY 3. AL G' HO 4. AL	L INTERIOR WALLS TO BE TYPE "A". 4 1/2" ASSEMBLY WITH 2" GYP. BOARD, 3 1/2" WOOD STUD, 1/2" GYP. BOARD, UNO. L WALLS TAGGED "F" TO BE FIRE RATED TO 1 HOUR: 1/2" (PE X GYP. 3 1/2" WOOD STUD AND 1/2" TYPE X GYP, UNO L EXTERIOR WALLS TO BE TYPE "B". 5" ASSEMBLY WITH 1/2" (P. BOARD, 3 1/2" WOOD STUD, 1/2" SHEETHING, 1/2"
1/2 2. AL TN 3. AL G` H(4. AL W 5. AL	L INTERIOR WALLS TO BE TYPE "A". 4 1/2" ASSEMBLY WITH 2" GYP. BOARD, 3 1/2" WOOD STUD, 1/2" GYP. BOARD, UNO. L WALLS TAGGED "F" TO BE FIRE RATED TO 1 HOUR: 1/2" (PE X GYP. 3 1/2" WOOD STUD AND 1/2" TYPE X GYP, UNO L EXTERIOR WALLS TO BE TYPE "B". 5" ASSEMBLY WITH 1/2" (P. BOARD, 3 1/2" WOOD STUD, 1/2" SHEETHING, 1/2" DRIZONTAL HARDY BOARD, UNO.

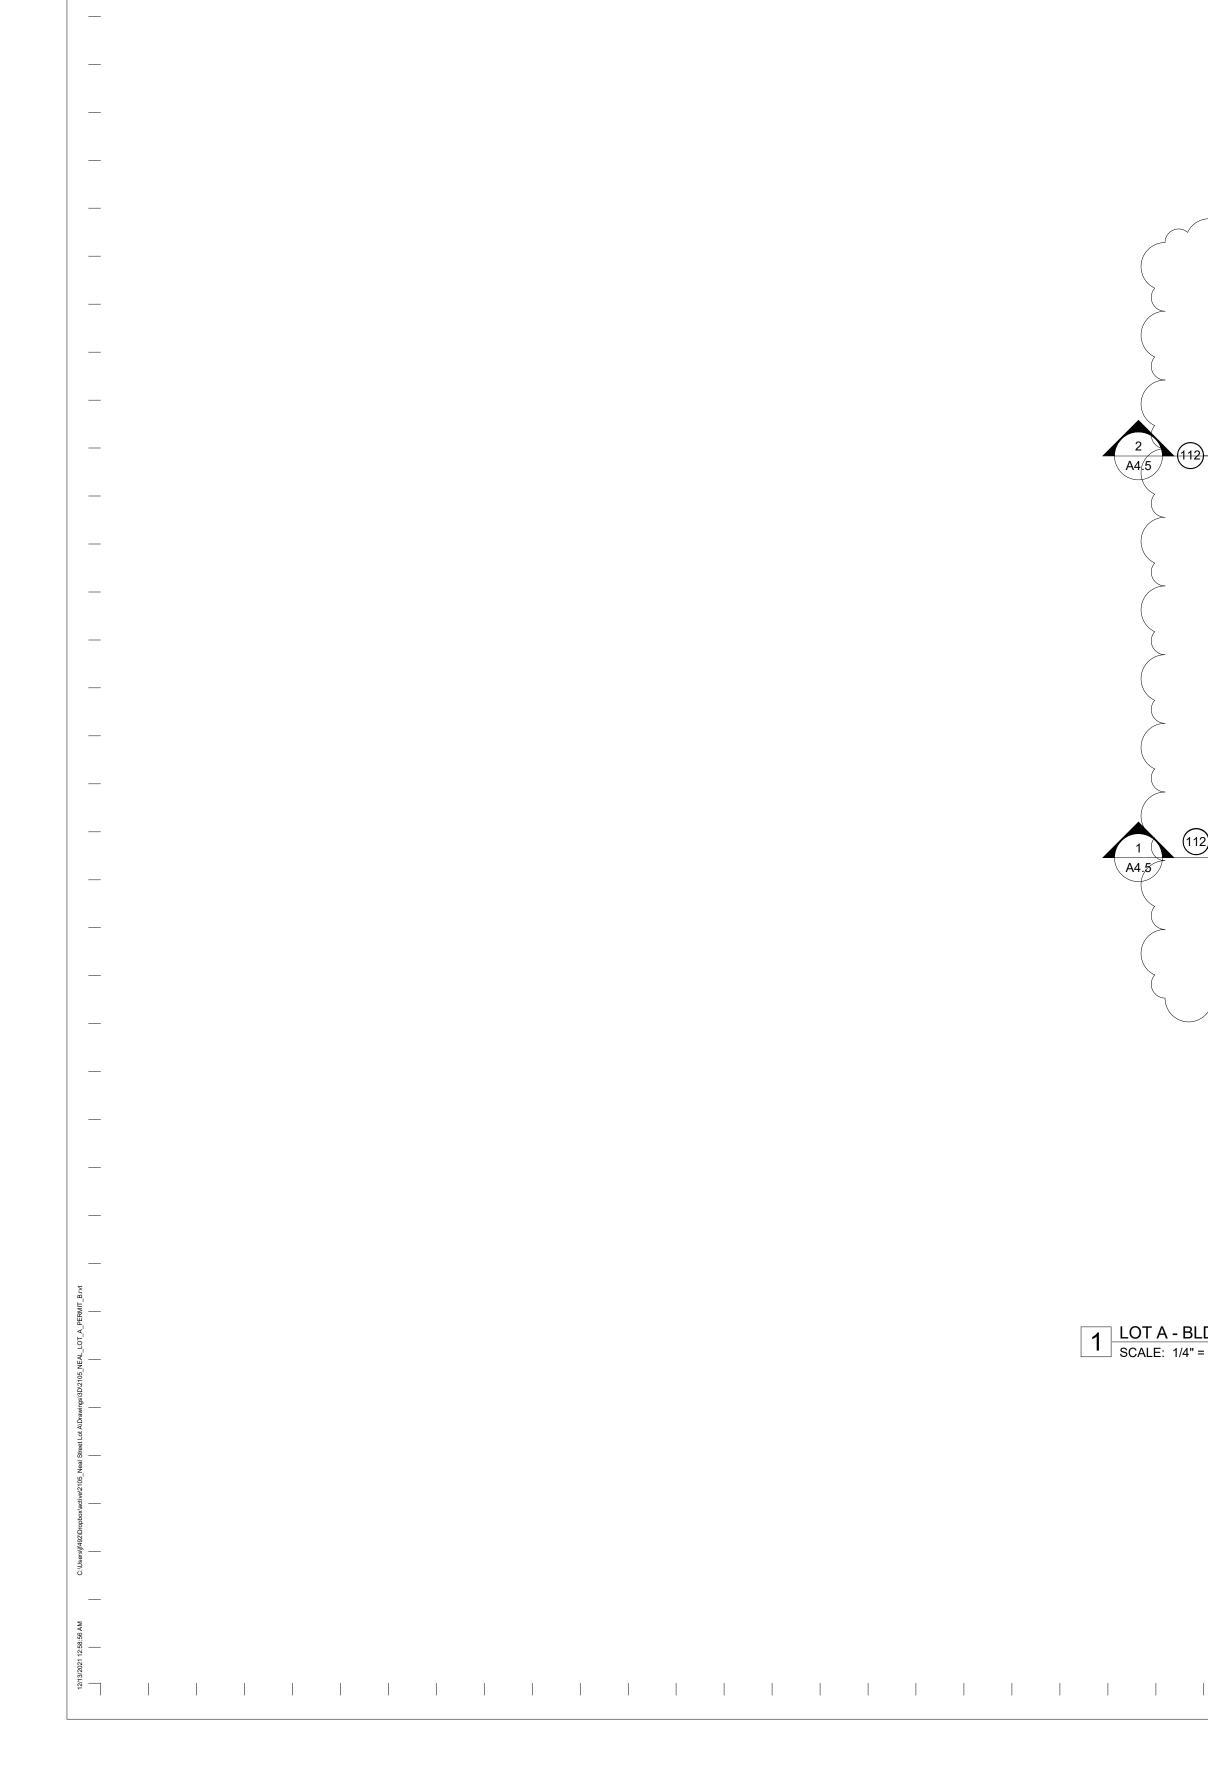


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NO.	DESCRIPTION	DATE
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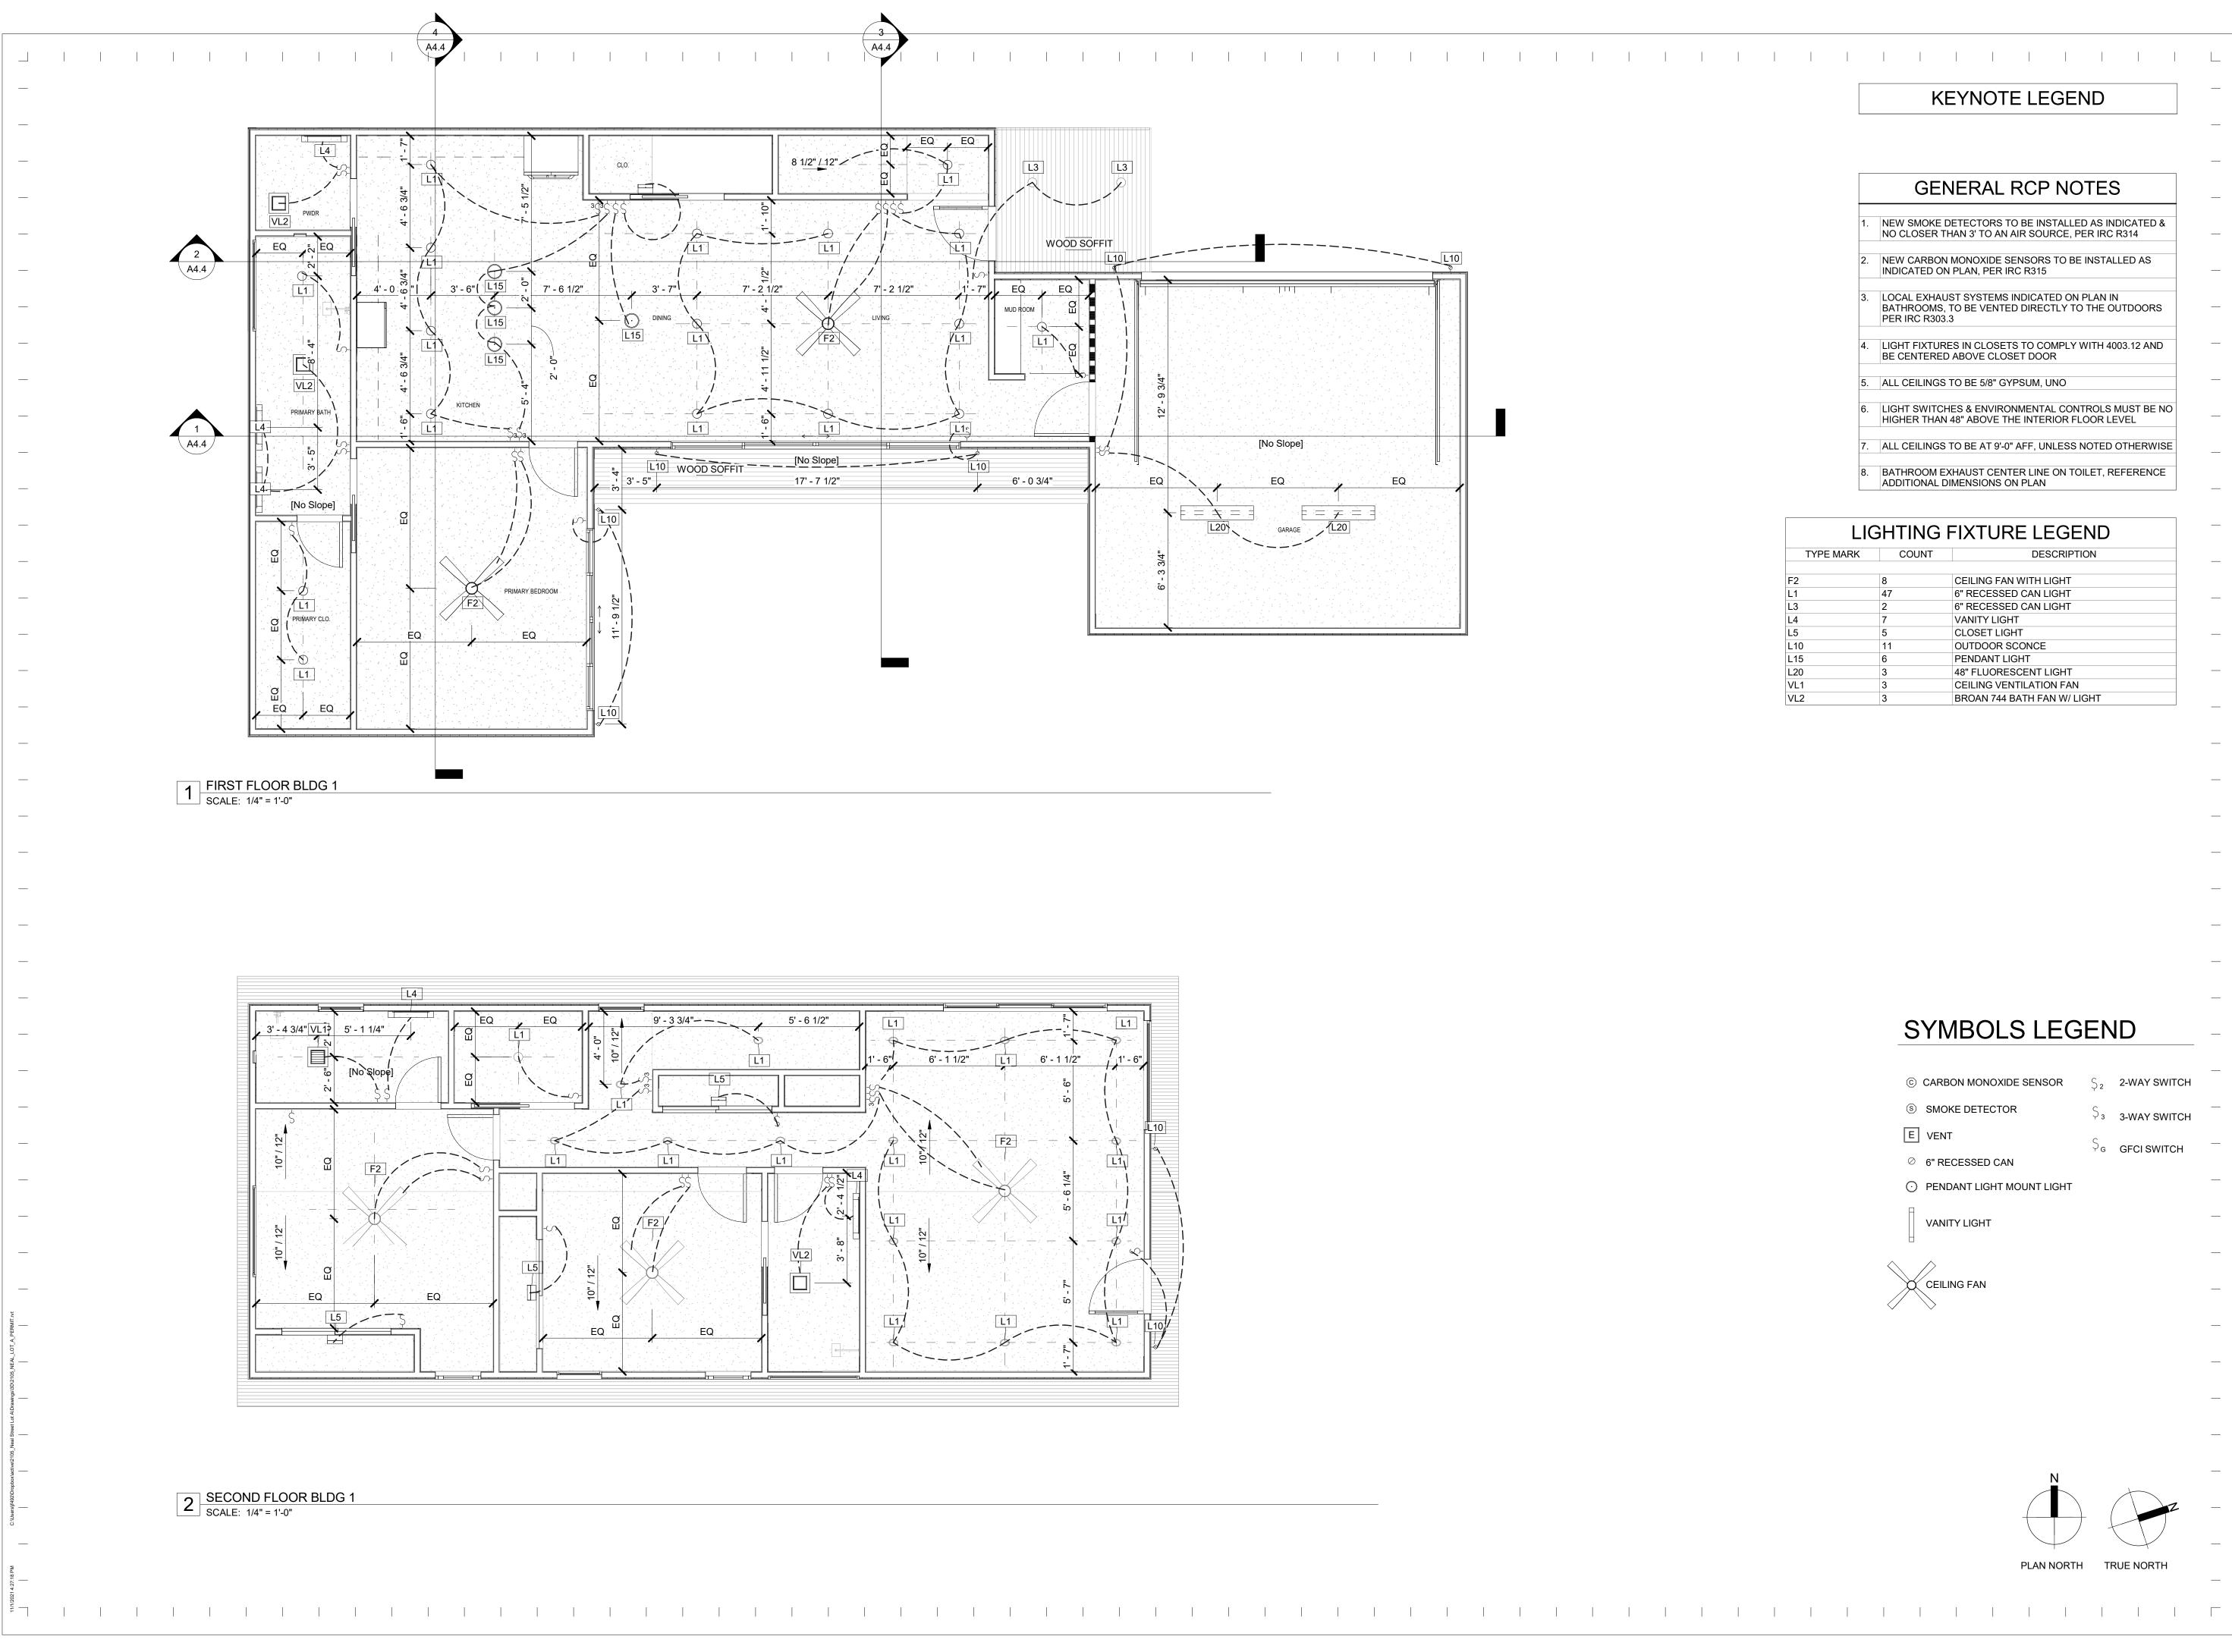


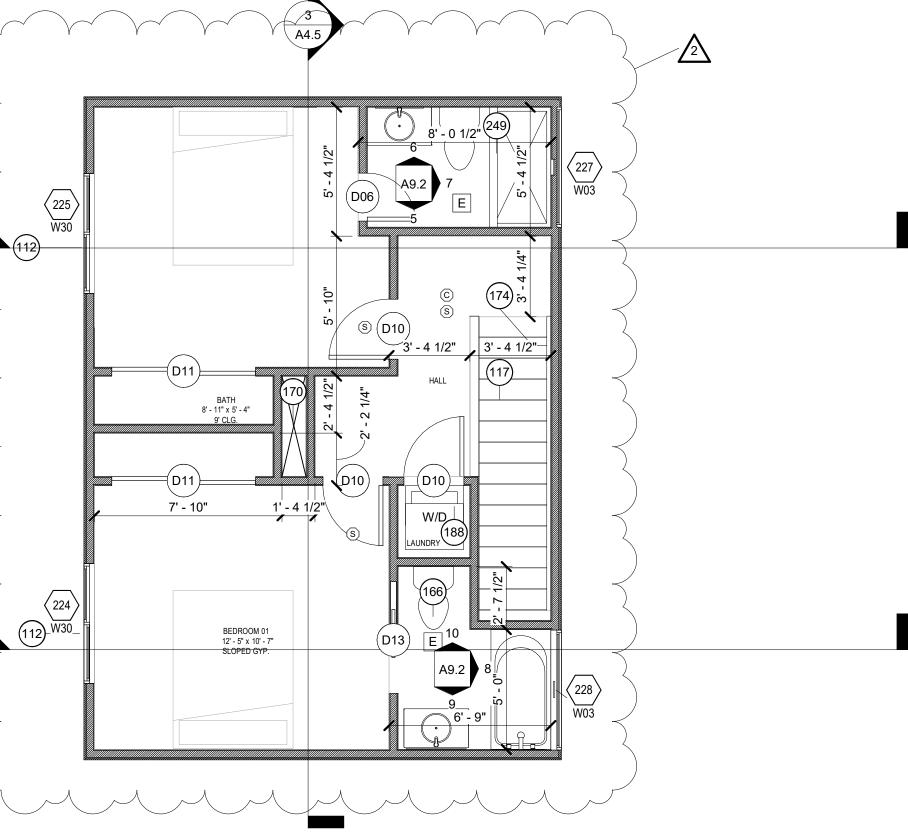NEAL LOT A

3409 NEAL ST AUSTIN , TX 78702 SECOND FLOOR - BLDG

	V3 E
SHEET	<u> </u>
SCALE (FOR 24" X 36")	1/4" = 1'-0"
SCALE (FOR 11' X 17")	HALF INDICATED
ISSUE DATE	08/16/21
JOB #	2015
DRAWN BY	TL



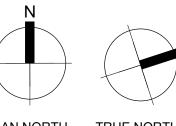



KEYNOTE LEGEND

	GENERAL RCP NOTES
1.	NEW SMOKE DETECTORS TO BE INSTALLED AS INDICATED & NO CLOSER THAN 3' TO AN AIR SOURCE, PER IRC R314
2.	NEW CARBON MONOXIDE SENSORS TO BE INSTALLED AS INDICATED ON PLAN, PER IRC R315
3.	LOCAL EXHAUST SYSTEMS INDICATED ON PLAN IN BATHROOMS, TO BE VENTED DIRECTLY TO THE OUTDOORS PER IRC R303.3
4.	LIGHT FIXTURES IN CLOSETS TO COMPLY WITH 4003.12 AND BE CENTERED ABOVE CLOSET DOOR
5.	ALL CEILINGS TO BE 5/8" GYPSUM, UNO
6.	LIGHT SWITCHES & ENVIRONMENTAL CONTROLS MUST BE NO HIGHER THAN 48" ABOVE THE INTERIOR FLOOR LEVEL
7.	ALL CEILINGS TO BE AT 9'-0" AFF, UNLESS NOTED OTHERWISE
8.	BATHROOM EXHAUST CENTER LINE ON TOILET, REFERENCE ADDITIONAL DIMENSIONS ON PLAN

LIGHTING FIXTURE LEGEND

TYPE MARK	COUNT	DESCRIPTION
F2	8	CEILING FAN WITH LIGHT
гz L1	o 47	6" RECESSED CAN LIGHT
L3	2	6" RECESSED CAN LIGHT
L3 L4	7	VANITY LIGHT
L5	5	CLOSET LIGHT
L10	11	OUTDOOR SCONCE
L15	6	PENDANT LIGHT
L20	3	48" FLUORESCENT LIGHT
VL1	3	CEILING VENTILATION FAN
VL2	3	BROAN 744 BATH FAN W/ LIGHT




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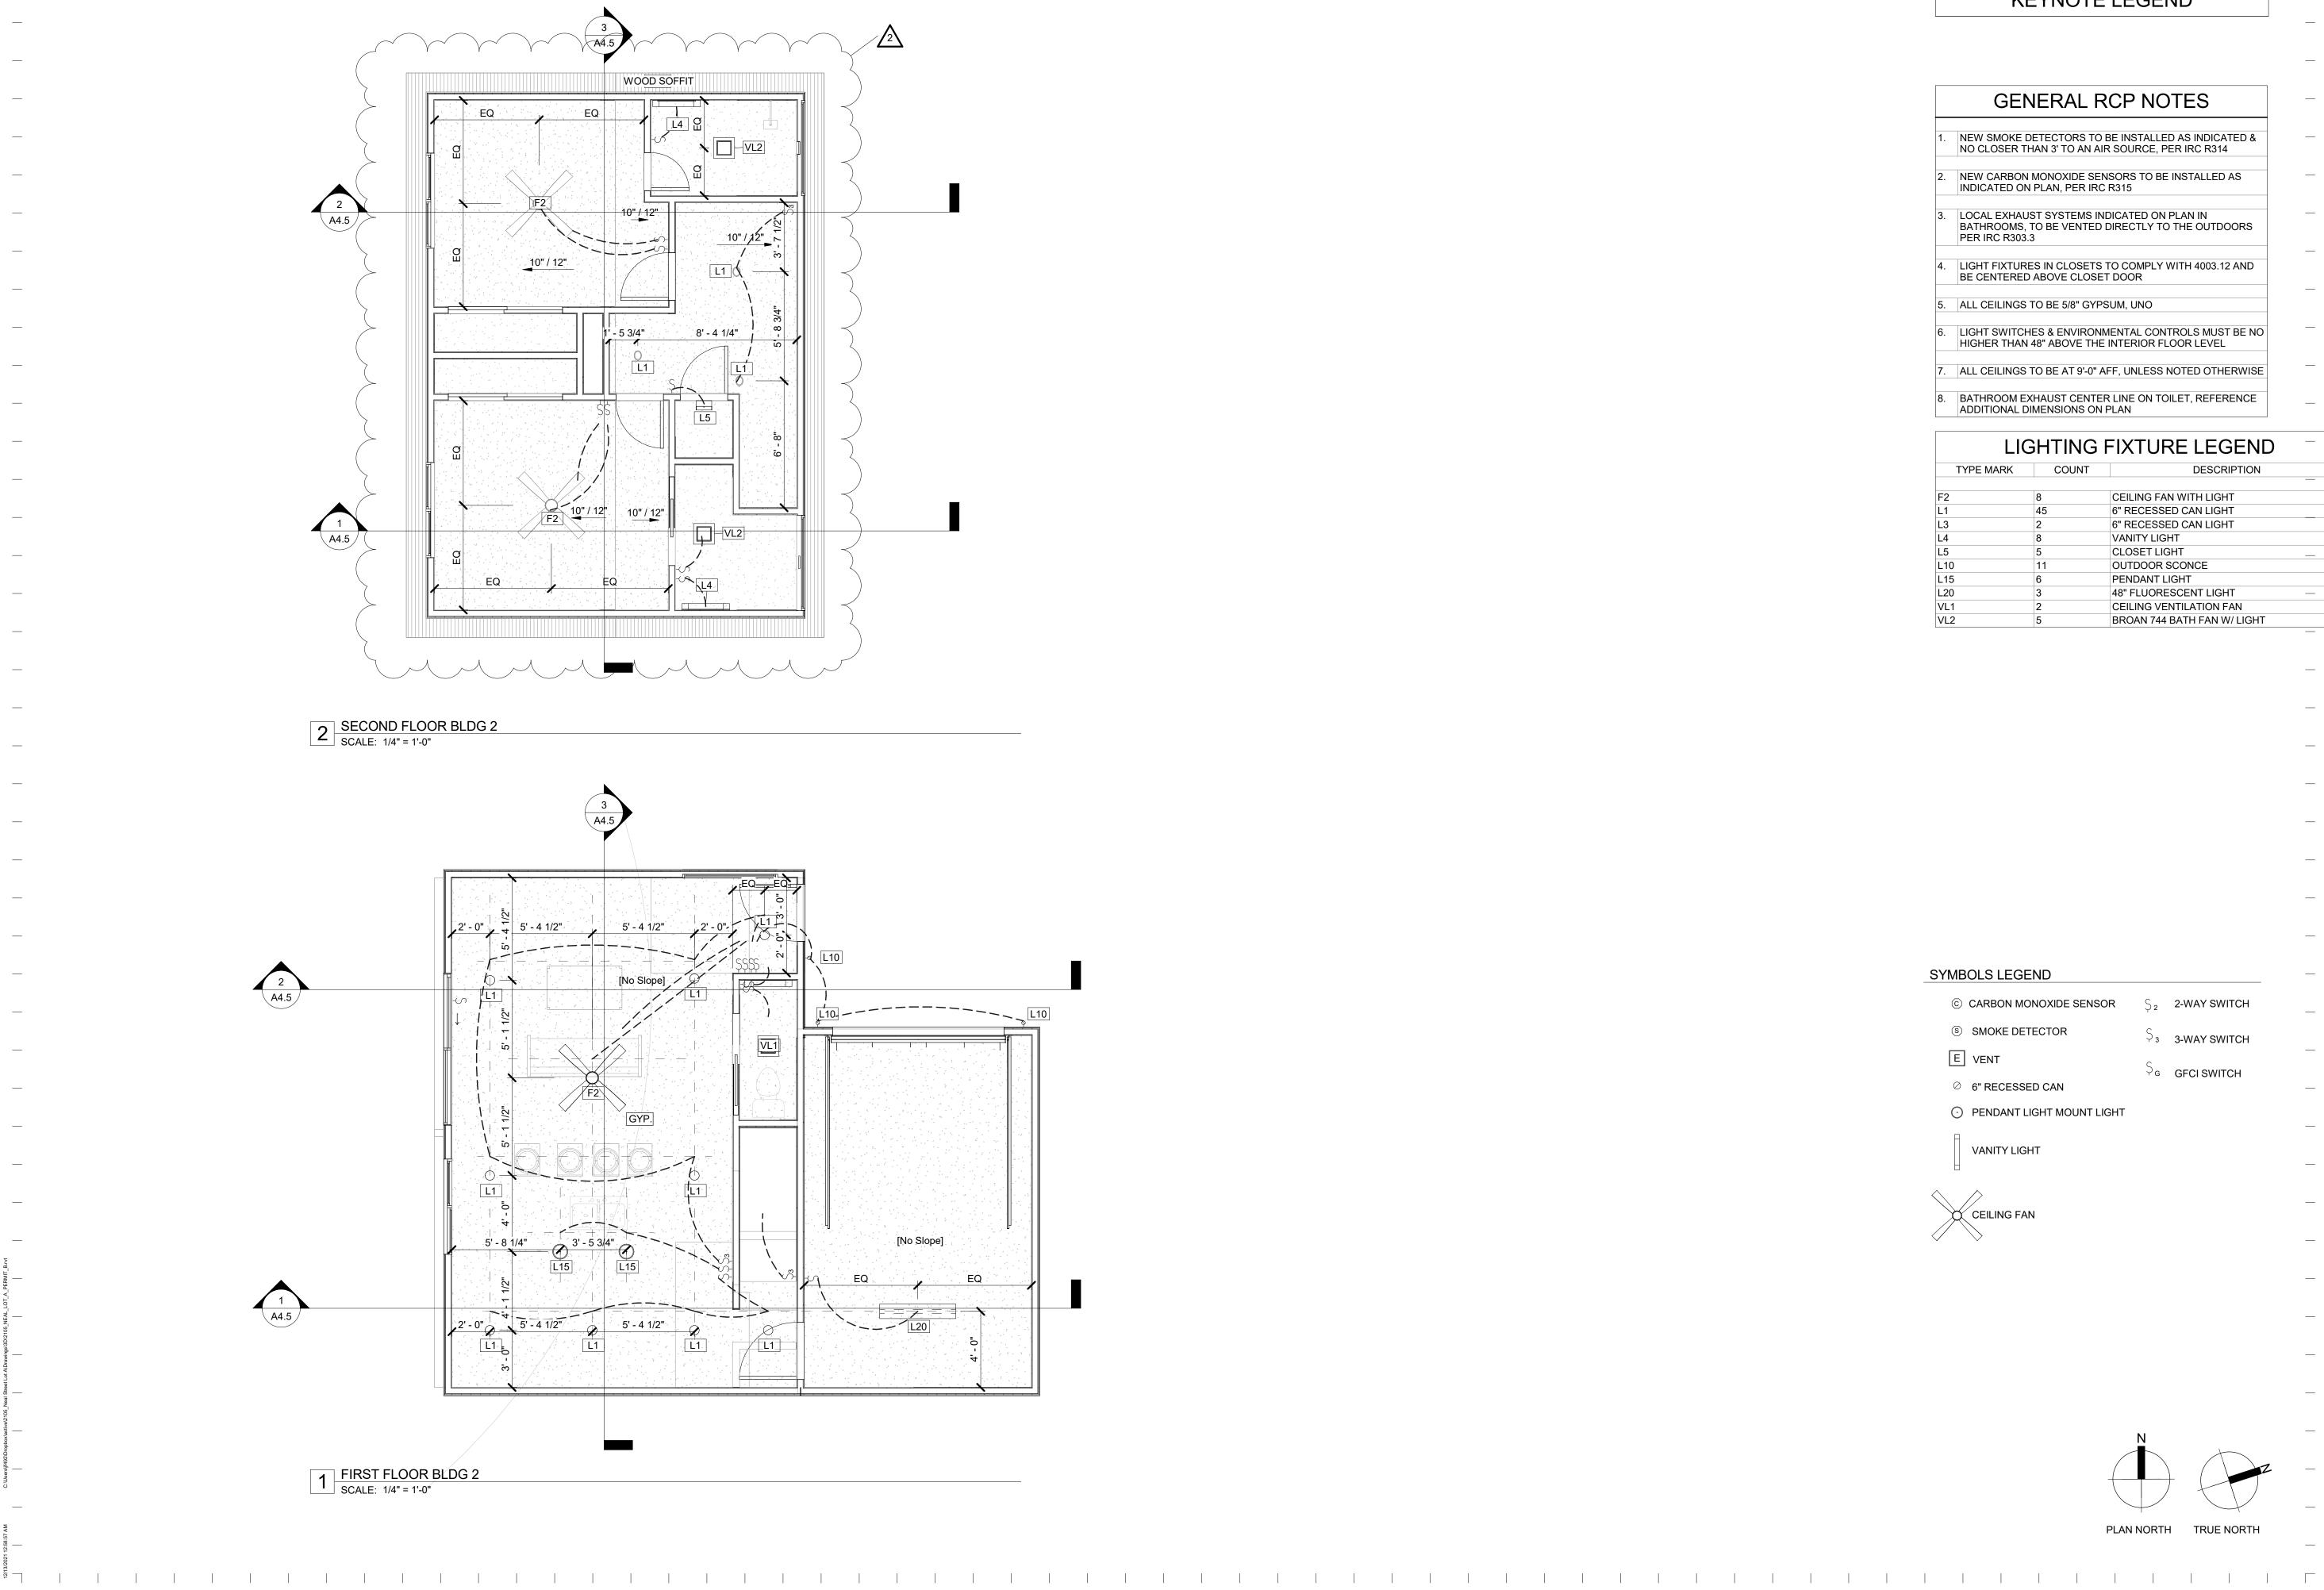
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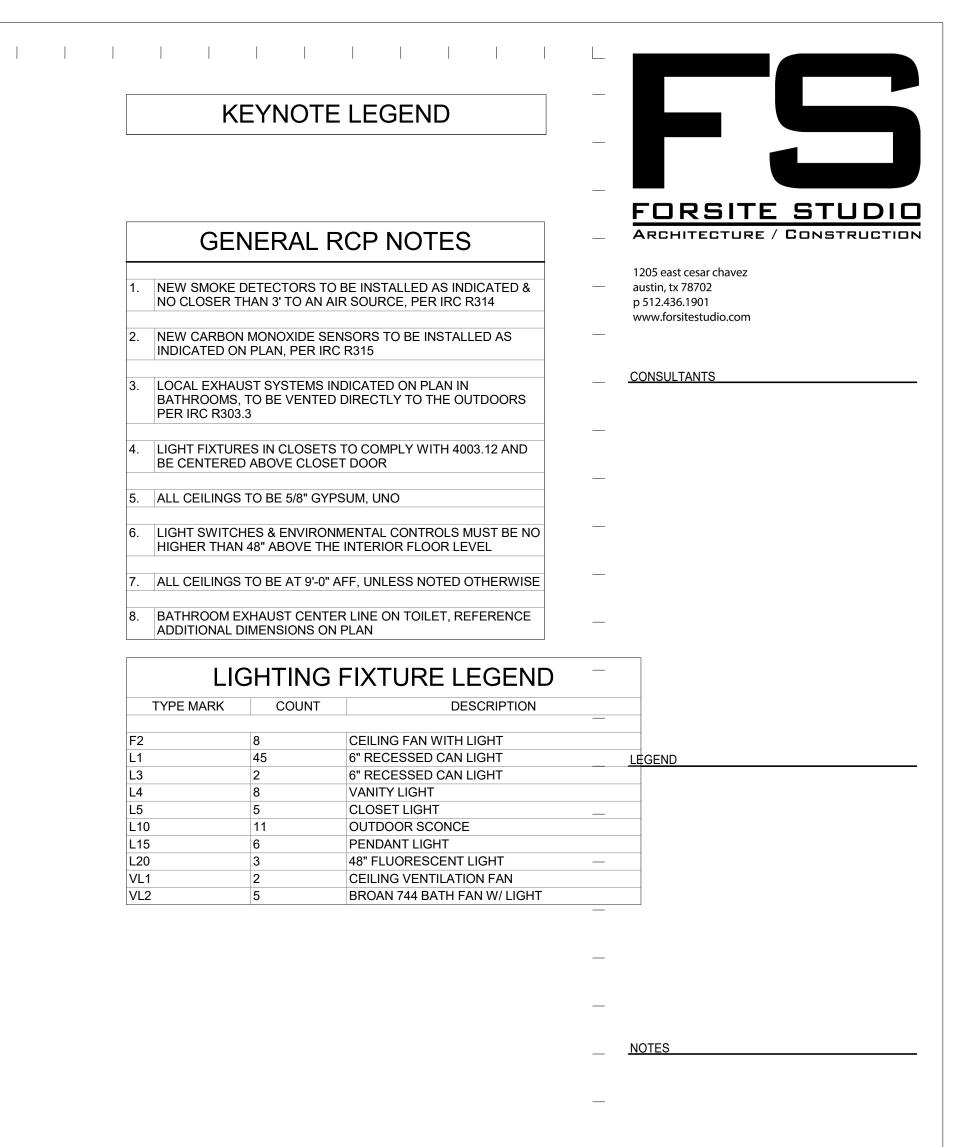
DATE



DRAWN BY



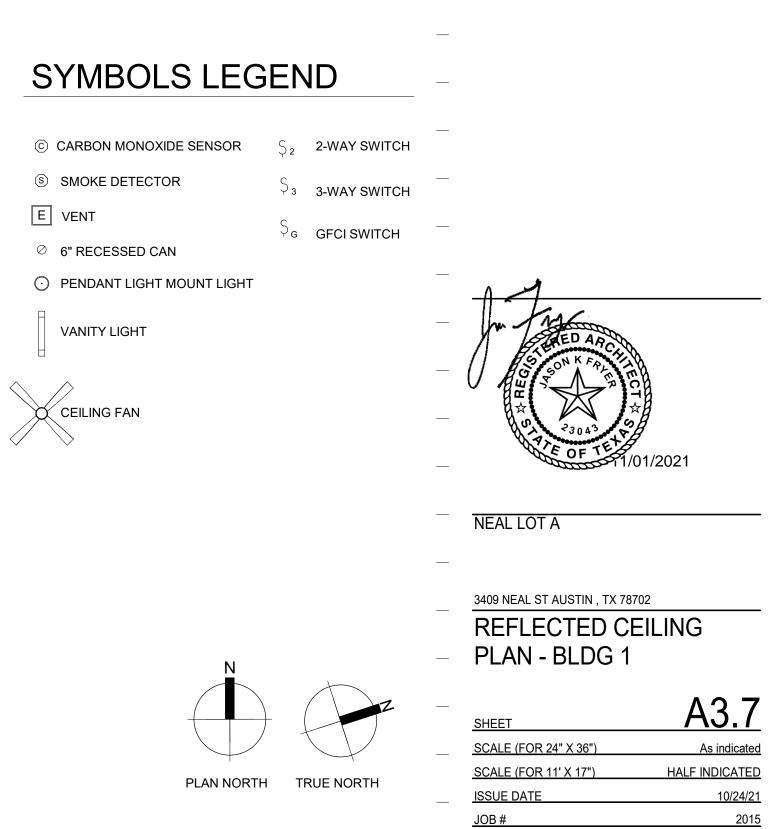



REVISI	ON	
NO.	DESCRIPTION	DATE
2	ASI 01	12/12/21

SYMBOLS LEGEND


- © CARBON MONOXIDE SENSOR S_2 2-WAY SWITCH
- SMOKE DETECTOR
- [♀]。 GFCI SWITCH

S₃ 3-WAY SWITCH

- ∅ 6" RECESSED CAN ○ PENDANT LIGHT MOUNT LIGHT
- VANITY LIGHT

E VENT

CEILING FAN

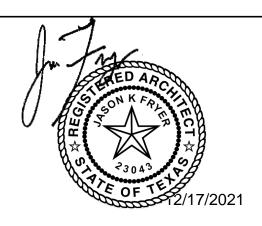


NEAL LOT A

3409 NEAL ST AUSTIN , TX 78702 **REFLECTED CEILING** – PLAN - BLDG 2

	Z	
NORTH	TRUE NORTH	


SHEET	A3.8
SHEET	, , , , , , , , , , , , , , , , , , , ,
SCALE (FOR 24" X 36")	As indicated
SCALE (FOR 11' X 17")	HALF INDICATED
ISSUE DATE	10/24/21
JOB #	2015
DRAWN BY	TL

PLAN

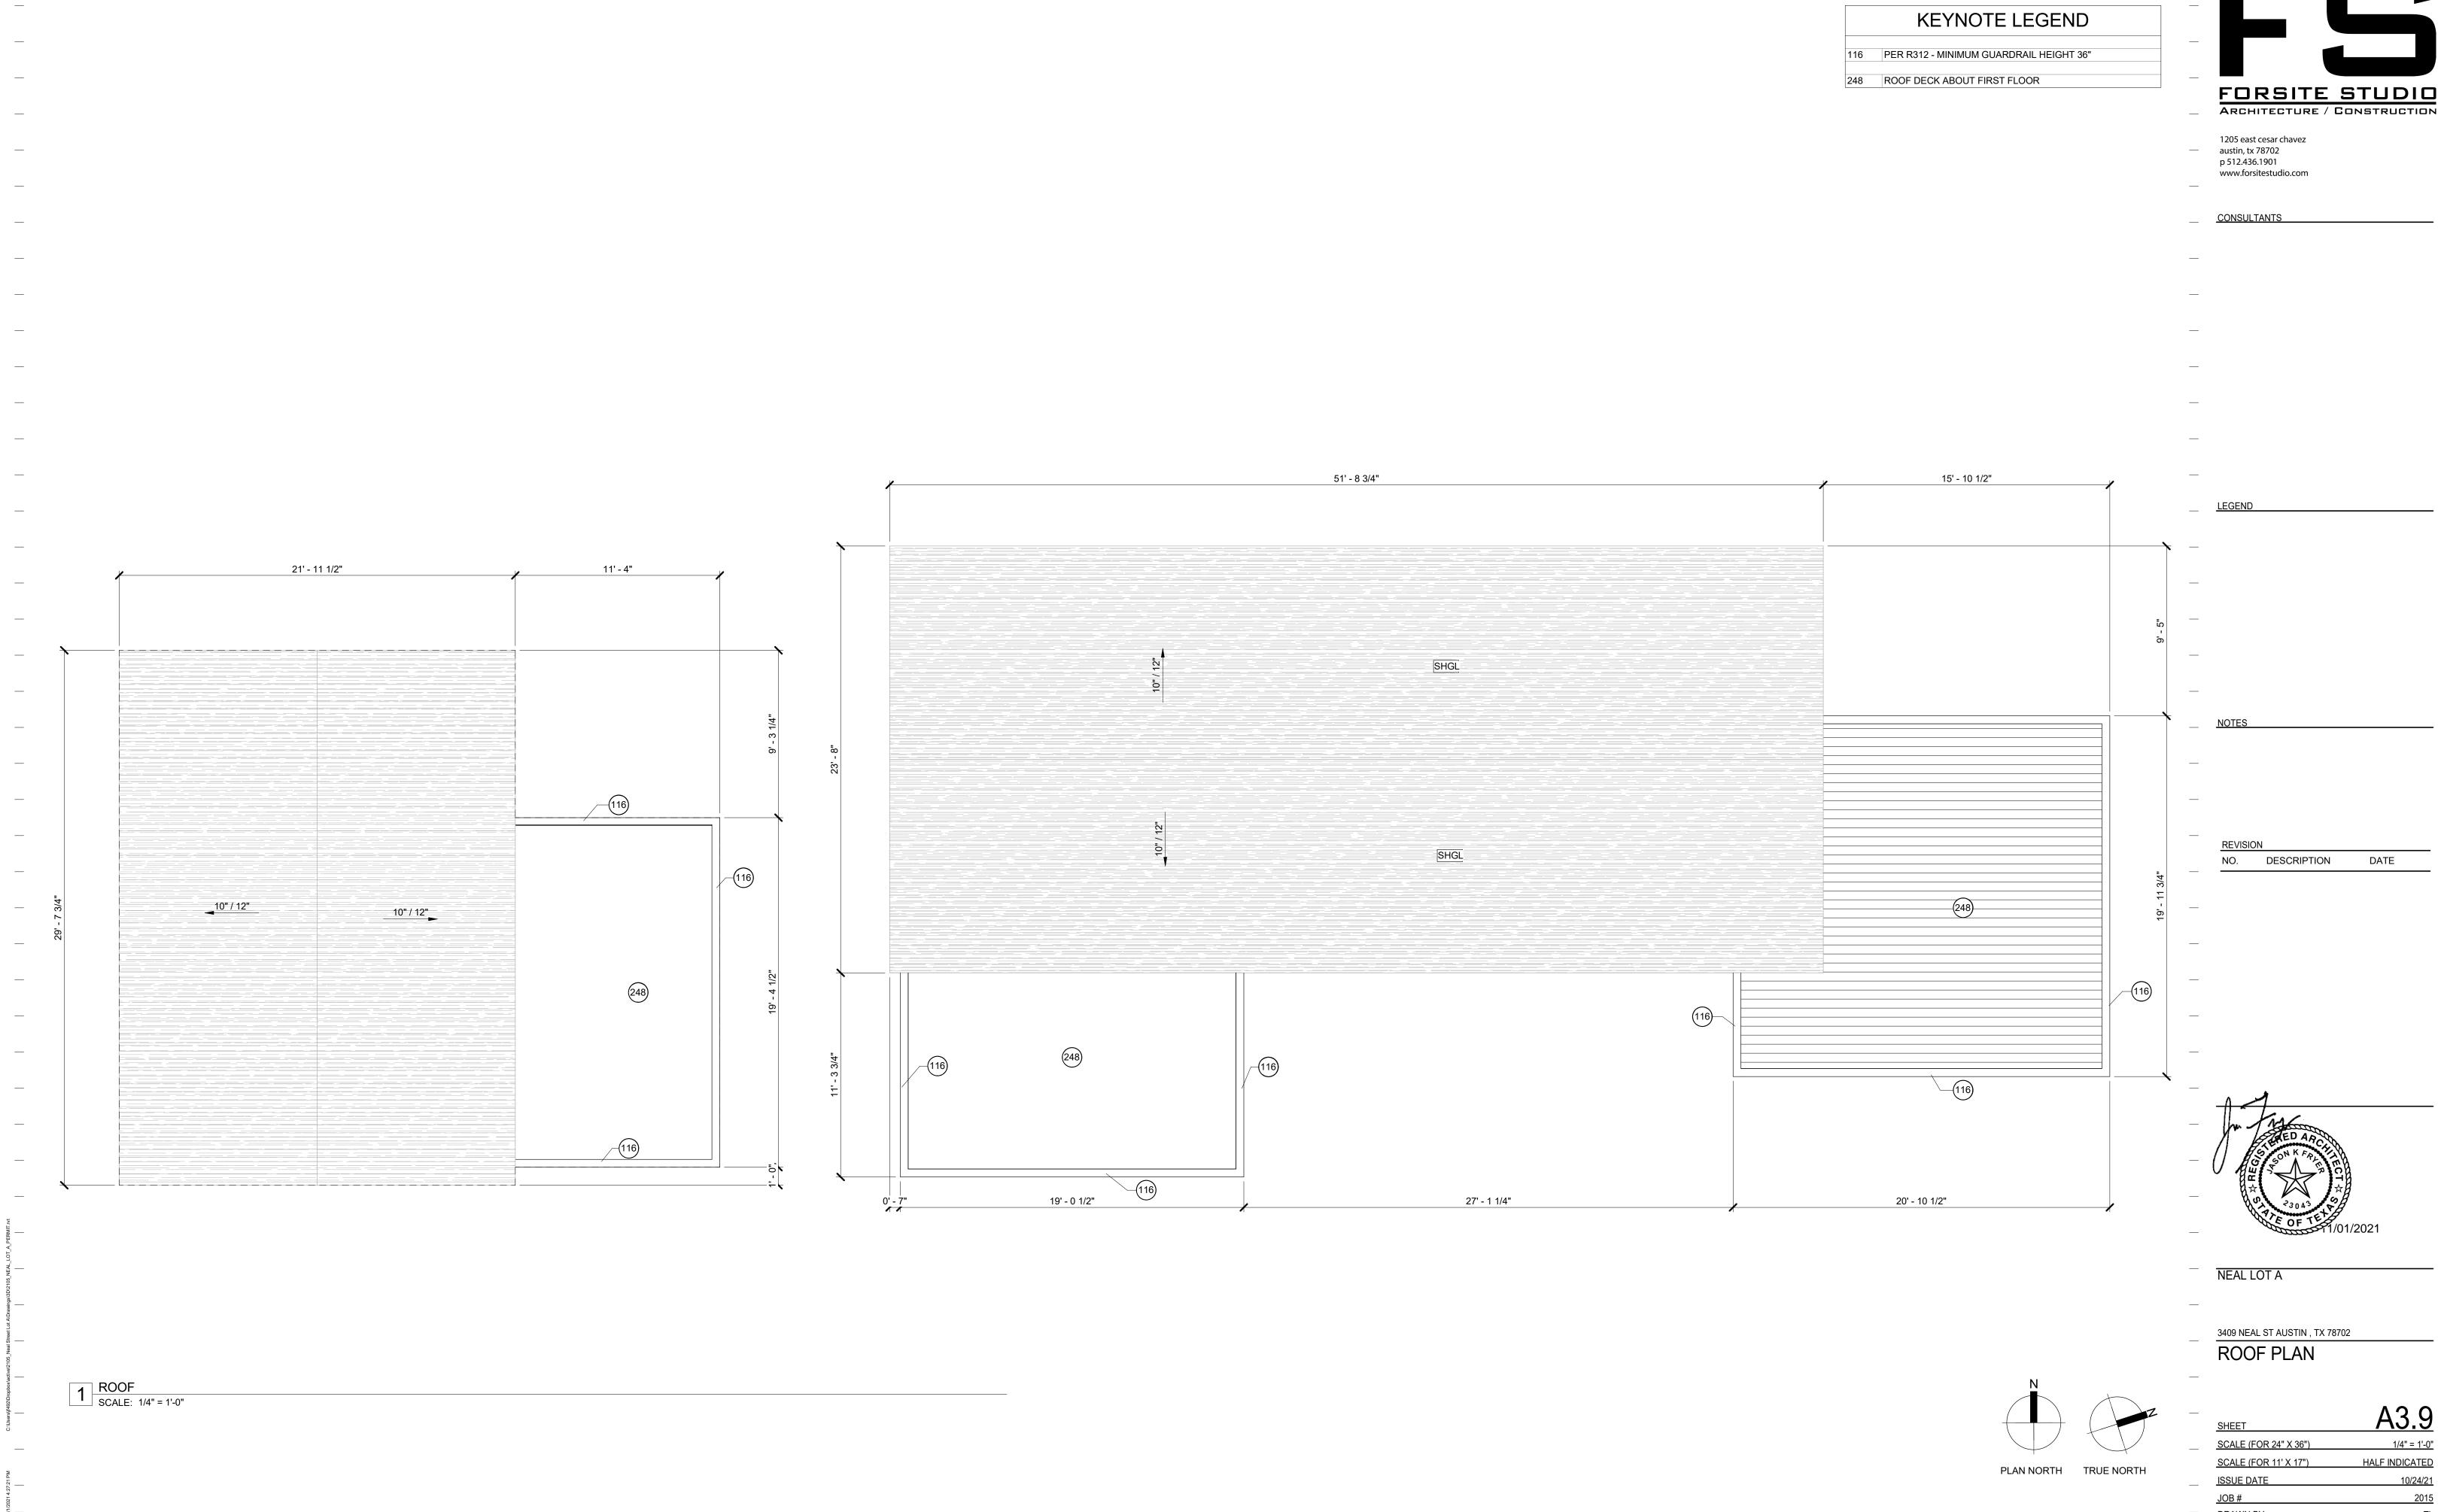

KEYNOTE LEGEND



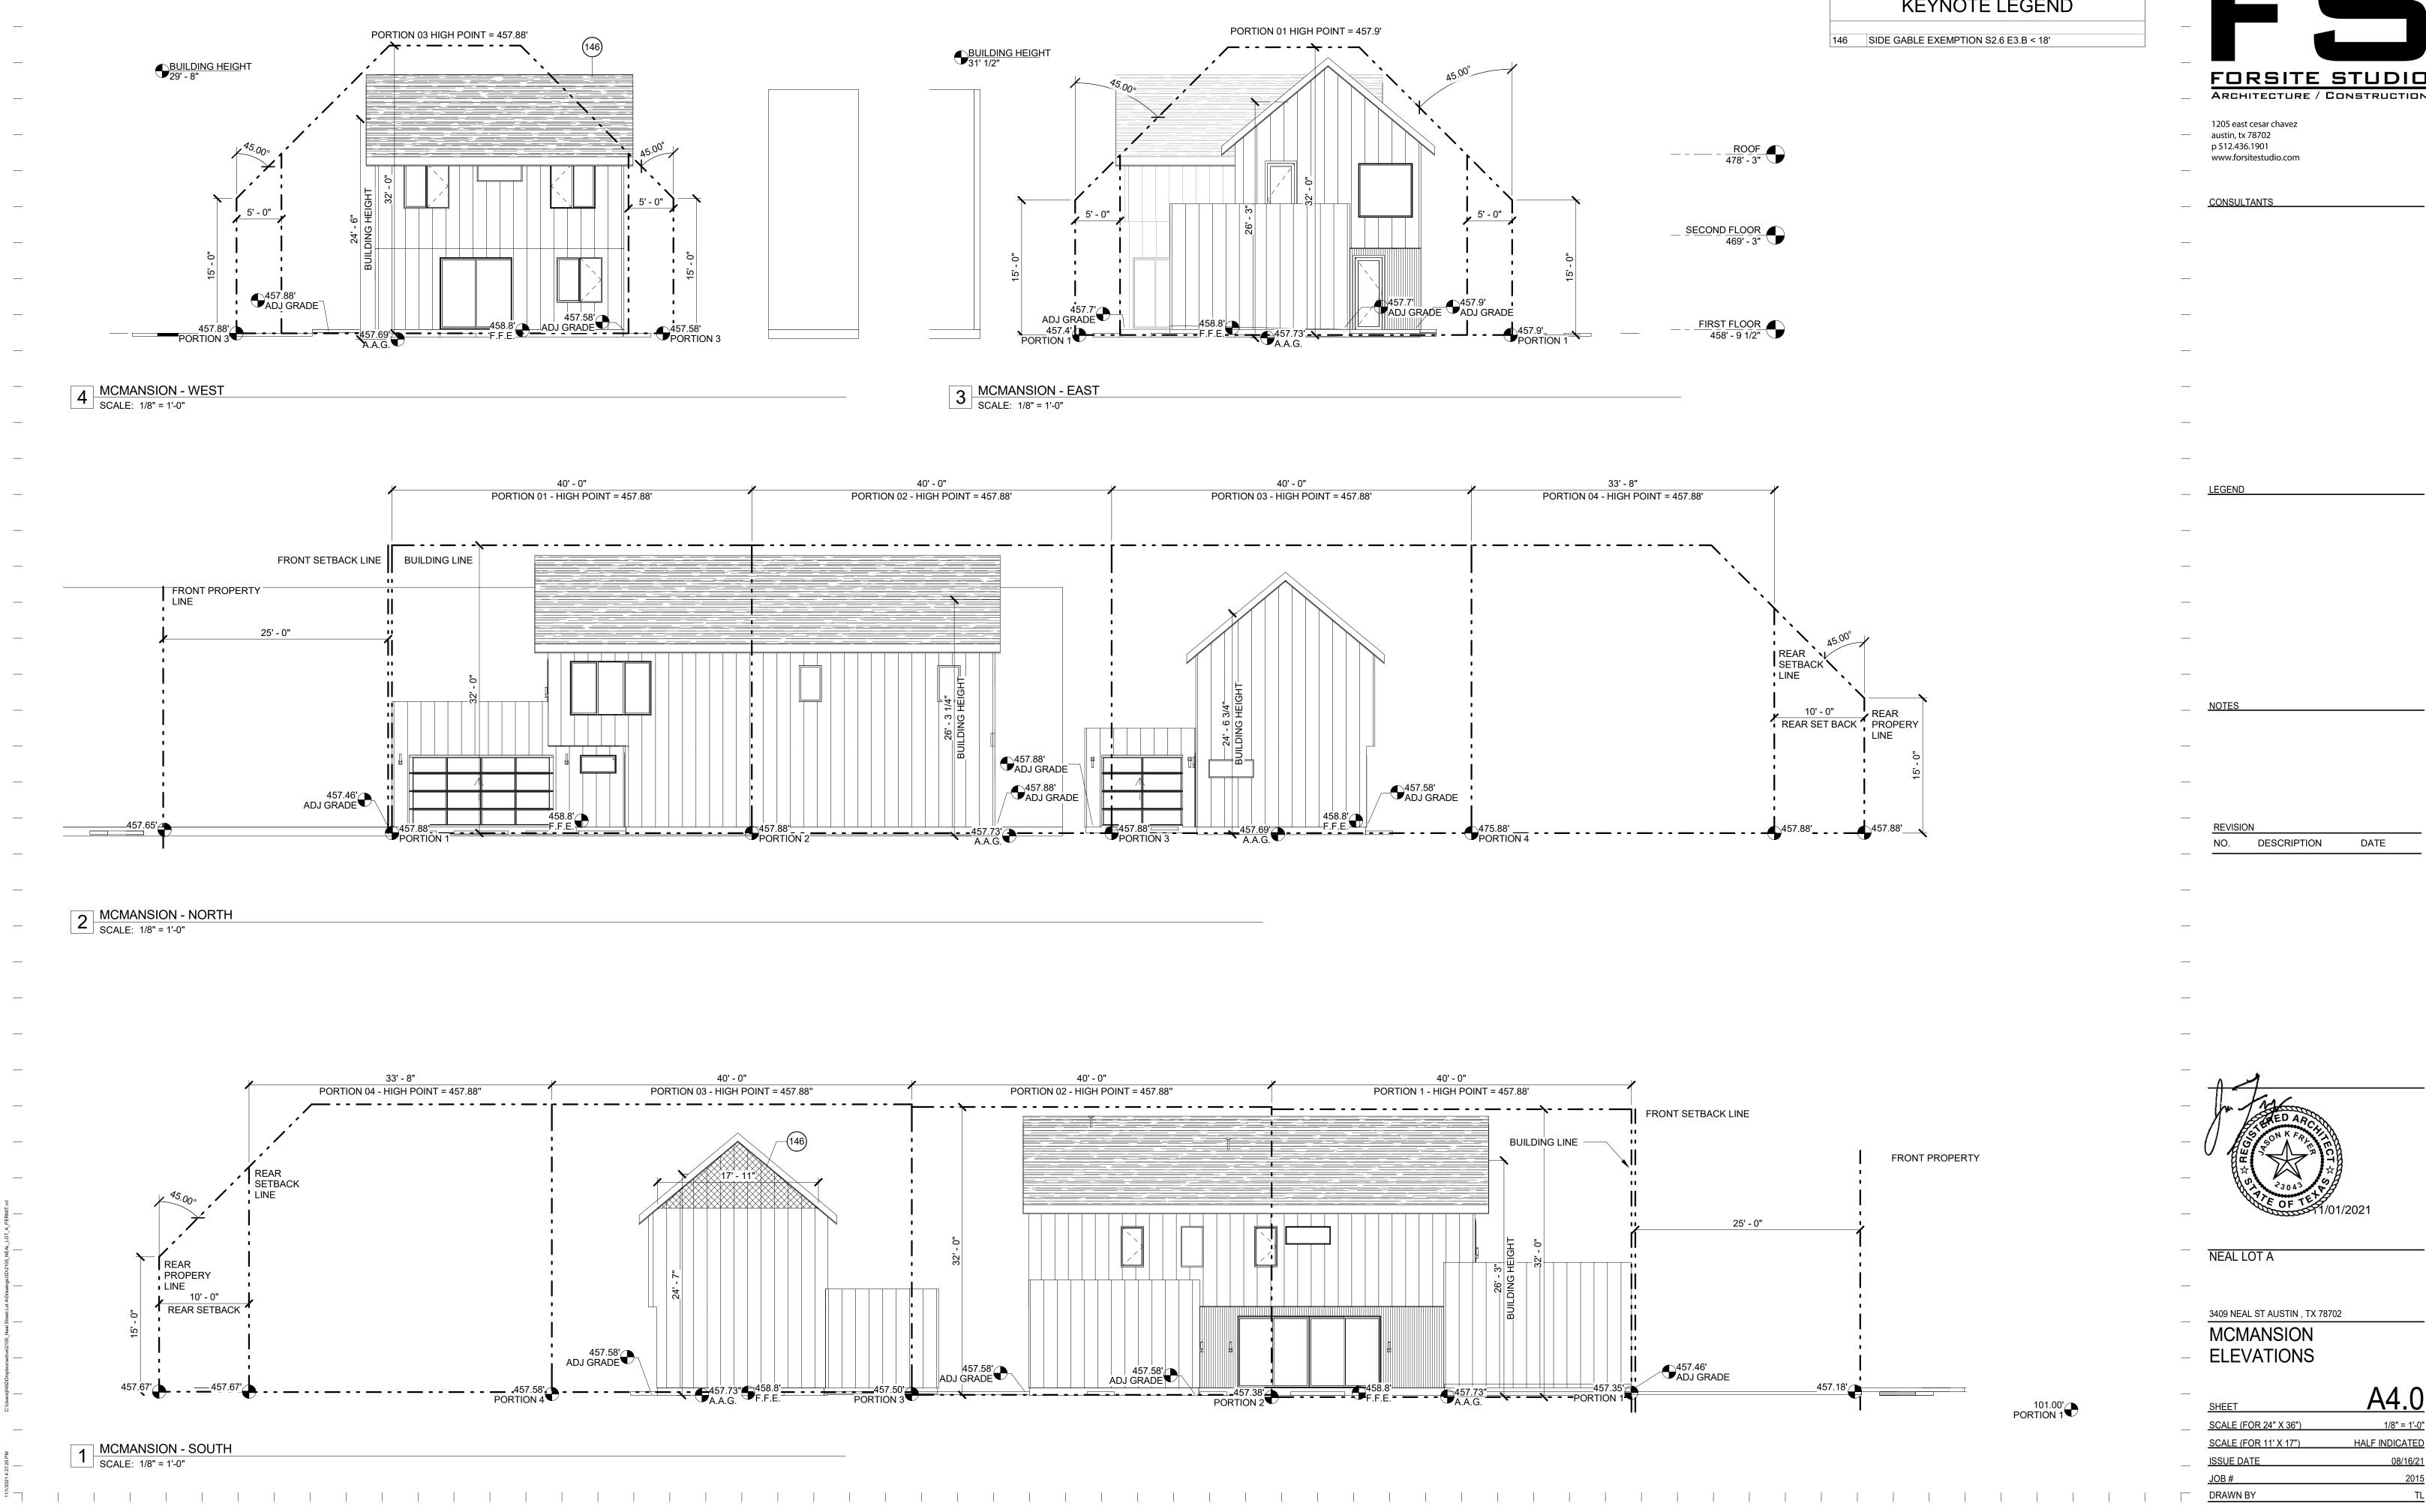










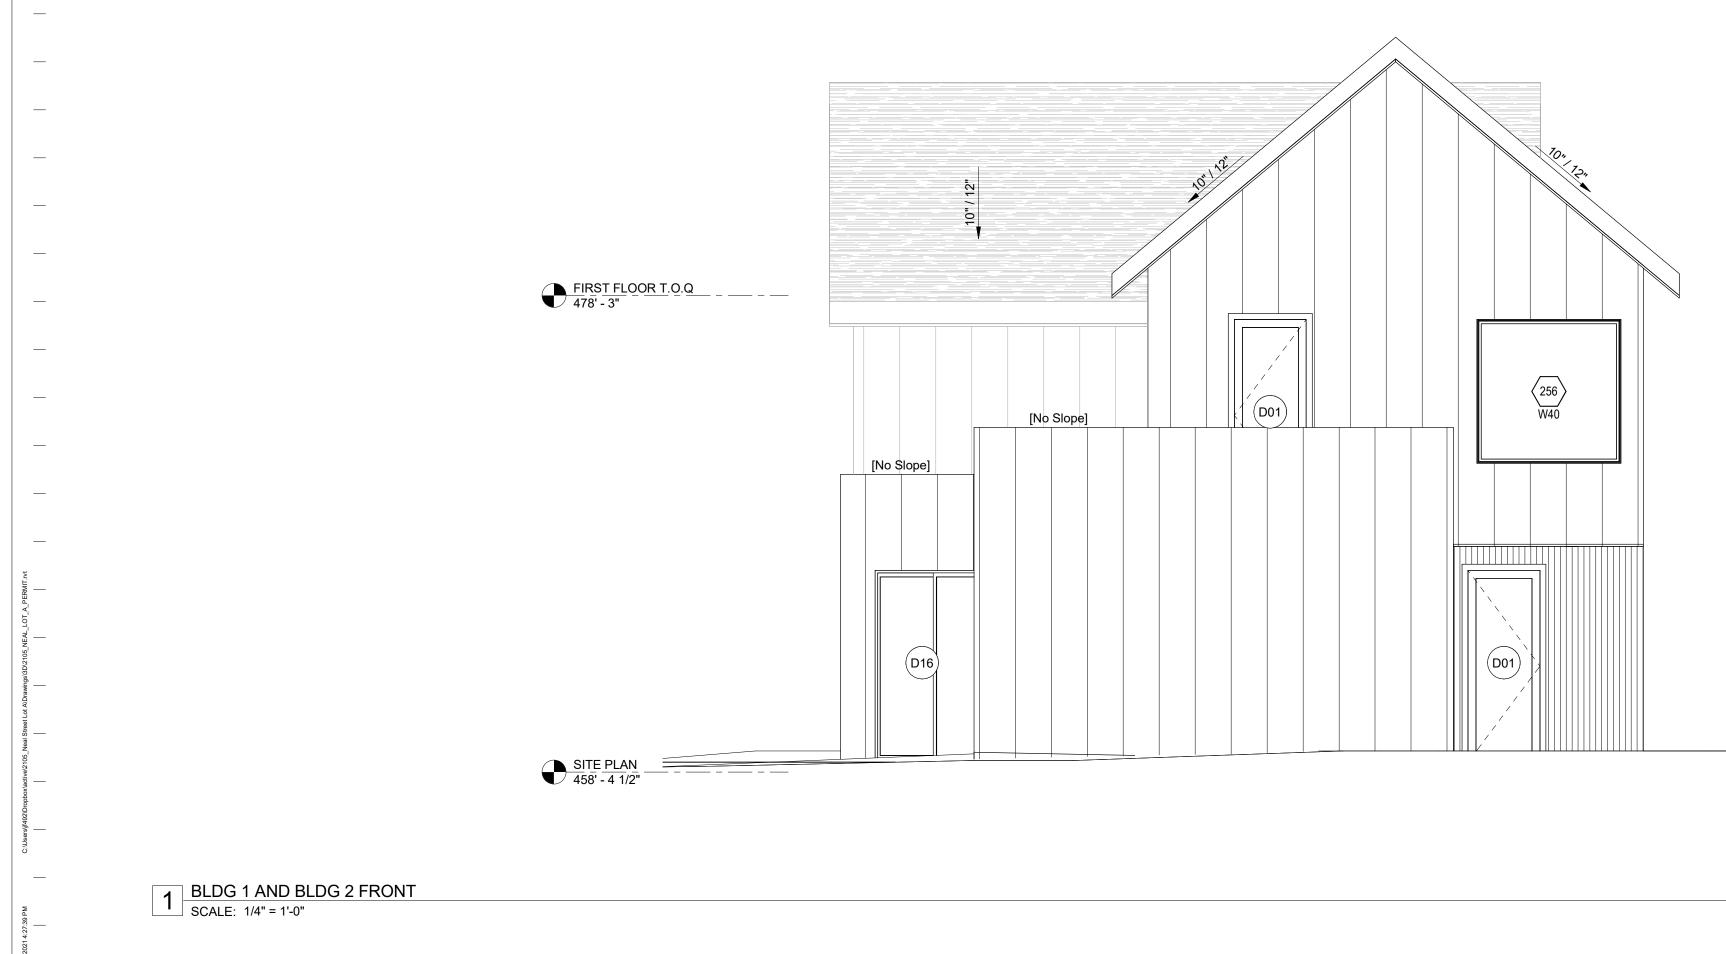

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KEYNOTE LEGEND



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CONSULTANTS


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MATERIAL LEGEND

MTL SD VERTICAL METAL SIDING SD 2 BOARD AND BATTEN VERTICAL WOOD SIDING WD

REVISION


NO. DESCRIPTION DATE

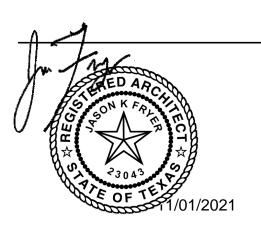

NEAL LOT A

3409 NEAL ST AUSTIN , TX 78702 ELEVATIONS

	Λ/1
SHEET	<u> </u>
SCALE (FOR 24" X 36")	As indicated
SCALE (FOR 11' X 17")	HALF INDICATED
ISSUE DATE	10/24/21
JOB #	2015
DRAWN BY	TL

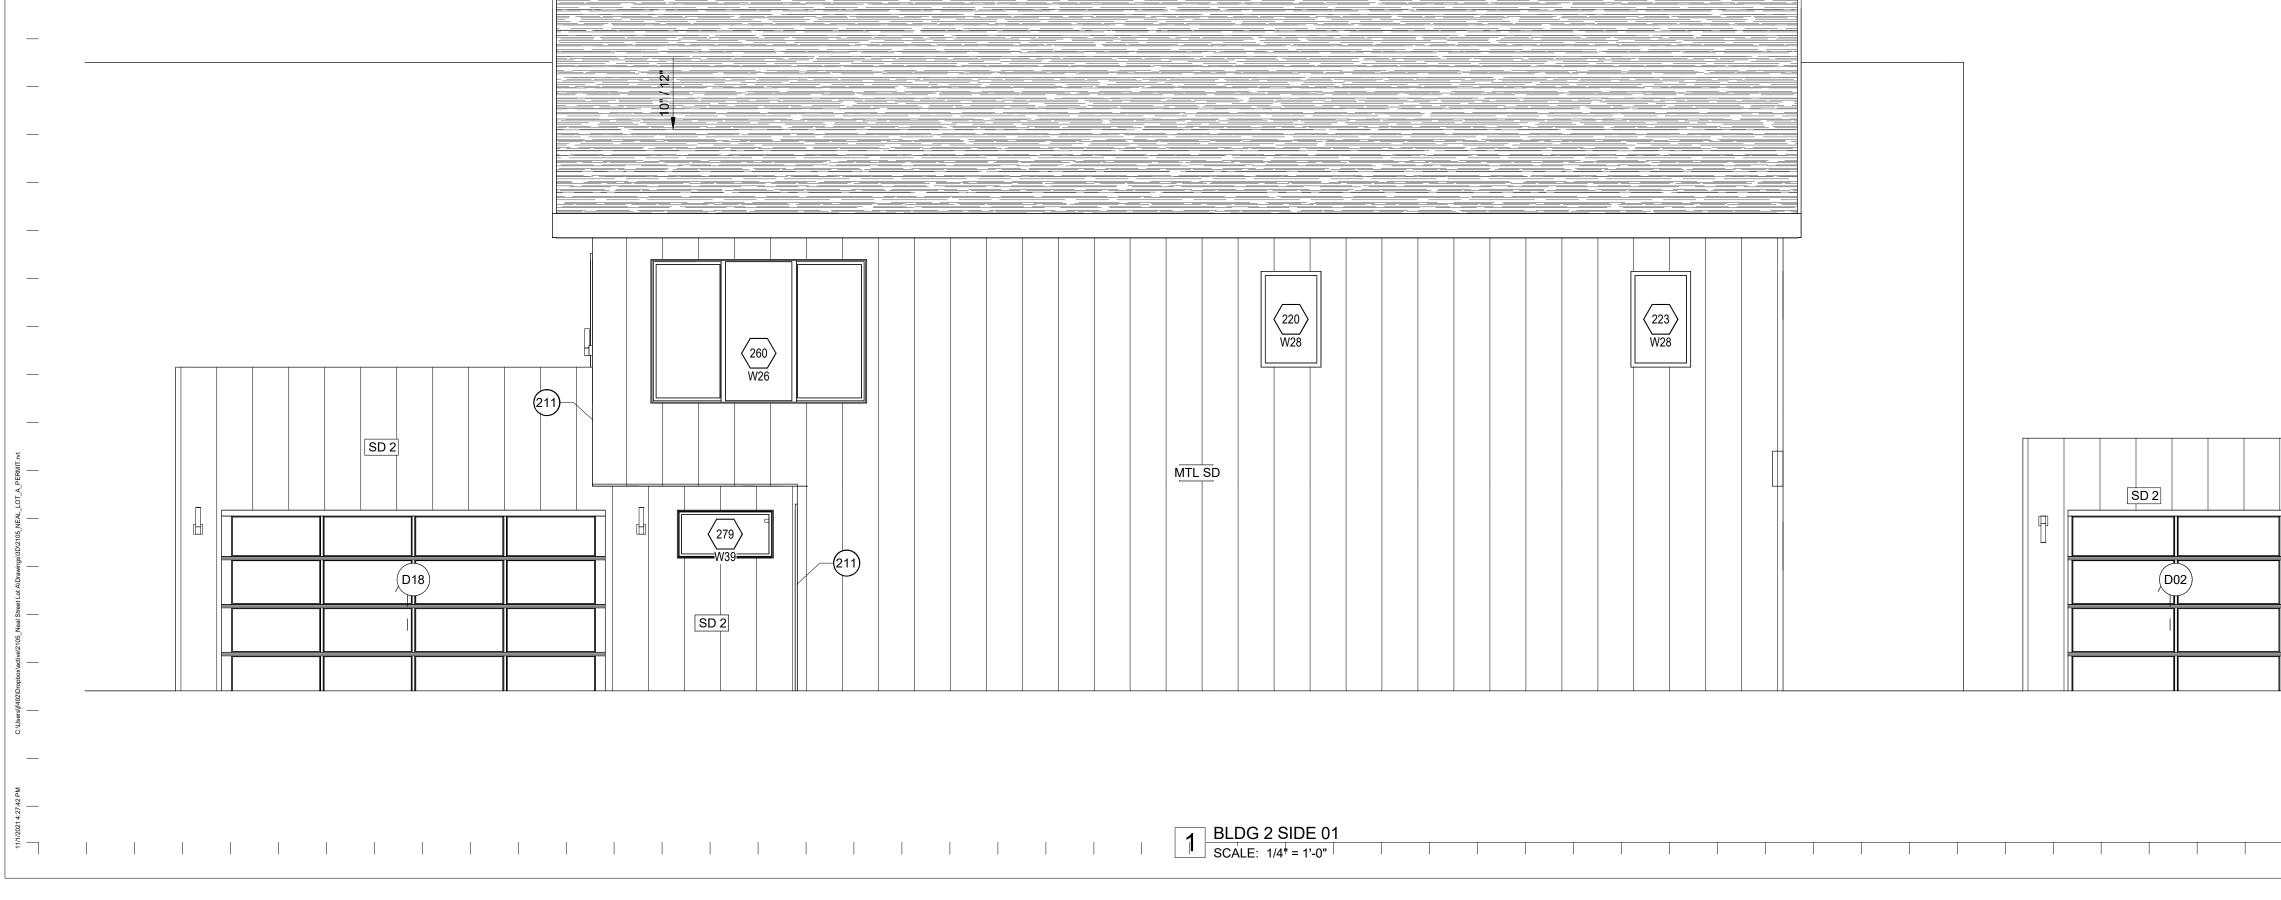

- 2 BLDG 1 AND BLDG 2 REAR SCALE: 1/4" = 1'-0"

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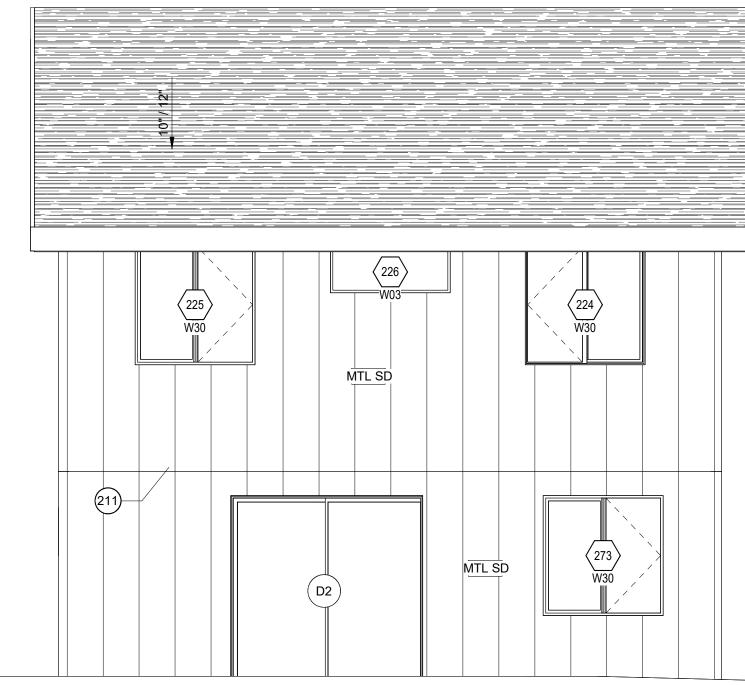
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KEYNOTE LEGEND

211 CHANGE OF WALL PLANE - REFERENCE PLAN



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CONSULTANTS


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MATERIAL LEGEND

MTL SD	VERTICAL METAL SIDING					
SD 2	BOARD AND BATTEN					
WD	VERTICAL WOOD SIDING					

LEGEND

REVISION NO. DESCRIPTION DATE

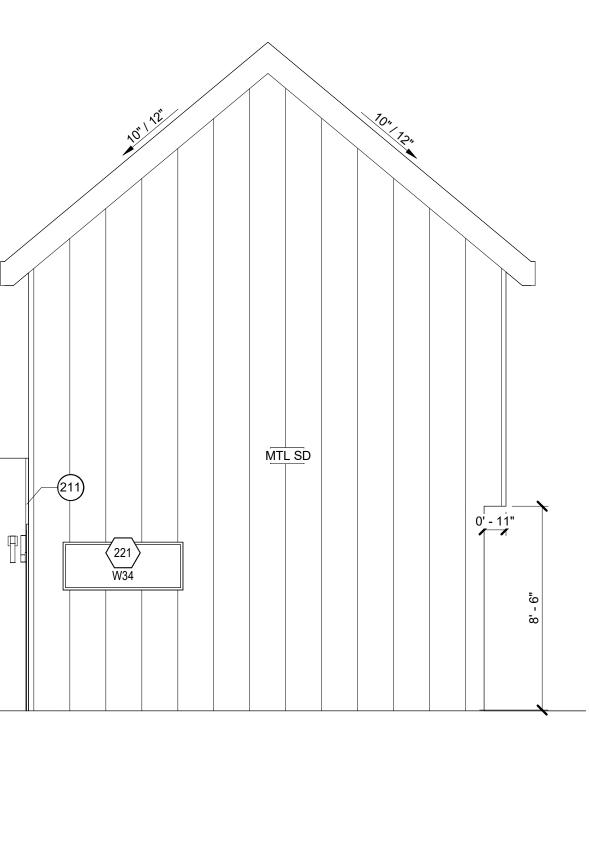


NEAL LOT A


3409 NEAL ST AUSTIN , TX 78702 ELEVATIONS

SHEET	A4.2
SCALE (FOR 24" X 36")	1/4" = 1'-0"
SCALE (FOR 11' X 17")	HALF INDICATED
ISSUE DATE	10/24/21
JOB #	2015
DRAWN BY	TL



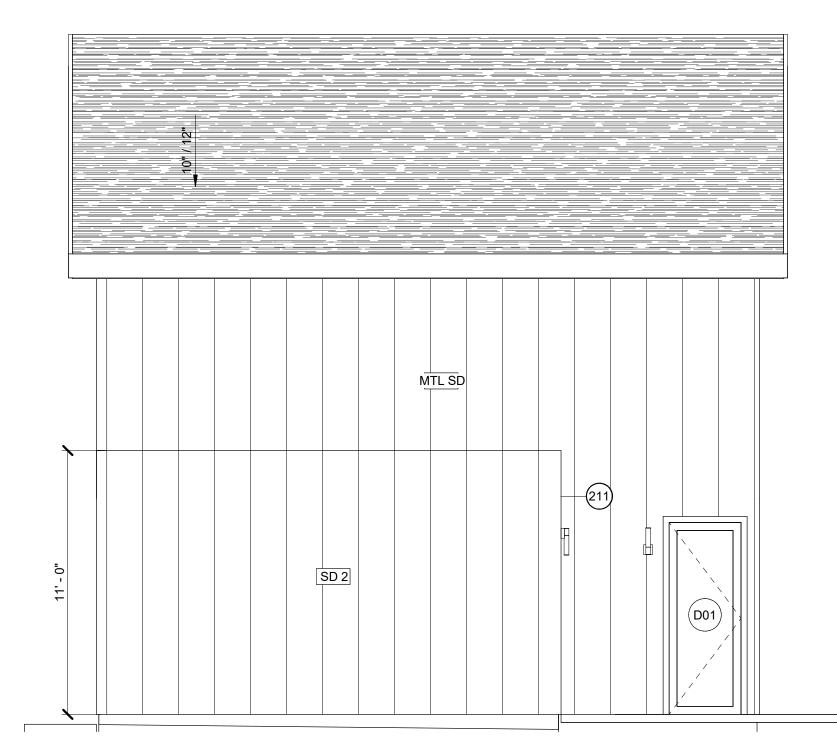



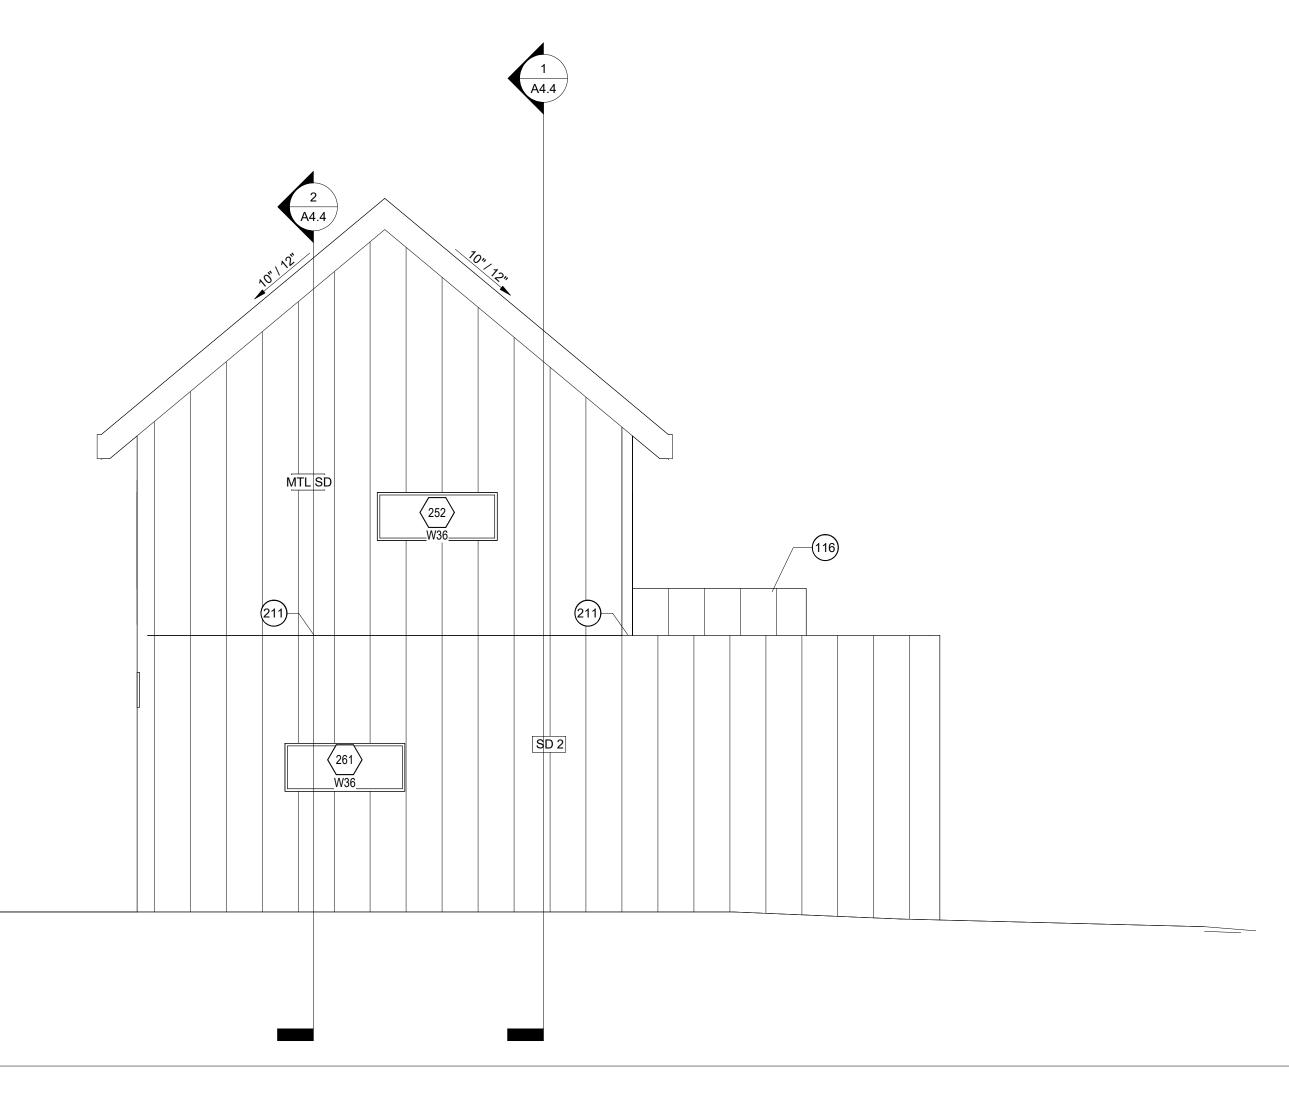

2 BLDG 2 SIDE 02 SCALE: 1/4" = 1'-0"

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KEYNOTE LEGEND

116 PER R312 - MINIMUM GUARDRAIL HEIGHT 36" 211 CHANGE OF WALL PLANE - REFERENCE PLAN



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MATERIAL LEGEND

MTL SD VERTICAL METAL SIDING

SD 2 BOARD AND BATTEN WD VERTICAL WOOD SIDING

REVISION NO. DESCRIPTION


DATE



NEAL LOT A

3409 NEAL ST AUSTIN , TX 78702 **ELEVATIONS**

SHEET	A4.3
SCALE (FOR 24" X 36")	1/4" = 1'-0"
SCALE (FOR 11' X 17")	HALF INDICATED
ISSUE DATE	10/24/21
JOB #	2015
DRAWN BY	TL

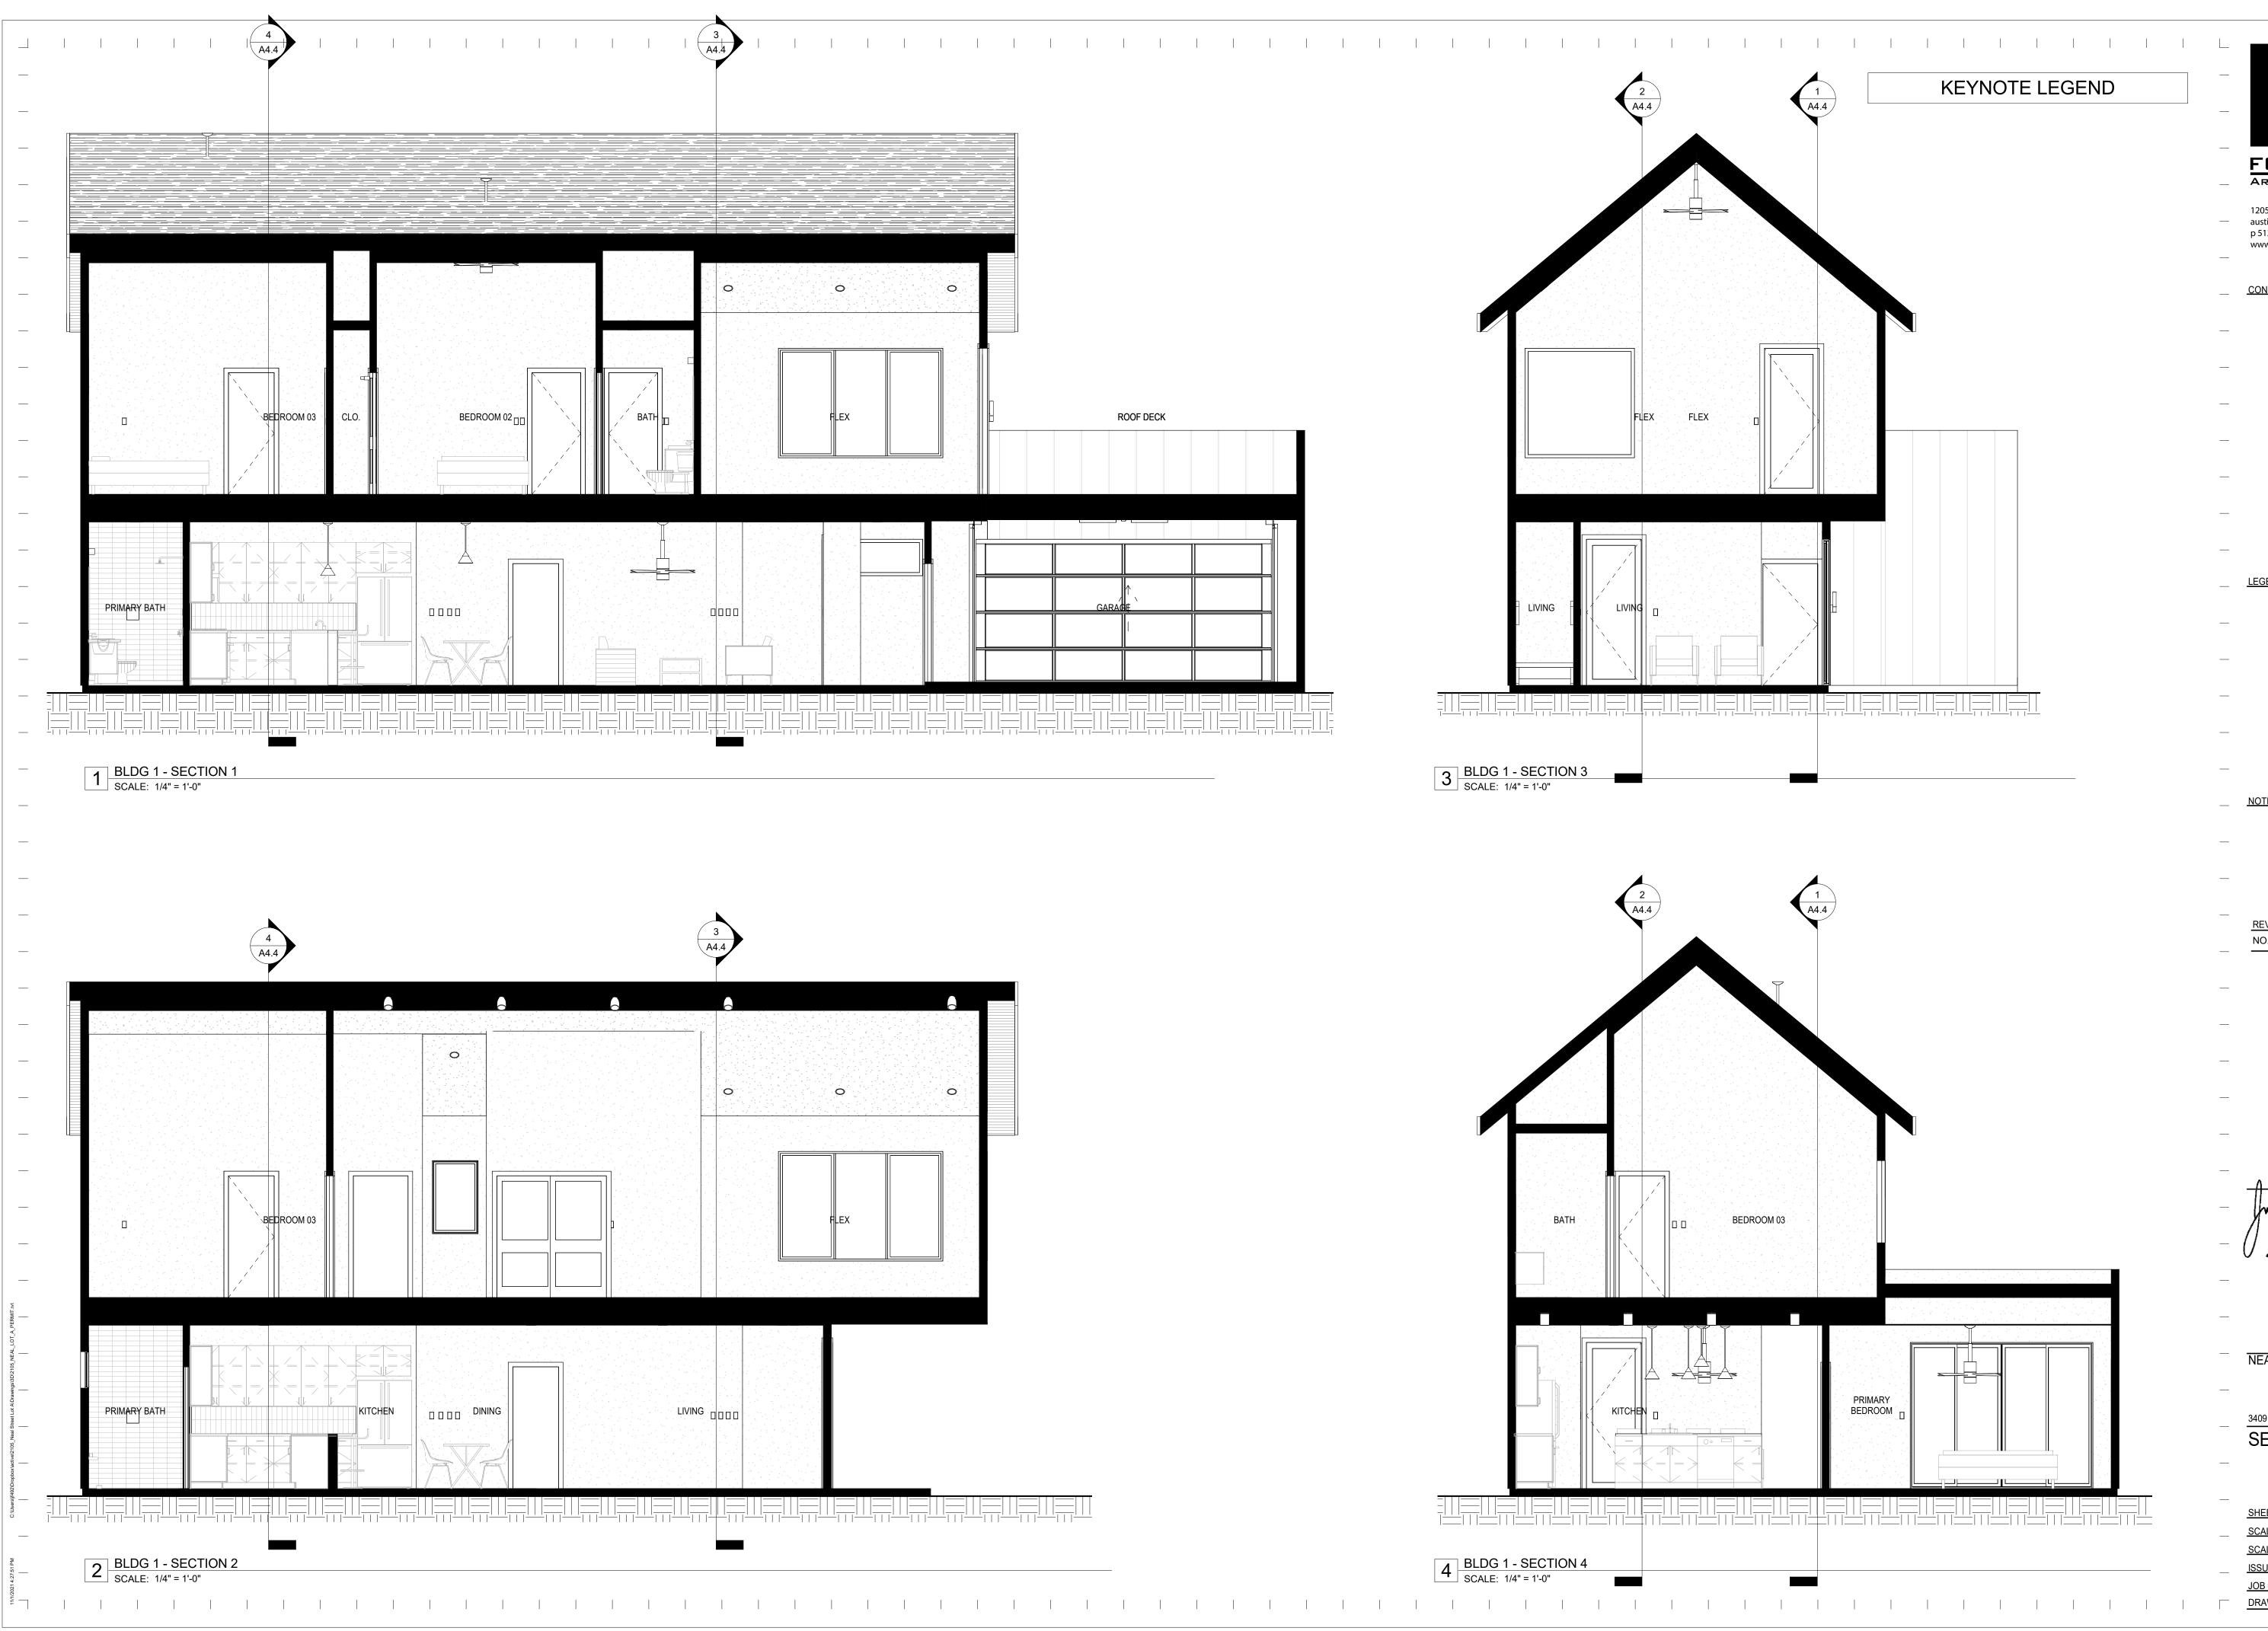




FORSITE STUDIO ARCHITECTURE / CONSTRUCTION 1205 east cesar chavez

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CONSULTANTS

NO. DESCRIPTION

DATE

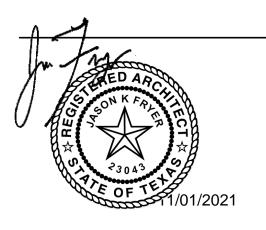


NEAL LOT A

3409 NEAL ST AUSTIN , TX 78702 SECTIONS


SHEET	A4.4
SCALE (FOR 24" X 36")	1/4" = 1'-0"
SCALE (FOR 11' X 17")	HALF INDICATED
ISSUE DATE	10/24/21
JOB #	2015
DRAWN BY	TL

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REVISION
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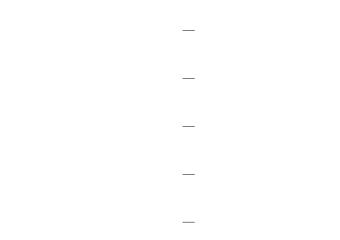


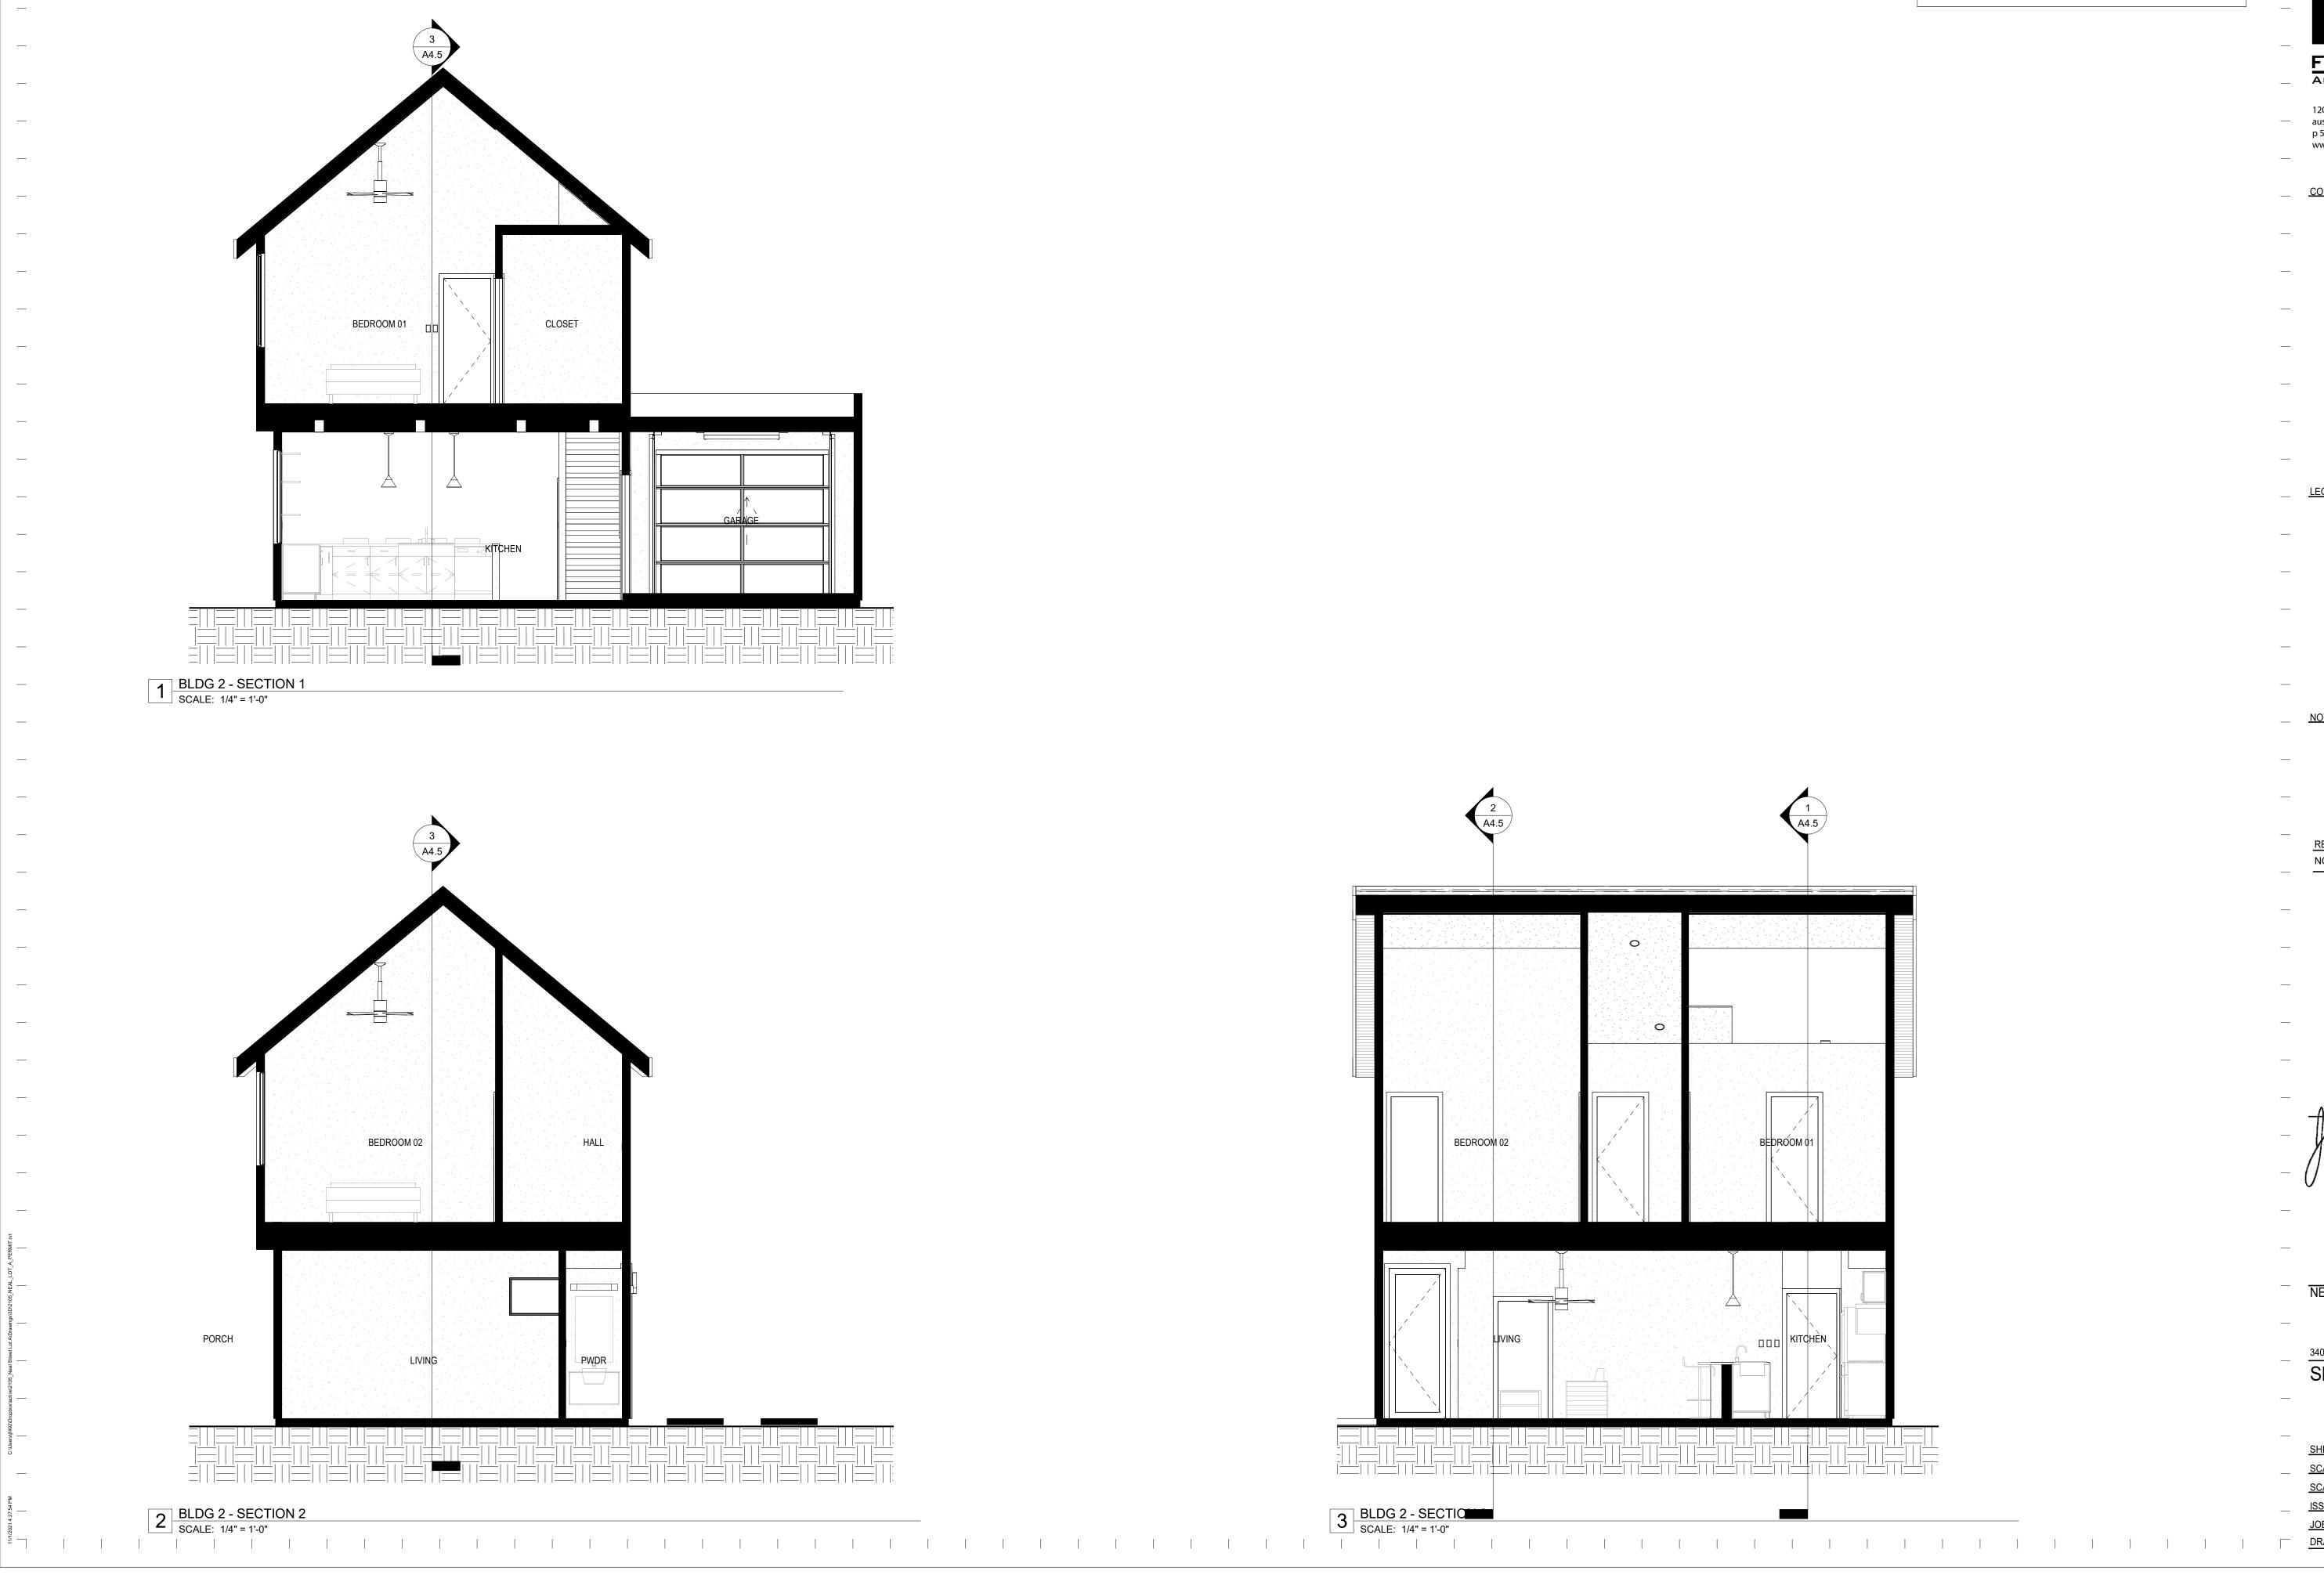

KEYNOTE LEGEND

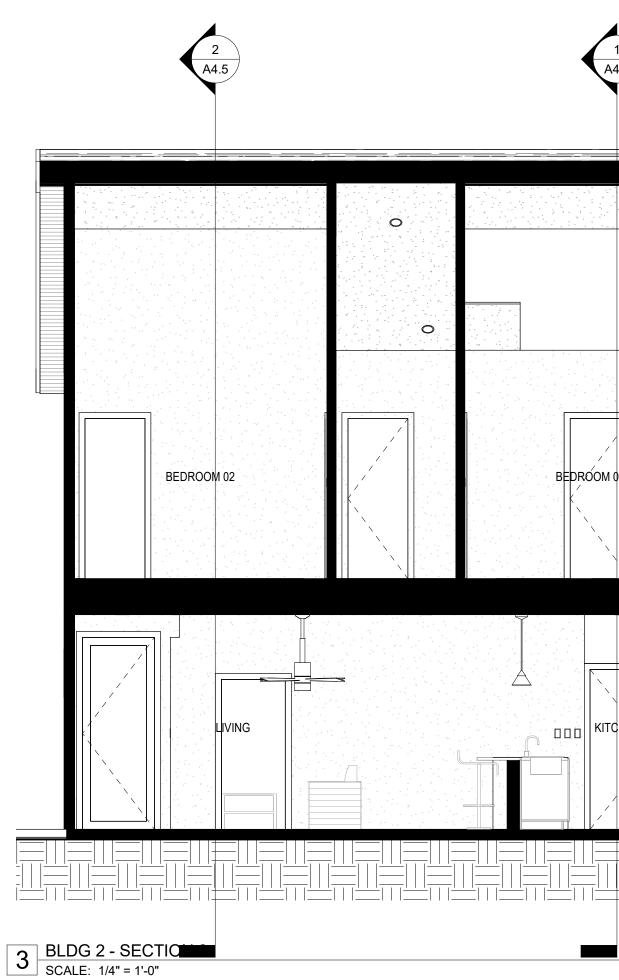

<u>CONSULTANTS</u>





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REVISION


NO. DESCRIPTION DATE




NEAL LOT A


3409 NEAL ST AUSTIN , TX 78702 SECTIONS

SHEET	A4.5
SCALE (FOR 24" X 36")	1/4" = 1'-0"
SCALE (FOR 11' X 17")	HALF INDICATED
ISSUE DATE	10/24/21
JOB #	2015
DRAWN BY	TL

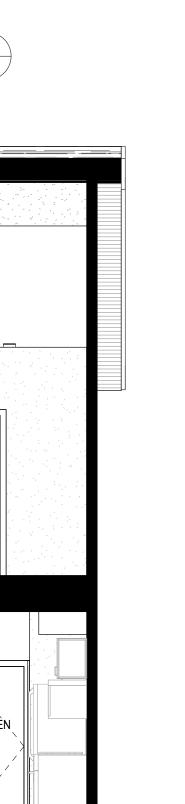

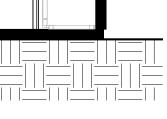



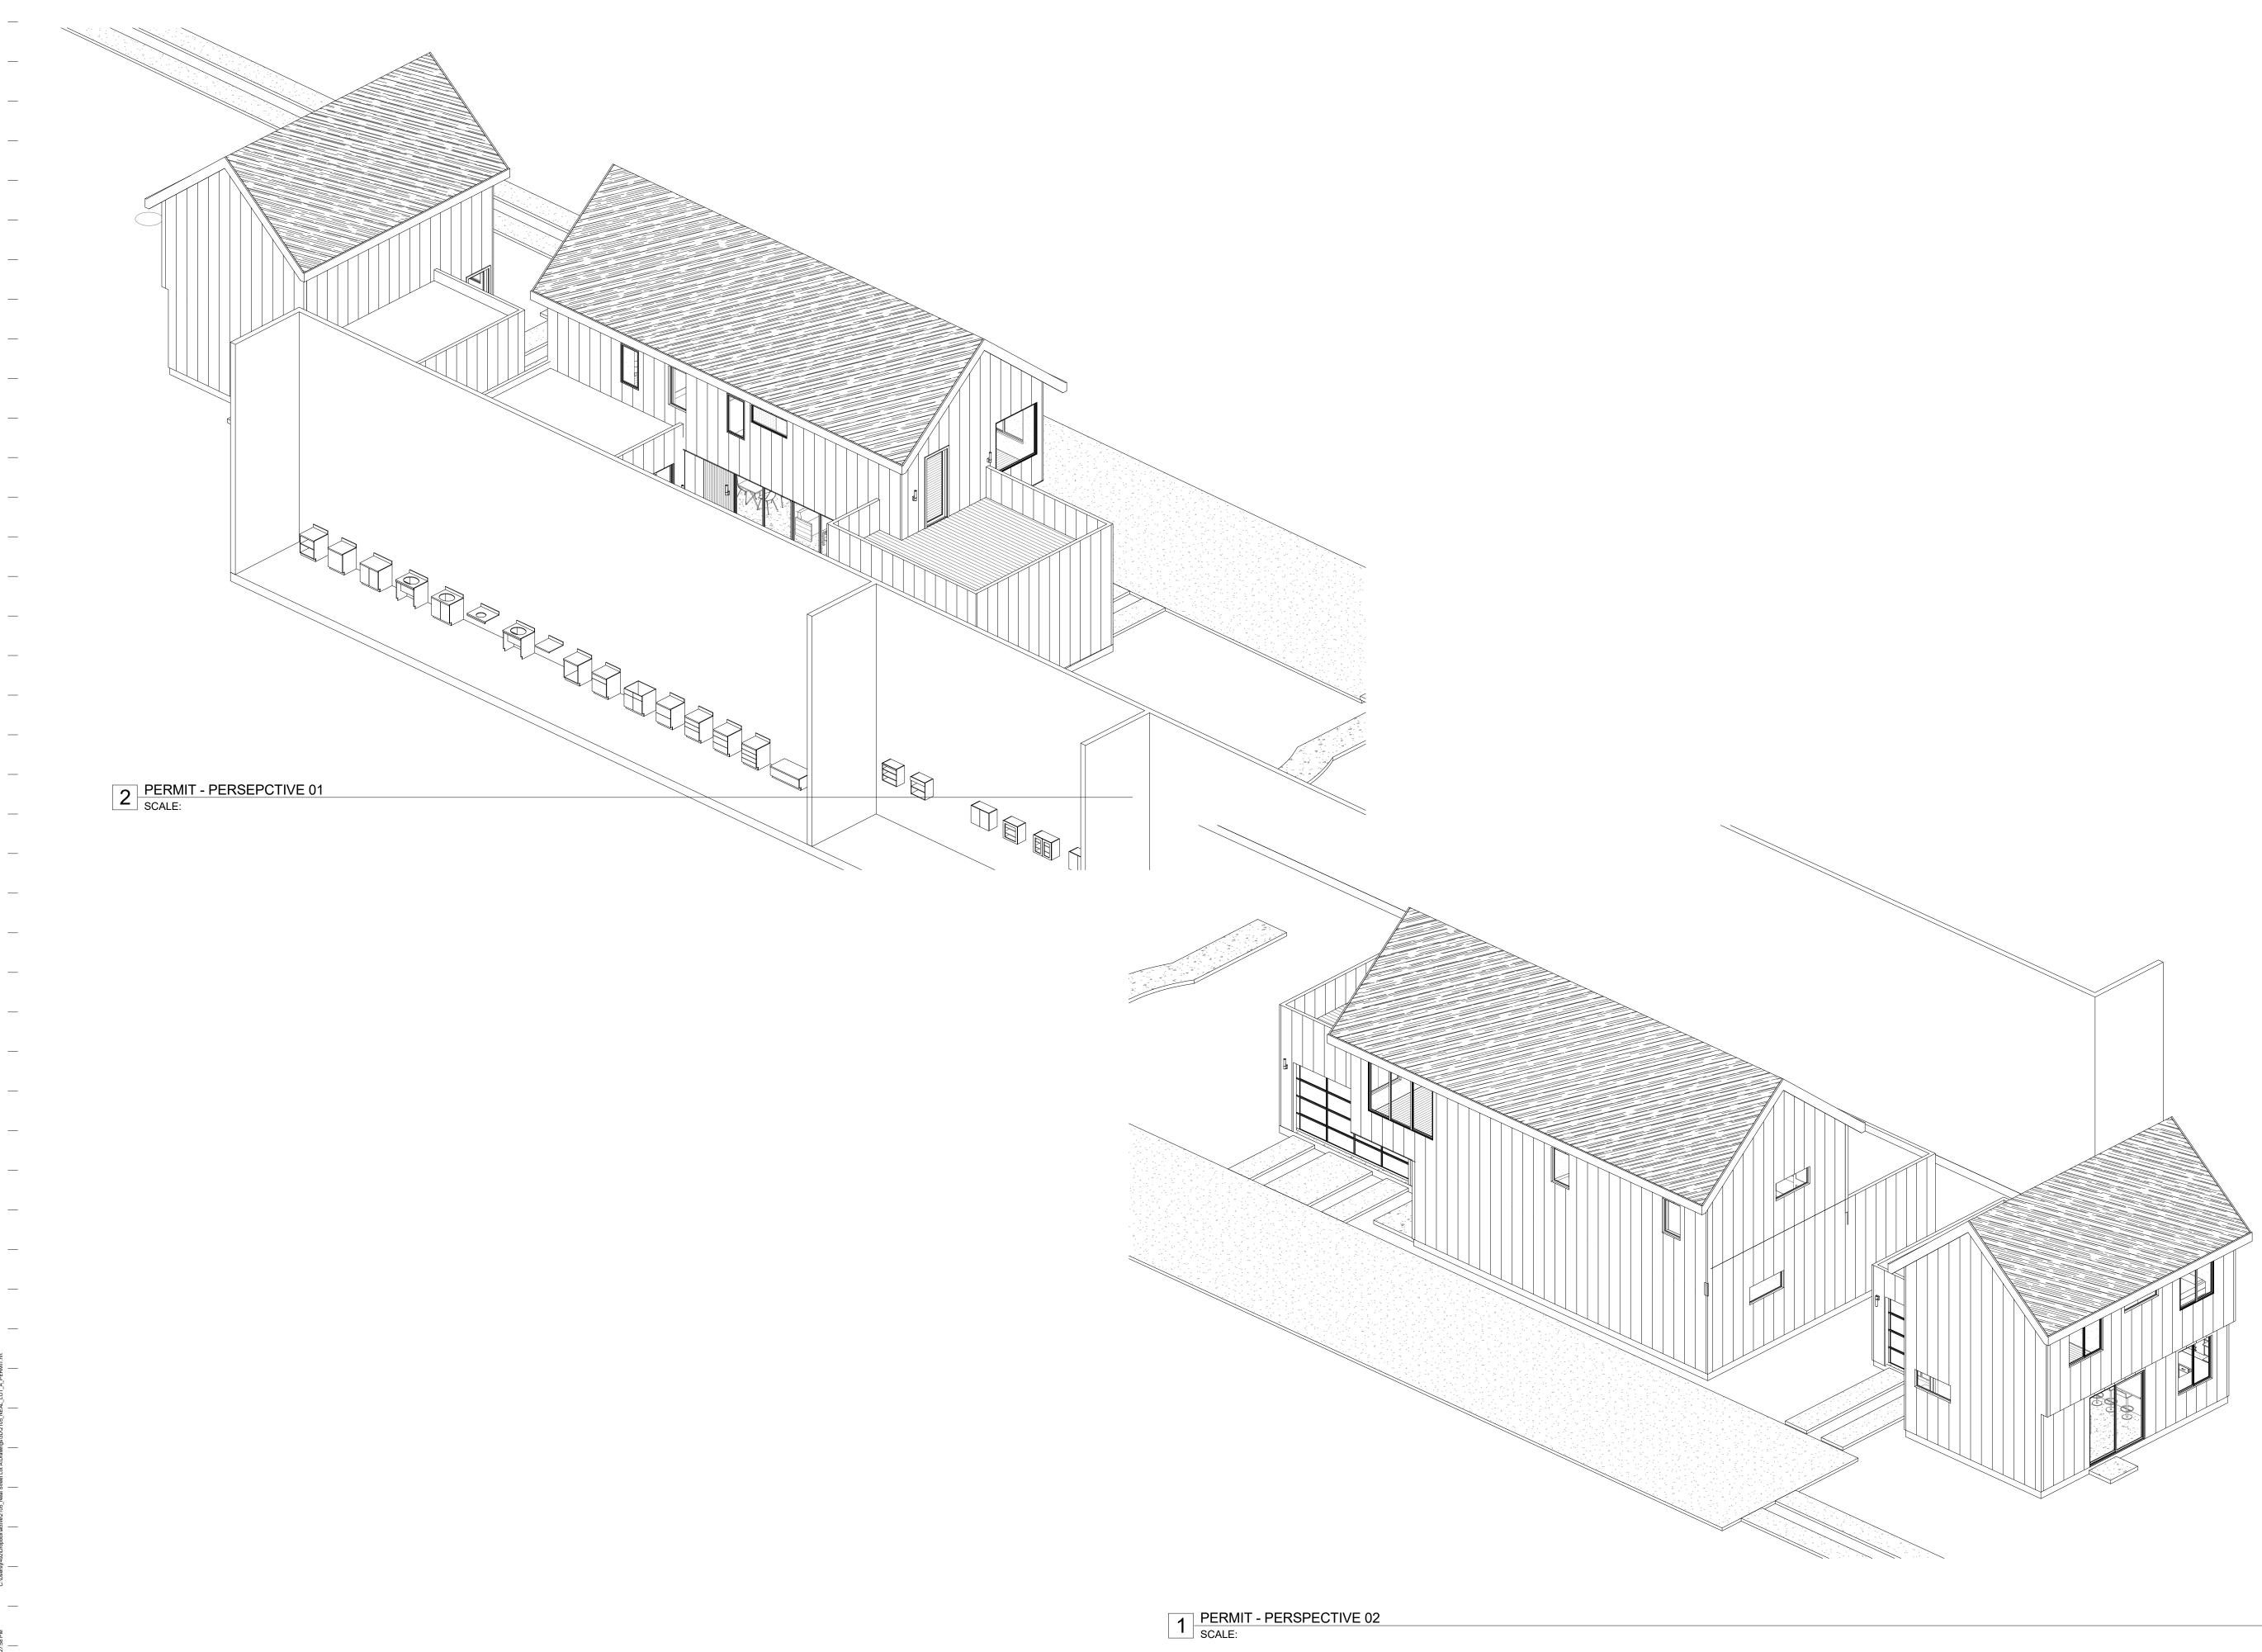


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NEAL LOT A




REVISION NO. DESCRIPTION DATE



3409 NEAL ST AUSTIN , TX 78702 **3D SECTIONS**

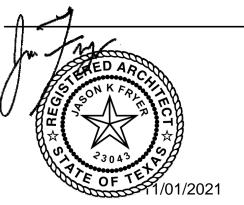A4.6 SHEET SCALE (FOR 24" X 36") SCALE (FOR 11' X 17") HALF INDICATED ISSUE DATE 08/16/21 JOB # 2015



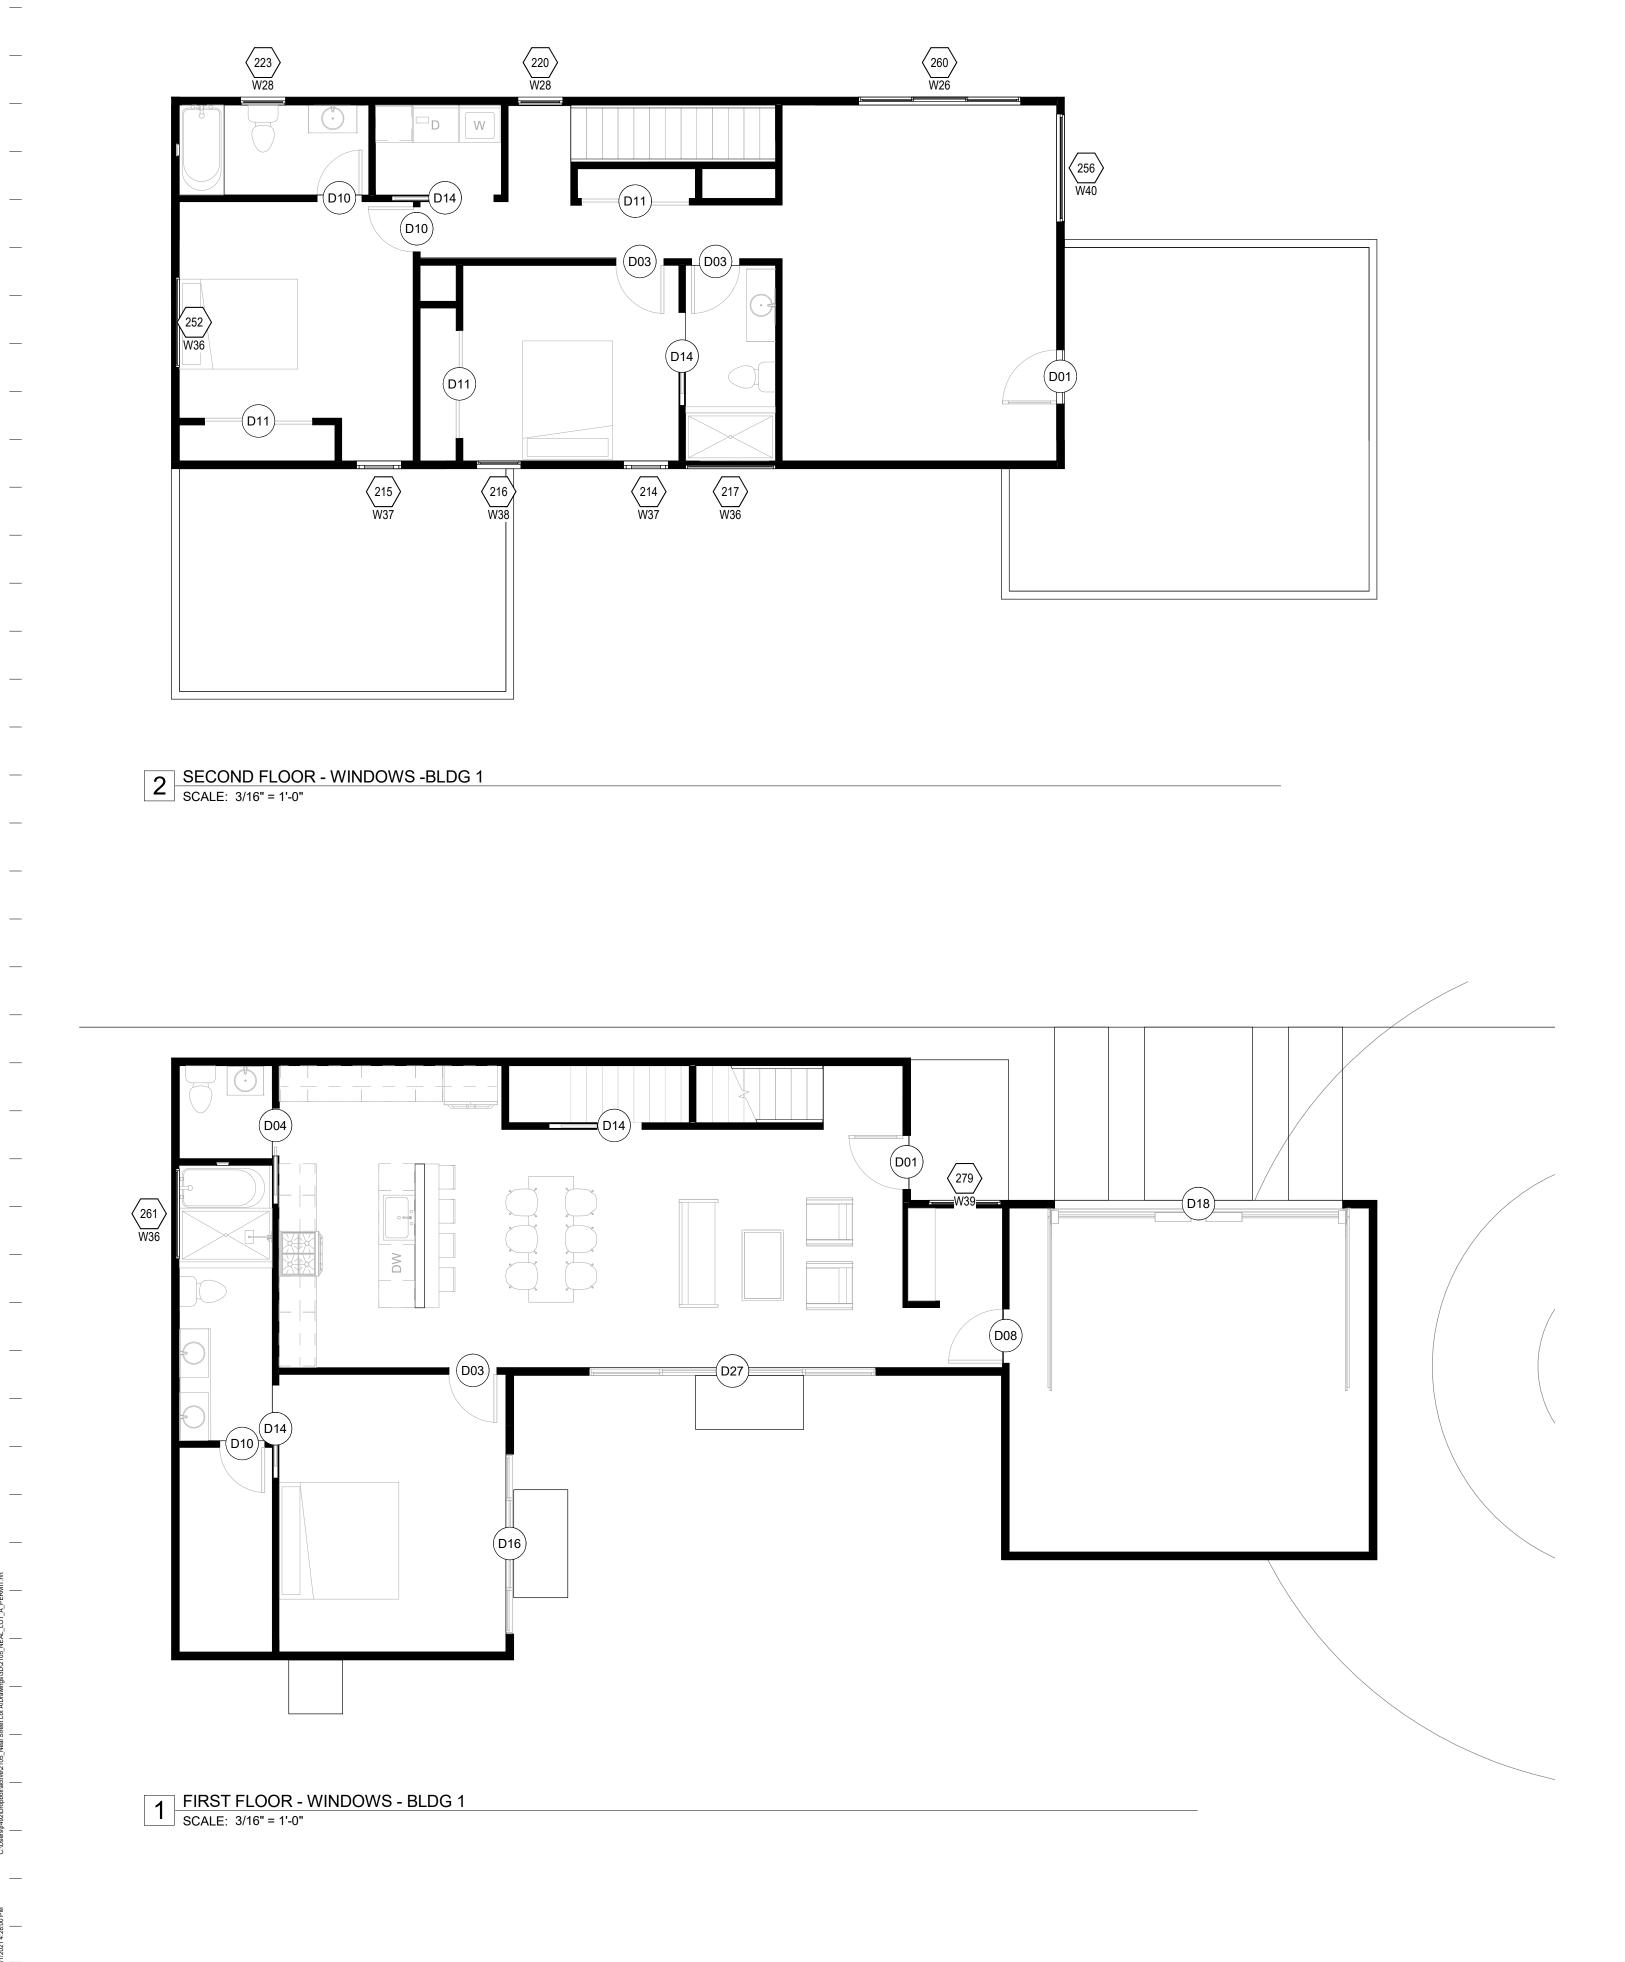

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MARK	#	WIDTH	HEIGHT	SILL HEIGHT	DESCRIPTION			
214	W37	2' - 6"	4' - 6"	3' - 0"	CASEMENT			
215	W37	2' - 6"	4' - 6"	3' - 0"	CASEMENT			
216	W38	2' - 5 1/2"	4' - 6"	3' - 0"	FIXED PICTURE ALUMINUM			
217	W36	5' - 0"	2' - 0"	5' - 6"	FIXED PICTURE ALUMINUM			
220	W28	2' - 6"	4' - 0"	3' - 6"	FIXED PICTURE ALUMINUM			
221	W34	5' - 0"	2' - 0"	5' - 6"	FIXED PICTURE ALUMINUM			
223	W28	2' - 6"	4' - 0"	3' - 6"	FIXED PICTURE ALUMINUM			
224	W30	5' - 0"	5' - 0"	3' - 0"	HORIZONTAL SLIDING WINDOW			
225	W30	5' - 0"	5' - 0"	3' - 0"	HORIZONTAL SLIDING WINDOW			
226	W03	5' - 0"	2' - 0"	6' - 0"	FIXED WINDOW			
252	W36	5' - 0"	2' - 0"	5' - 6"	FIXED PICTURE ALUMINUM			
256	W40	6' - 0"	6' - 0"	2' - 0"	FIXED WINDOW			
260	W26	9' - 0"	6' - 0"	2' - 0"	HORIZONTAL SLIDING WINDOW			
261	W36	5' - 0"	2' - 0"	5' - 6"	FIXED PICTURE ALUMINUM			
273	W30	5' - 0"	5' - 0"	3' - 0"	HORIZONTAL SLIDING WINDOW			
279	W39	4' - 0"	2' - 0"	6' - 0"	FIXED PICTURE ALUMINUM			

#	WIDTH	HEIGHT	DESCRIPTION	
W03	5' - 0"	2' - 0"	FIXED WINDOW	
W26	9' - 0"	6' - 0"	HORIZONTAL SLIDING WINDOW	
W28	2' - 6"	4' - 0"	FIXED PICTURE ALUMINUM	
W30	5' - 0"	5' - 0"	HORIZONTAL SLIDING WINDOW	
W34	5' - 0"	2' - 0"	FIXED PICTURE ALUMINUM	
W36	5' - 0"	2' - 0"	FIXED PICTURE ALUMINUM	
W37	2' - 6"	4' - 6"	CASEMENT	
W38	2' - 5 1/2"	4' - 6"	FIXED PICTURE ALUMINUM	
W39	4' - 0"	2' - 0"	FIXED PICTURE ALUMINUM	
W40	6' - 0"	6' - 0"	FIXED WINDOW	

			JOR LEGEND
			DOOR
	S	IZE	
TYPE MARK	WIDTH	HEIGHT	DESCRIPTION
D01	3' - 0"	8' - 0"	SWING DOOR
D02	9' - 0"	8' - 0"	SECTIONAL GARAGE DOOR
D03	2' - 8"	6' - 8"	SWING DOOR
D04	2' - 8"	6' - 8"	POCKET DOOR
D06	2' - 0"	6' - 8"	SWING DOOR
D08	3' - 0"	6' - 8"	SWING DOOR
D10	2' - 6"	6' - 8"	SWING DOOR
D11	6' - 0"	6' - 8"	SLIDING DOOR
D14	2' - 6"	6' - 8"	POCKET DOOR
D14	3' - 0"	6' - 8"	POCKET DOOR
Grand total: 26			

EXTERIOR DOOR LEGEND							
			DOOR				
	SIZ	ZE					
TYPE MARK	WIDTH	HEIGHT	DESCRIPTION				
	· · · · · ·	,					
D01	3' - 0"	8' - 0"	SWING DOOR				
D2	8' - 0"	8' - 0"	ALUMINUM SLIDING DOOR				
D16	10' - 0"	8' - 0"	4-PANEL ALUMINUM SLIDING DOOR				
D18	16' - 0"	8' - 0"	SECTIONAL GARAGE DOOR				
D27	15' - 10 3/4"	8' - 0"	4-PANEL ALUMINUM SLIDING DOOR				
Grand total: 6	I	I					

WINDOW SCHEDULE

INTERIOR DOOR I EGEND

<u>FORSITE STUDIO</u> ARCHITECTURE / CONSTRUCTION

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REVISION NO. DESCRIPTION DATE




NEAL LOT A

3409 NEAL ST AUSTIN , TX 78702 WINDOWS & DOORS BLDG 1

SHEET	A6.0
SCALE (FOR 24" X 36")	3/16" = 1'-0"
SCALE (FOR 11' X 17")	HALF INDICATED
ISSUE DATE	09/07/2016
JOB #	2015
DRAWN BY	TL



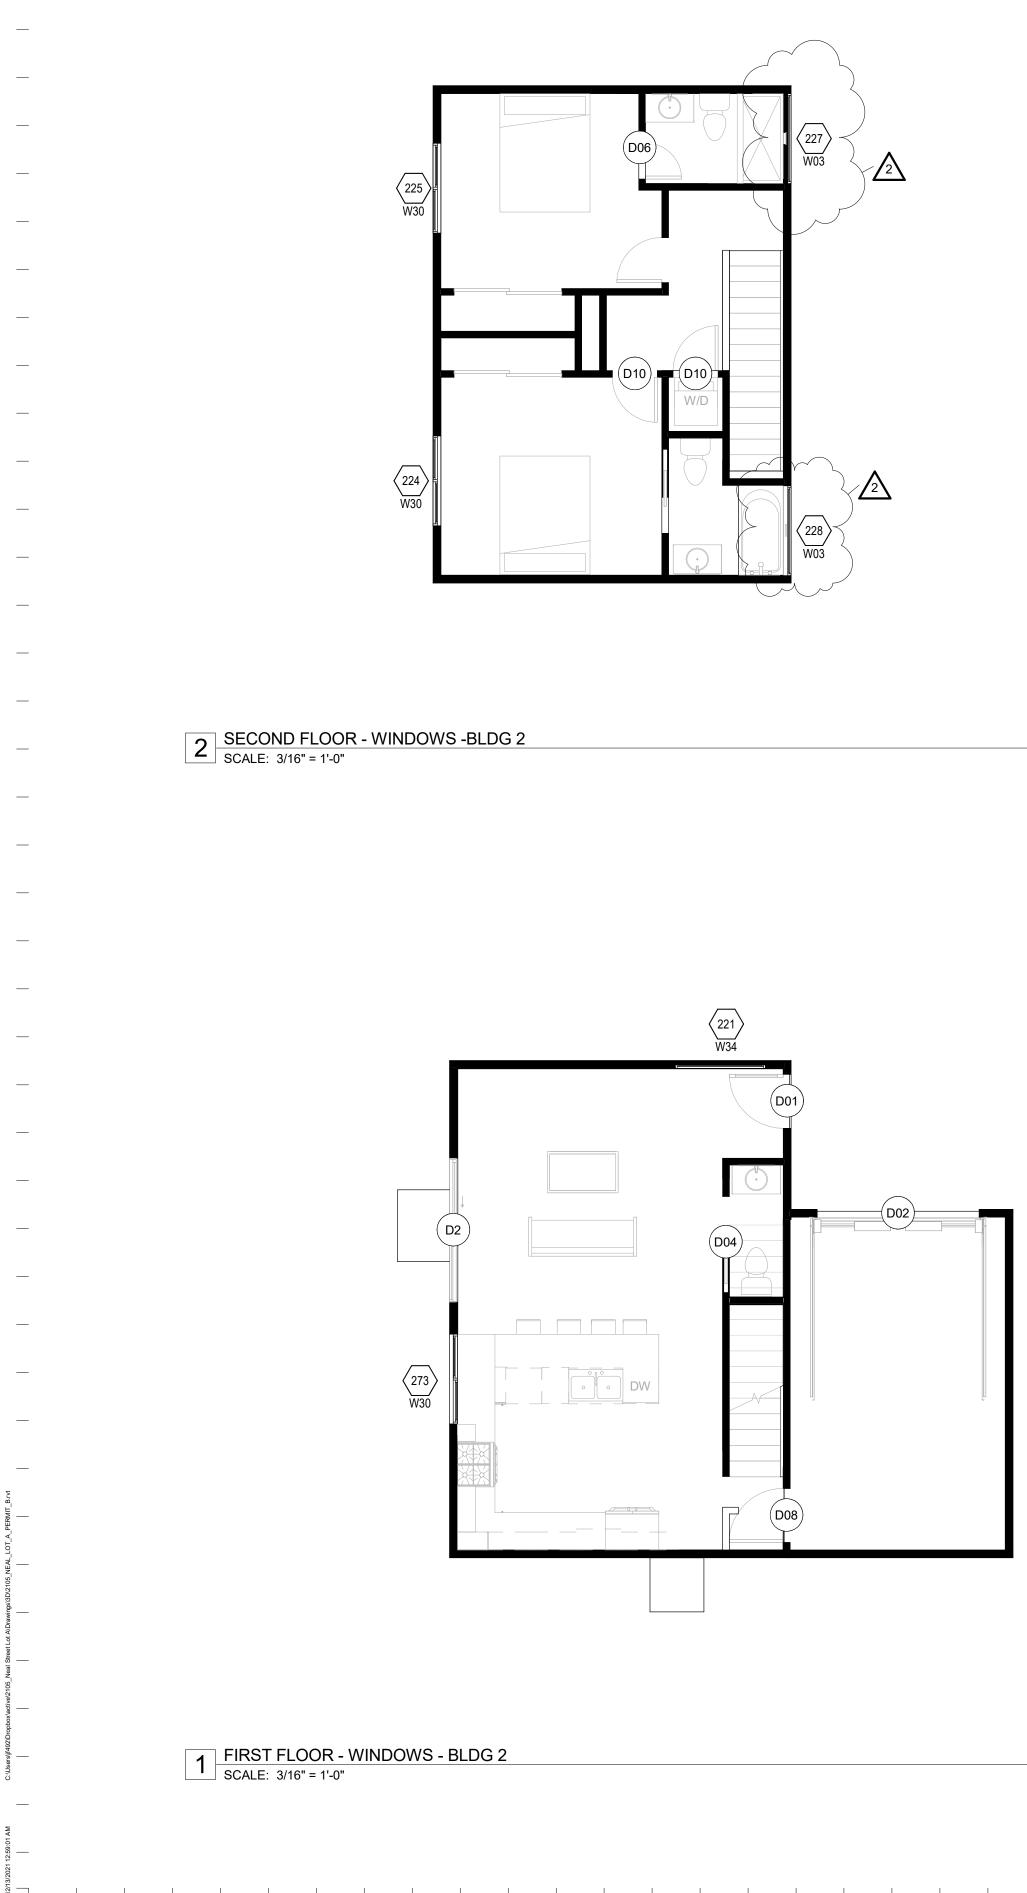

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MARK	
214	W37
215	W37
216	W38
217	W36
220	W28
221	W34
223	W28
224	W30
225	W30
227	W03
228	W03
252	W36
256	W40
260	W26
261	W36
273	W30
279	W39

	#
W03	
W26	
W28	
W30	
W34	
W36	
W37	
W38	
W39	
W40	

	DOOR					
	SIZ	ZE				
TYPE MARK	WIDTH	HEIGHT	DESCRIPTION			
D01	3' - 0"	8' - 0"	SWING DOOR			
D2	8' - 0"	8' - 0"	ALUMINUM SLIDING DOOR			
D16	10' - 0"	8' - 0"	4-PANEL ALUMINUM SLIDING DOOR			
D18	16' - 0"	8' - 0"	SECTIONAL GARAGE DOOR			
D27	15' - 10 3/4"	8' - 0"	4-PANEL ALUMINUM SLIDING DOOR			
Grand total: 6	I I					

TYPE
D01
D02
D03
D04
D06
D08
D10
D11
D13
D14
D14
Grand to

WINDOW SCHEDULE

#	WIDTH	HEIGHT	SILL HEIGHT	DESCRIPTION
	2' - 6"	4' - 6"	3' - 0"	CASEMENT
	2' - 6"	4' - 6"	3' - 0"	CASEMENT
	2' - 5 1/2"	4' - 6"	3' - 0"	FIXED PICTURE ALUMINUM
	5' - 0"	2' - 0"	5' - 6"	FIXED PICTURE ALUMINUM
	2' - 6"	4' - 0"	3' - 6"	FIXED PICTURE ALUMINUM
	5' - 0"	2' - 0"	5' - 6"	FIXED PICTURE ALUMINUM
	2' - 6"	4' - 0"	3' - 6"	FIXED PICTURE ALUMINUM
	5' - 0"	5' - 0"	3' - 0"	HORIZONTAL SLIDING WINDOW
	5' - 0"	5' - 0"	3' - 0"	HORIZONTAL SLIDING WINDOW
	5' - 0"	2' - 0"	6' - 0"	FIXED WINDOW
	5' - 0"	2' - 0"	3' - 0"	FIXED WINDOW
	5' - 0"	2' - 0"	5' - 6"	FIXED PICTURE ALUMINUM
	6' - 0"	6' - 0"	2' - 0"	FIXED WINDOW
	9' - 0"	6' - 0"	2' - 0"	HORIZONTAL SLIDING WINDOW
	5' - 0"	2' - 0"	5' - 6"	FIXED PICTURE ALUMINUM
	5' - 0"	5' - 0"	3' - 0"	HORIZONTAL SLIDING WINDOW
	4' - 0"	2' - 0"	6' - 0"	FIXED PICTURE ALUMINUM

WINDOW LEGEND						
#	WIDTH	HEIGHT	DESCRIPTION			
}	5' - 0"	2' - 0"	FIXED WINDOW			
6	9' - 0"	6' - 0"	HORIZONTAL SLIDING WINDOW			
}	2' - 6"	4' - 0"	FIXED PICTURE ALUMINUM			
)	5' - 0"	5' - 0"	HORIZONTAL SLIDING WINDOW			
ŀ	5' - 0"	2' - 0"	FIXED PICTURE ALUMINUM			
6	5' - 0"	2' - 0"	FIXED PICTURE ALUMINUM			
,	2' - 6"	4' - 6"	CASEMENT			
}	2' - 5 1/2"	4' - 6"	FIXED PICTURE ALUMINUM			
)	4' - 0"	2' - 0"	FIXED PICTURE ALUMINUM			
)	6' - 0"	6' - 0"	FIXED WINDOW			



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EXTERIOR DOOR LEGEND

INTERIOR DOOR LEGEND					
			DOOR		
-	S	IZE			
PE MARK	WIDTH	HEIGHT	DESCRIPTION		
		· · · · · · · · · · · · · · · · · · ·			
	3' - 0"	8' - 0"	SWING DOOR		
	9' - 0"	8' - 0"	SECTIONAL GARAGE DOOR		
	2' - 8"	6' - 8"	SWING DOOR		
	2' - 8"	6' - 8"	POCKET DOOR		
	2' - 0"	6' - 8"	SWING DOOR		
	3' - 0"	6' - 8"	SWING DOOR		
	2' - 6"	6' - 8"	SWING DOOR		
	6' - 0"	6' - 8"	SLIDING DOOR		
	2' - 0"	6' - 8"	POCKET DOOR		
	2' - 6"	6' - 8"	POCKET DOOR		
	3' - 0"	6' - 8"	POCKET DOOR		
d total: 26					
-					

REVISION NO. DESCRIPTION DATE 12/12/21 ASI 01



NEAL LOT A

3409 NEAL ST AUSTIN , TX 78702 WINDOWS & DOORS BLDG 2

SHEET	A6.1
SCALE (FOR 24" X 36")	3/16" = 1'-0"
SCALE (FOR 11' X 17")	HALF INDICATED
ISSUE DATE	06/22/21
JOB #	2015
DRAWN BY	TL





2 SECOND FLOOR - FINISH PLAN SCALE: 3/16" = 1'-0"

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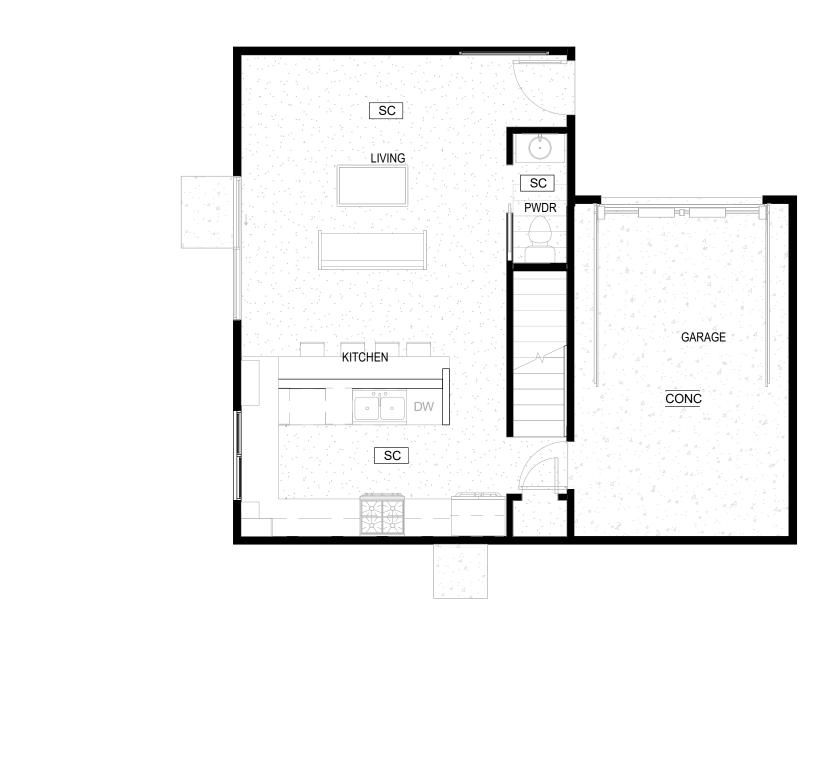
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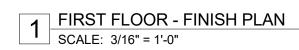
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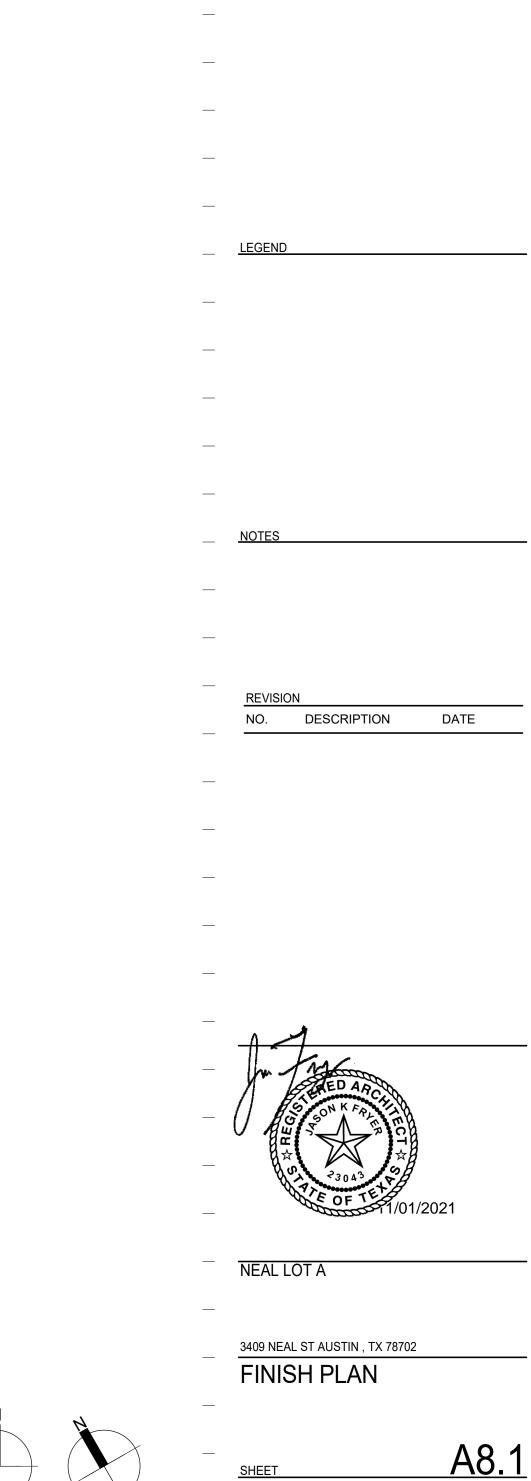
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	0
	<u>SC</u> PRIMA
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FLOOR FINISH LEGEND					
MARK DESCRIPTION					
SC	SEALED CONCRETE				
DK	WOOD DECK				
WD1 WOOD FLOOR - FINISH TO BE DETERMINED					




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SHEET	<u> </u>
SCALE (FOR 24" X 36")	3/16" = 1'-0"
SCALE (FOR 11' X 17")	HALF INDICATED
ISSUE DATE	10/24/21
JOB #	2015
DRAWN BY	TL





 BLDG 1 - PRIMARY BATH - SHOWER 01
 BLDG 1 - PRIMARY BATH - SHOWER 02

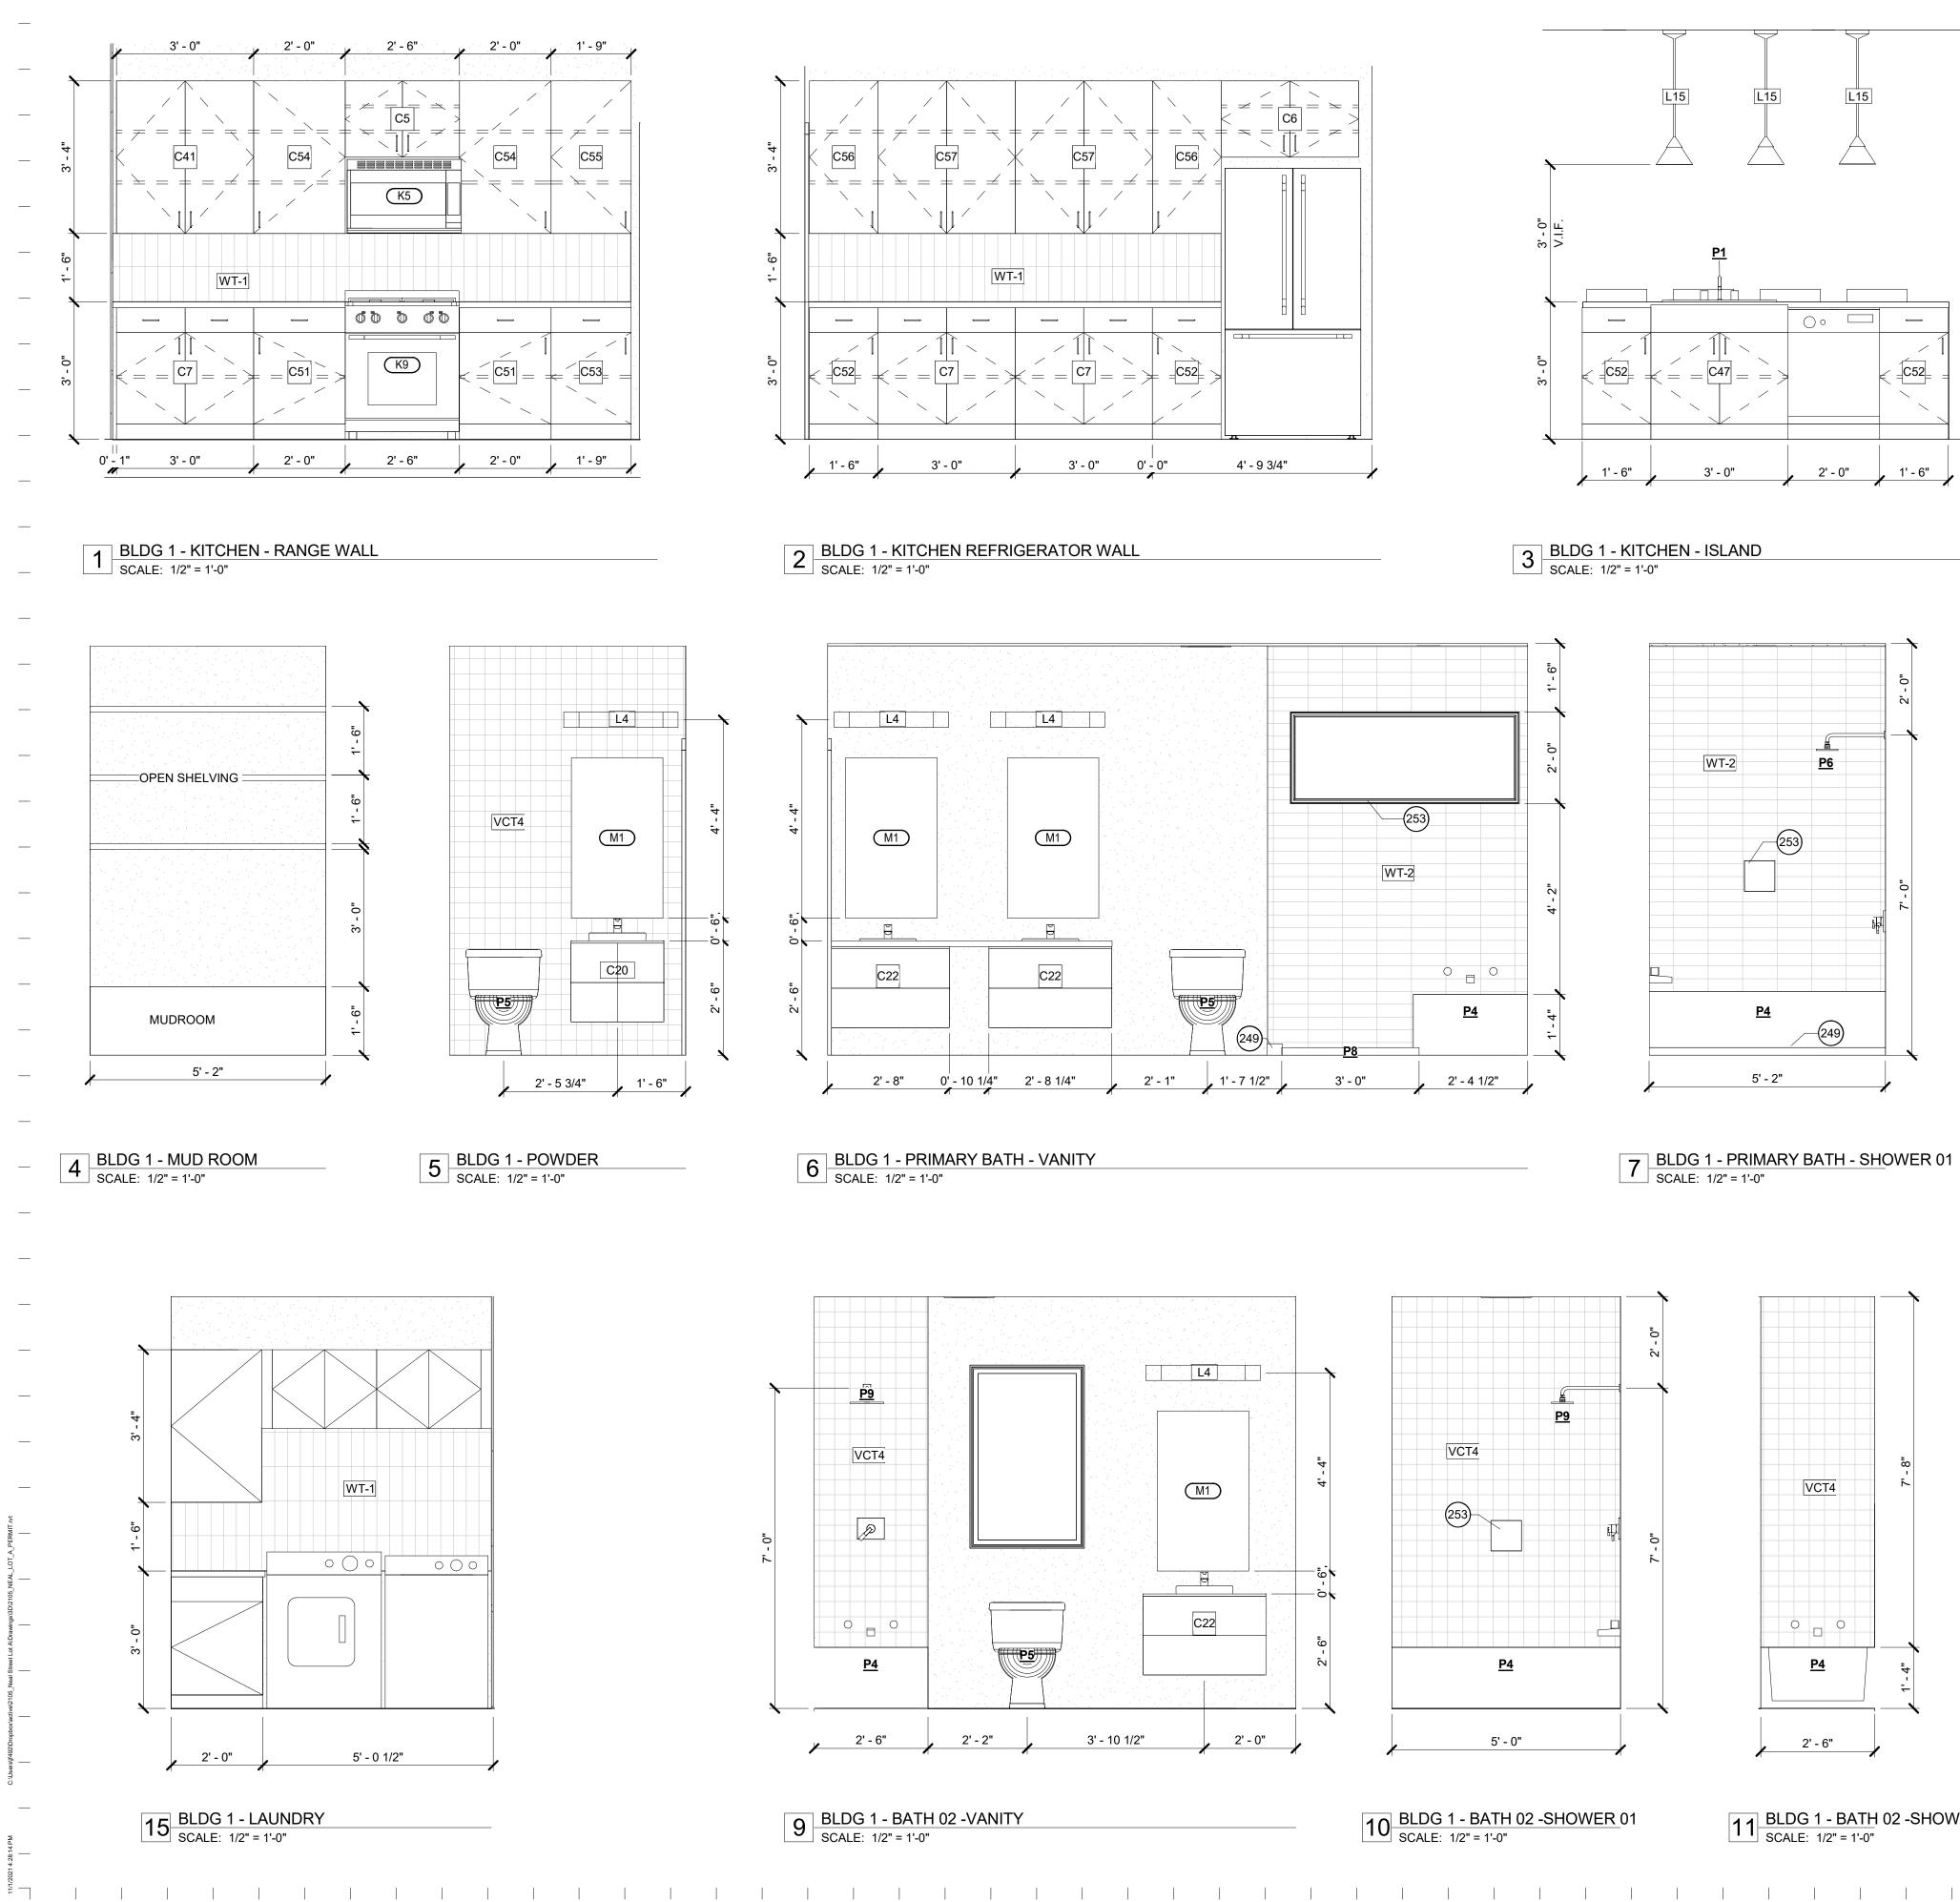 SCALE: 1/2" = 1'-0"
 SCALE: 1/2" = 1'-0"

11 BLDG 1 - BATH 02 -SHOWER 02 SCALE: 1/2" = 1'-0"

	KEYNOTE LEGEND
249	SHOWER CURB - DOUBLE 2X4 TO BE INSTALLED AT FRAMING
253	AT ALL SHOWER WINDOWS CUT AND INSTALL TILE AT THE SILL AND SURROUND

SHOWER INSTALLATION

- . SCHLUTER TRIM TO BE INSTALLED AT TILE/SHEETROCK TRANSITIONS
- REDGARD TO BE USED ON ALL HARDIBACKER JOINTS
- 3. AT ALL SHOWER WINDOWS CUT AND INSTALL TILE AT THE SILL AND SURROUND
- SHOWERS TO HAVE DOUBLE 2X4 CURB INSTALLED AT FRAMING

5. ALL SHOWERS AND BATHS TO HAVE A SHOWER NICHE ROUGHED IN AT FRAMING - SIZE TO BE DETERMINED BASED ON SELECTED TILE

CASEWORK LEGEND				
TYPE MARK	HEIGHT	WIDTH	DEPTH	
C2	3' - 0"	2' - 6"	2' - 0"	
C5	1' - 8"	2' - 6"	1' - 2"	
C6	1' - 8"	3' - 0"	1' - 2"	
C7	3' - 0"	3' - 0"	2' - 0"	
C15	3' - 4"	2' - 6"	1' - 0"	
C22	1' - 8"	2' - 8"	1' - 7"	
C30	1' - 8"	4' - 0"	1' - 7"	
C41	3' - 4"	3' - 0"	1' - 2"	
C47	3' - 0"	3' - 0"	2' - 0"	
C51	3' - 0"	2' - 0"	2' - 0"	
C52	3' - 0"	1' - 6"	2' - 0"	
C53	3' - 0"	1' - 9"	2' - 0"	
C54	3' - 4"	2' - 0"	1' - 2"	
C55	3' - 4"	1' - 9"	1' - 2"	
C56	3' - 4"	1' - 6"	1' - 2"	
C57	3' - 4"	3' - 0"	1' - 2"	
C70	3' - 0"		1' - 0"	

DESCRIPTION

Preference 24" Microwave Oven in Anthracite Gray

36" REFRIDGERATOR

24" DISHWASHER

30" RANGE/OVEN



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REVISION NO. DESCRIPTION DATE

PLL	PLUMBING FIXTURE LEGEND				
TYPE MAR	(DESCRIPTION		
P1	KITCH	IEN SINK			
P4	BATH	TUB			
P5	TOILE	TOILET			
P6	FULL	FULL SHOWER TRIM			
P8	CUST	CUSTOM SHOWER PAN			
P9	SHOW	/ER HEAD			
BAT	Ή A	CCES	SORIES LEGEND		
MARK	NIDTH	HEIGHT	DESCRIPTION		
M1 2'	0"	2' 6"			

M1	2' - 0"	3' - 6"	MIRROR
M3	2' - 6"	3' - 6"	MIRROR


	WALL TILE				
MARK	AREA	ROOM NAME			
VCT4	284 SF				
WT-1	49 SF				
WT-2	162 SF				



NEAL LOT A

3409 NEAL ST AUSTIN , TX 78702 INTERIOR ELEVATIONS

SHEET	A9.0
SCALE (FOR 24" X 36")	1/2" = 1'-0"
SCALE (FOR 11' X 17")	HALF INDICATED
ISSUE DATE	10/24/21
JOB #	2015
DRAWN BY	TL

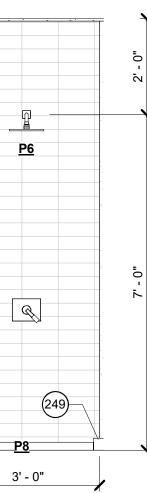

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<u>P6</u>


P8

WT-2


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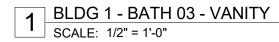
<u>P4</u>

2' - 6"



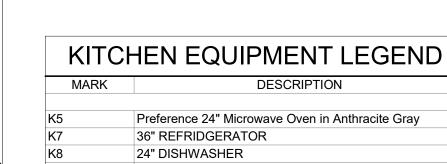



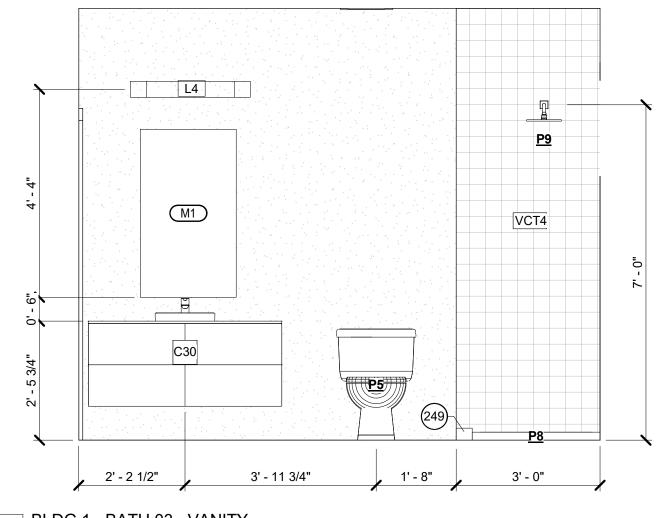

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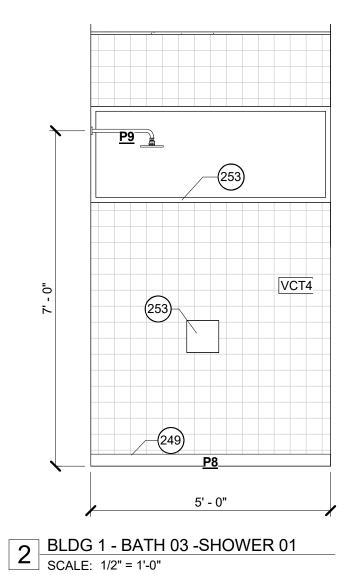
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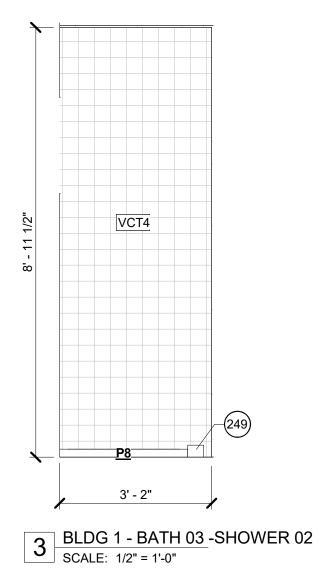
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	KEYNOTE LEGEND
249	SHOWER CURB - DOUBLE 2X4 TO BE INSTALLED AT FRAMING
253	AT ALL SHOWER WINDOWS CUT AND INSTALL TILE AT TH SILL AND SURROUND



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NOTES

LEGEND

SHOWER INSTALLATION

- SCHLUTER TRIM TO BE INSTALLED AT TILE/SHEETROCK TRANSITIONS
- REDGARD TO BE USED ON ALL HARDIBACKER JOINTS
- AT ALL SHOWER WINDOWS CUT AND INSTALL TILE AT THE SILL AND SURROUND
- 4. SHOWERS TO HAVE DOUBLE 2X4 CURB INSTALLED AT FRAMING
- ALL SHOWERS AND BATHS TO HAVE A SHOWER NICHE ROUGHED IN AT FRAMING SIZE TO BE DETERMINED BASED ON SELECTED TILE

CASEWORK LEGEND				
TYPE MARK	HEIGHT	WIDTH	DEPTH	
C2	3' - 0"	2' - 6"	2' - 0"	
C5	1' - 8"	2' - 6"	1' - 2"	
C6	1' - 8"	3' - 0"	1' - 2"	
C7	3' - 0"	3' - 0"	2' - 0"	
C15	3' - 4"	2' - 6"	1' - 0"	
C22	1' - 8"	2' - 8"	1' - 7"	
C30	1' - 8"	4' - 0"	1' - 7"	
C41	3' - 4"	3' - 0"	1' - 2"	
C47	3' - 0"	3' - 0"	2' - 0"	
C51	3' - 0"	2' - 0"	2' - 0"	
C52	3' - 0"	1' - 6"	2' - 0"	
C53	3' - 0"	1' - 9"	2' - 0"	
C54	3' - 4"	2' - 0"	1' - 2"	
C55	3' - 4"	1' - 9"	1' - 2"	
C56	3' - 4"	1' - 6"	1' - 2"	
C57	3' - 4"	3' - 0"	1' - 2"	
C70	3' - 0"		1' - 0"	

BA	TH A	CCES	SORIES LEGEND
MARK	WIDTH	HEIGHT	DESCRIPTION

 M1
 2' - 0"
 3' - 6"
 MIRROR

 M3
 2' - 6"
 3' - 6"
 MIRROR

REVISI	ON	
NO.	DESCRIPTION	DATE


KITCHEN EQUIPMENT LEGEND

DESCRIPTION			
Preference 24" Microwave Oven in Anthracite Gray			
36" REFRIDGERATOR			
24" DISHWASHER			
30" RANGE/OVEN			

PLUMBING FIXTURE LEGEND

TYPE MARK	DESCRIPTION	
P1	KITCHEN SINK	
P4	BATHTUB	
P5	TOILET	
P6	FULL SHOWER TRIM	
P8	CUSTOM SHOWER PAN	
P9	SHOWER HEAD	


WALL TILE			
MARK	AREA	ROOM NAME	
VCT4	284 SF		
WT-1	49 SF		
WT-2	162 SF		

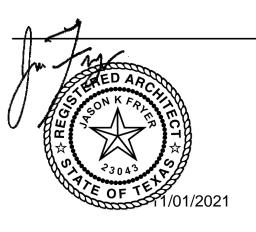

NEAL LOT A

3409 NEAL ST AUSTIN , TX 78702 INTERIOR ELEVATIONS

SHEET	A9.1
SCALE (FOR 24" X 36")	1/2" = 1'-0"
SCALE (FOR 11' X 17")	HALF INDICATED
ISSUE DATE	10/24/21
JOB #	2015
DRAWN BY	Designer

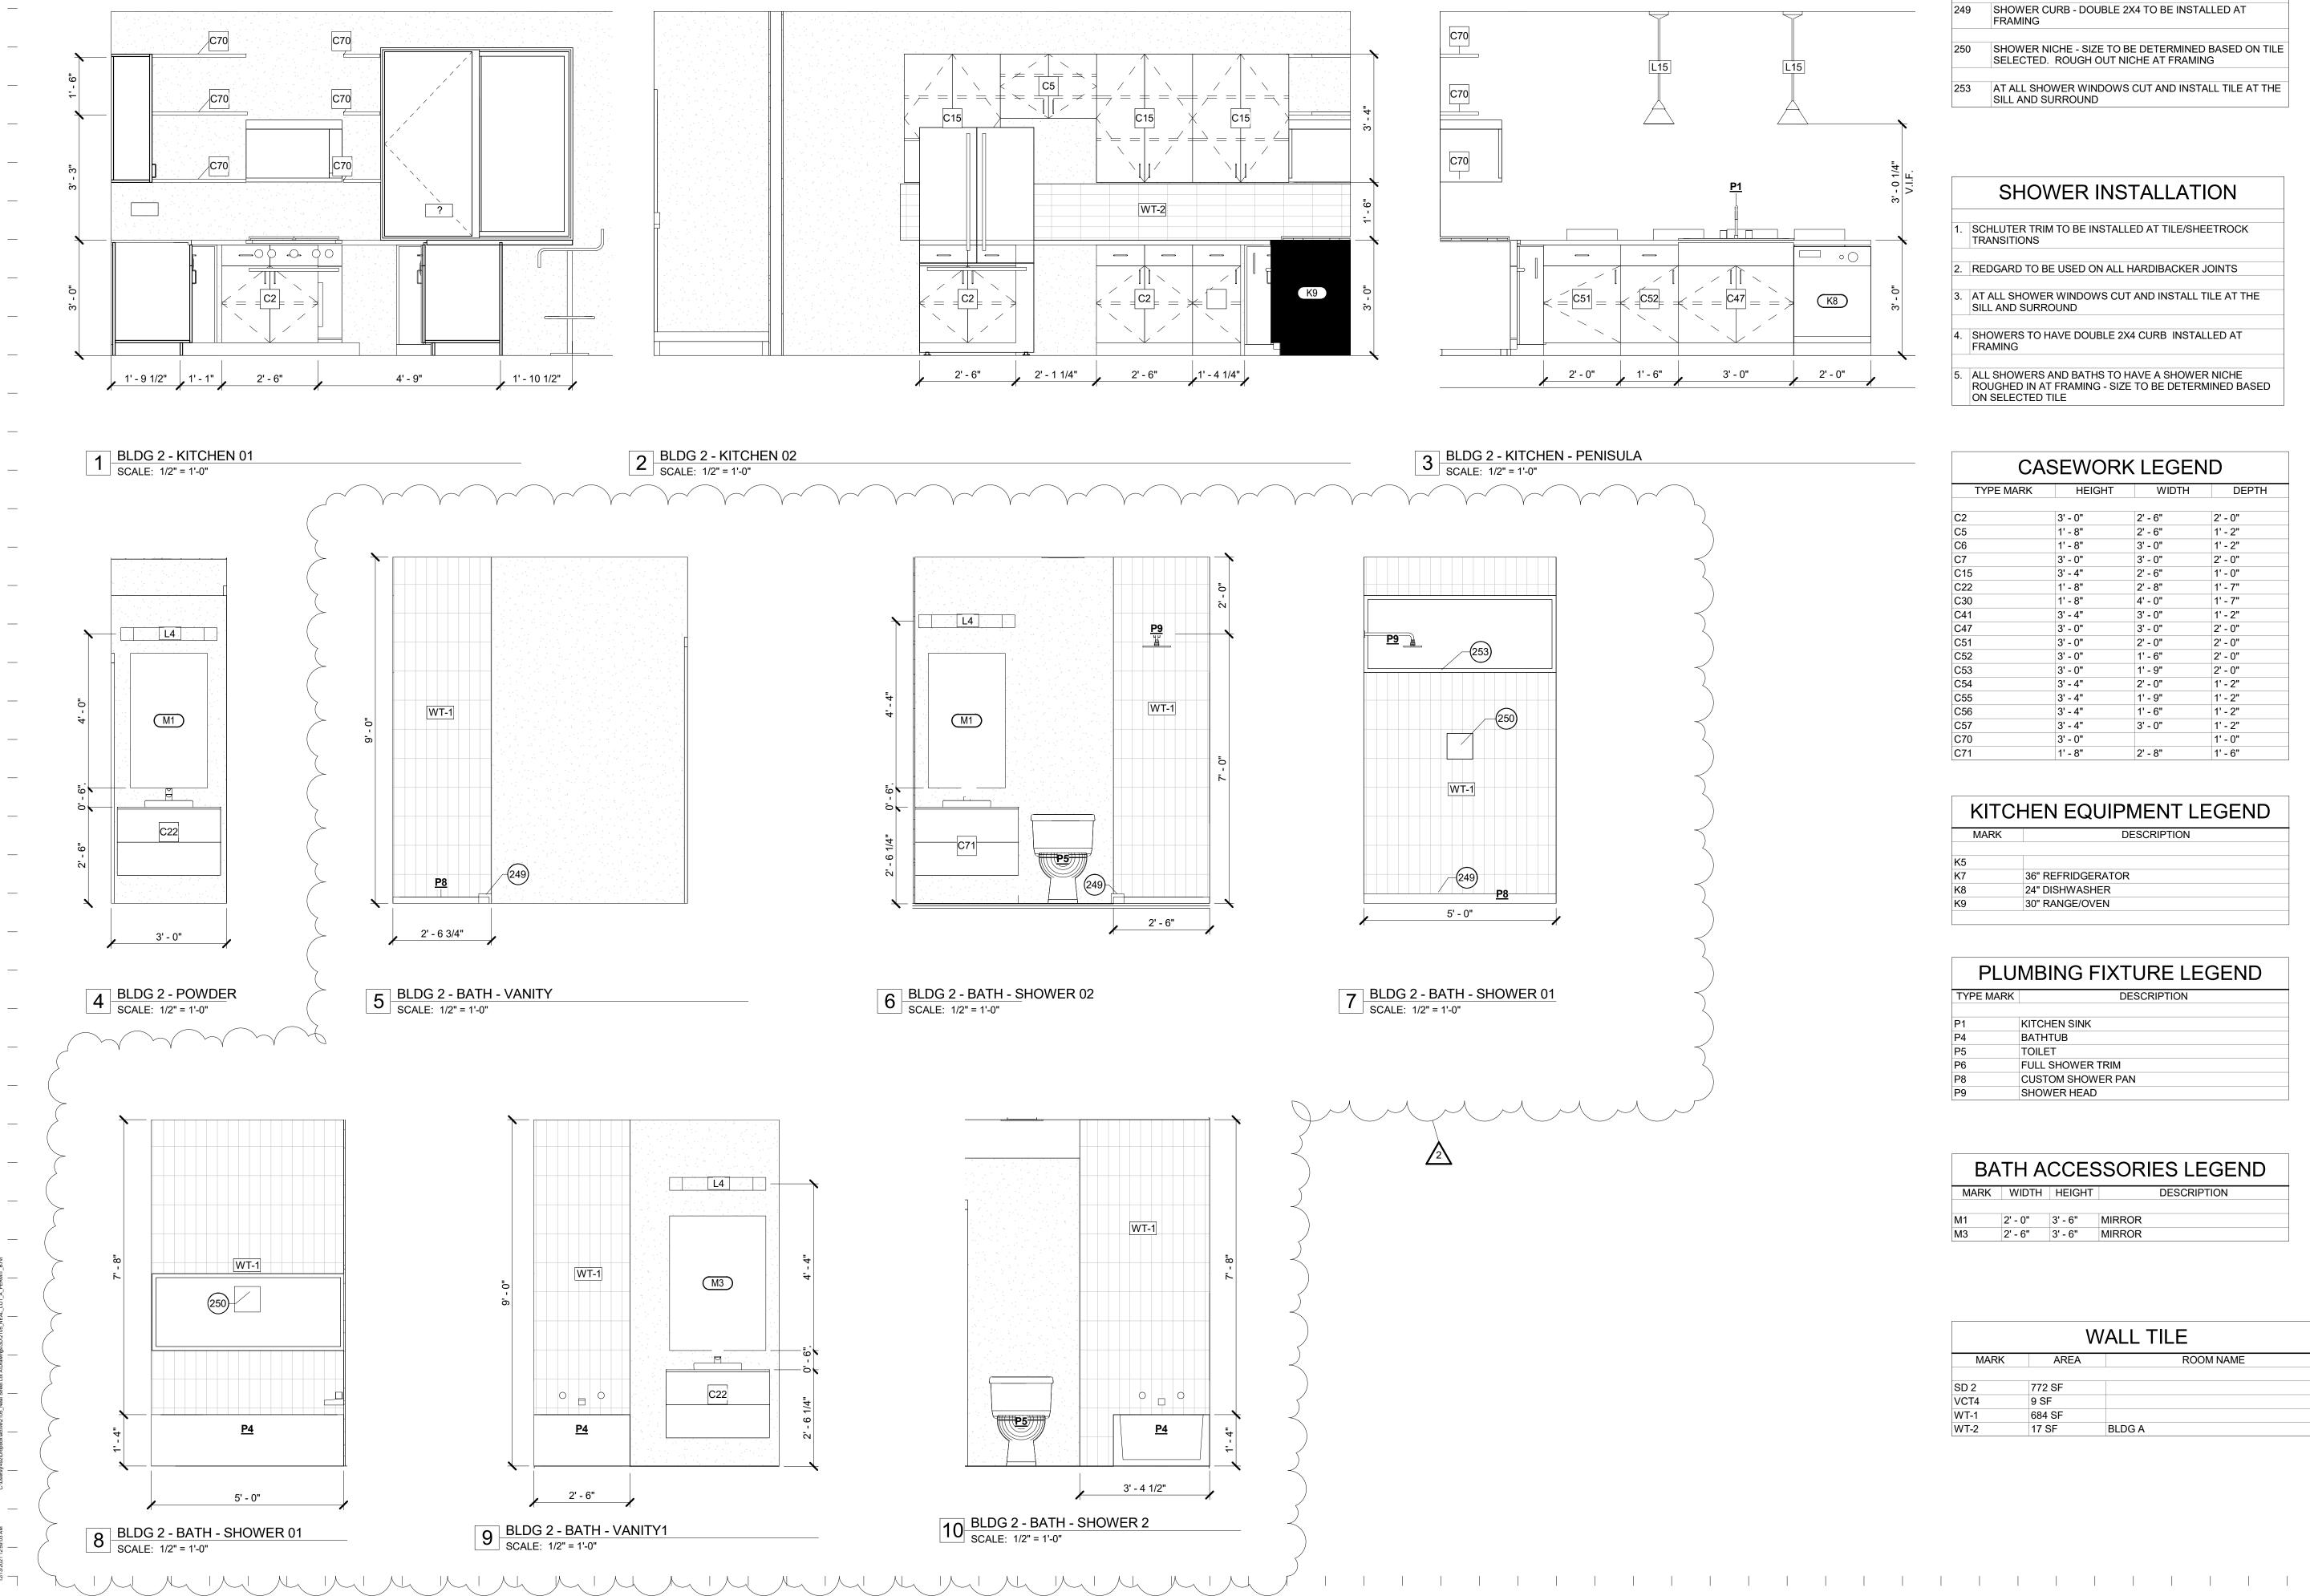



	KEYNOTE LEGEND		
249	SHOWER CURB - DOUBLE 2X4 TO BE INSTALLED AT FRAMING		
250	SHOWER NICHE - SIZE TO BE DETERMINED BASED ON TILE SELECTED. ROUGH OUT NICHE AT FRAMING		
253	AT ALL SHOWER WINDOWS CUT AND INSTALL TILE AT THE SILL AND SURROUND		



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SHOWER INSTALLATION

- SCHLUTER TRIM TO BE INSTALLED AT TILE/SHEETROCK TRANSITIONS
- REDGARD TO BE USED ON ALL HARDIBACKER JOINTS
- 3. AT ALL SHOWER WINDOWS CUT AND INSTALL TILE AT THE SILL AND SURROUND
- SHOWERS TO HAVE DOUBLE 2X4 CURB INSTALLED AT FRAMING
- ALL SHOWERS AND BATHS TO HAVE A SHOWER NICHE ROUGHED IN AT FRAMING SIZE TO BE DETERMINED BASED ON SELECTED TILE


CASEWORK LEGEND			
TYPE MARK	HEIGHT	WIDTH	DEPTH
C2	3' - 0"	2' - 6"	2' - 0"
C5	1' - 8"	2' - 6"	1' - 2"
C6	1' - 8"	3' - 0"	1' - 2"
C7	3' - 0"	3' - 0"	2' - 0"
C15	3' - 4"	2' - 6"	1' - 0"
C22	1' - 8"	2' - 8"	1' - 7"
C30	1' - 8"	4' - 0"	1' - 7"
C41	3' - 4"	3' - 0"	1' - 2"
C47	3' - 0"	3' - 0"	2' - 0"
C51	3' - 0"	2' - 0"	2' - 0"
C52	3' - 0"	1' - 6"	2' - 0"
C53	3' - 0"	1' - 9"	2' - 0"
C54	3' - 4"	2' - 0"	1' - 2"
C55	3' - 4"	1' - 9"	1' - 2"
C56	3' - 4"	1' - 6"	1' - 2"
C57	3' - 4"	3' - 0"	1' - 2"
C70	3' - 0"		1' - 0"
C71	1' - 8"	2' - 8"	1' - 6"

KITCHEN EQUIPMENT LEGEND		
MARK DESCRIPTION		
K5		
K7	36" REFRIDGERATOR	
K8	24" DISHWASHER	
K9	30" RANGE/OVEN	

PLUMBING FIXTURE LEGEND		
TYPE MARK	DESCRIPTION	
P1	KITCHEN SINK	
P4	BATHTUB	
P5	TOILET	
P6	FULL SHOWER TRIM	
P8	CUSTOM SHOWER PAN	
P9	SHOWER HEAD	


MARK	WIDTH	HEIGHT	DESCRIPTION	
M1	2' - 0"	3' - 6"	MIRROR	_
M3	2' - 6"	3' - 6"	MIRROR	

WALL TILE				
MARK	AREA	ROOM NAME		
SD 2	772 SF			
VCT4	9 SF			
WT-1	684 SF			
WT-2 17 SF		BLDG A		

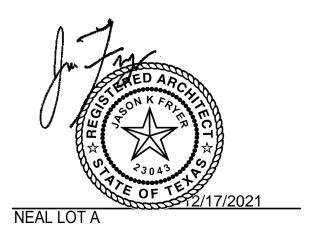

3409 NEAL ST AUSTIN , TX 78702 INTERIOR ELEVATIONS

SHEET	A9.2
SCALE (FOR 24" X 36")	1/2" = 1'-0"
SCALE (FOR 11' X 17")	HALF INDICATED
ISSUE DATE	10/24/21
JOB #	2015
DRAWN BY	TL

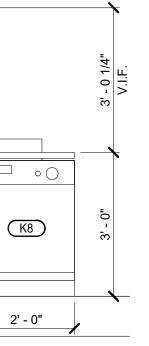

REVISI	ON	
NO.	DESCRIPTION	DATE
2	ASI 01	12/12/21

EX	TERIOR WALL SCH	EDULE
TYPE MARK	DESCRIPTION	AREA
	BOARD AND BATTEN	2,006 SF
	METAL PANEL	3,544 SF
	METAL PANEL	3,550 SF
FDA	VERTICAL WOOD	168 SF

FASCIA SCHEDULE LENGTH

281' - 6"

TYPE FASCIA - 1X12 - WIDE

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SOFFIT MAT	ERIAL TAKEOFF
TYPE	AREA
/OOD SOFFIT	539 SF
	539 SF

FLOOR FINISH MATERIALS					
MARK DESCRIPTION AREA					
		7,720 SF			
	WOOD TRUSS FLOOR	1,478 SF			
CONC	UNFINISHED CONCRETE	419 SF			
DK	WOOD DECK	345 SF			
FLAT	CONCRETE FLATWORK	110 SF			
SC	SEALED CONCRETE	1,305 SF			
T-2	TILE	27 SF			
T-4	TILE	126 SF			
T-5	TILE	51 SF			
WD1	WOOD FLOOR - FINISH TO BE DETERMINED	1,172 SF			

			CASE	EWORK S	SCHEDULE	
TYPE MARK	MANUFACTURER	HEIGHT	WIDTH	DEPTH	FINISH	COMMENTS
C2		3' - 0"	2' - 6"	2' - 0"	VENEER	
C5	IKEA	1' - 8"	2' - 6"	1' - 2"	VENEER	
C6	IKEA	1' - 8"	3' - 0"	1' - 2"	VENEER	
C7	IKEA	3' - 0"	3' - 0"	2' - 0"	VENEER	
C15	IKEA	3' - 4"	2' - 6"	1' - 0"	VENEER	
C22		1' - 8"	2' - 8"	1' - 7"		
C30		1' - 8"	4' - 0"	1' - 7"		
C41		3' - 4"	3' - 0"	1' - 2"	VENEER	
C47		3' - 0"	3' - 0"	2' - 0"	VENEER	
C51		3' - 0"	2' - 0"	2' - 0"	VENEER	
C52		3' - 0"	1' - 6"	2' - 0"	VENEER	
C53		3' - 0"	1' - 9"	2' - 0"	VENEER	
C54		3' - 4"	2' - 0"	1' - 2"	VENEER	
C55		3' - 4"	1' - 9"	1' - 2"	VENEER	
C56		3' - 4"	1' - 6"	1' - 2"	VENEER	
C57	IKEA	3' - 4"	3' - 0"	1' - 2"	VENEER	
C70		3' - 0"		1' - 0"		

			EXTE	RIOR DOOR SCHED	ULE	
				DOOR		
		SI	SIZE			
TYPE MARK	COUNT	WIDTH	HEIGHT	DESCRIPTION	MANUFACTURER	FINISH
D01	2	3' - 0"	8' - 0"	SWING DOOR		
D2	1	8' - 0"	8' - 0"	ALUMINUM SLIDING DOOR	© 2012 Milgard Manufacturing, Inc.	
D16	1	10' - 0"	8' - 0"	4-PANEL ALUMINUM SLIDING DOOR	MI Windows and Doors	
D18	1	16' - 0"	8' - 0"	SECTIONAL GARAGE DOOR	Clopay Building Products Company	
D27	1	15' - 10 3/4"	8' - 0"	4-PANEL ALUMINUM SLIDING DOOR	MI Windows and Doors	
Grand total: 6	1			L.	1	1

			INTEF	RIOR DOOR SCHEE	DULE	
				DOOR		
		S	IZE			
TYPE MARK	COUNT	WIDTH	HEIGHT	DESCRIPTION	MANUFACTURER	FINISH
	1	1	·			
D01	1	3' - 0"	8' - 0"	SWING DOOR		
D02	1	9' - 0"	8' - 0"	SECTIONAL GARAGE DOOR	Clopay Building Products Company	
D03	4	2' - 8"	6' - 8"	SWING DOOR		
D04	2	2' - 8"	6' - 8"	POCKET DOOR		
D06	1	2' - 0"	6' - 8"	SWING DOOR		
D08	1	3' - 0"	6' - 8"	SWING DOOR		
D10	8	2' - 6"	6' - 8"	SWING DOOR		
D11	3	6' - 0"	6' - 8"	SLIDING DOOR		
D14	4	2' - 6"	6' - 8"	POCKET DOOR		
D14	1	3' - 0"	6' - 8"	POCKET DOOR		
Grand total: 26	·	·	·			· · · · · · · · · · · · · · · · · · ·



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KITCHEN EQUIPMENT

MARK	DESCRIPTION
K5	Preference 24" Microwave Oven in Anthracite Gray
K7	36" REFRIDGERATOR
K8	24" DISHWASHER
K9	30" RANGE/OVEN

PLUMBING FIXTURE SCHEDULE

TYPE MARK	COUNT	DESCRIPTION	COMMENTS
P1	3	KITCHEN SINK	
P4	3	BATHTUB	
P5	5	TOILET	
P6	1	FULL SHOWER TRIM	
P8	2	CUSTOM SHOWER PAN	
P9	3	SHOWER HEAD	

BATHROOM ACCESSORIES QTY DESCRIPTION MARK

	LIGH	FING FIXTURE SCH	EDULE	
TYPE MARK	COUNT	DESCRIPTION	LAMP	COMMENTS
F2	8	CEILING FAN WITH LIGHT		
L1	47	6" RECESSED CAN LIGHT		
L3	2	6" RECESSED CAN LIGHT		
L4	7	VANITY LIGHT	LED	
L5	5	CLOSET LIGHT		
L10	11	OUTDOOR SCONCE	13wQPL	
L15	6	PENDANT LIGHT		
L20	3	48" FLUORESCENT LIGHT	(2) T12	
VL1	3	CEILING VENTILATION FAN		
VL2	3	BROAN 744 BATH FAN W/ LIGHT		

GENERAL SCHEDULE NOTES

1. ALL SCHEDULES ARE PROVIDED FOR REFERENCE ONLY. CONTRACTOR TO VERIFY ALL QUANITITES INDICATED ON THIS SHEET WITH THE ARCHITECTURAL DRAWINGS.



1205 east cesar chavez — austin, tx 78702 p 512.436.1901 www.forsitestudio.com

CONSULTANTS

Comments

REVISION NO. DESCRIPTION


DATE


NEAL LOT A

3409 NEAL ST AUSTIN , TX 78702 SCHEDULES

SHEET	A10.1
SCALE (FOR 24" X 36")	
SCALE (FOR 11' X 17")	HALF INDICATED

SCALE (FOR 11' X 17")	HALF INDICATED
ISSUE DATE	10/24/21
JOB #	2015
DRAWN BY	TL

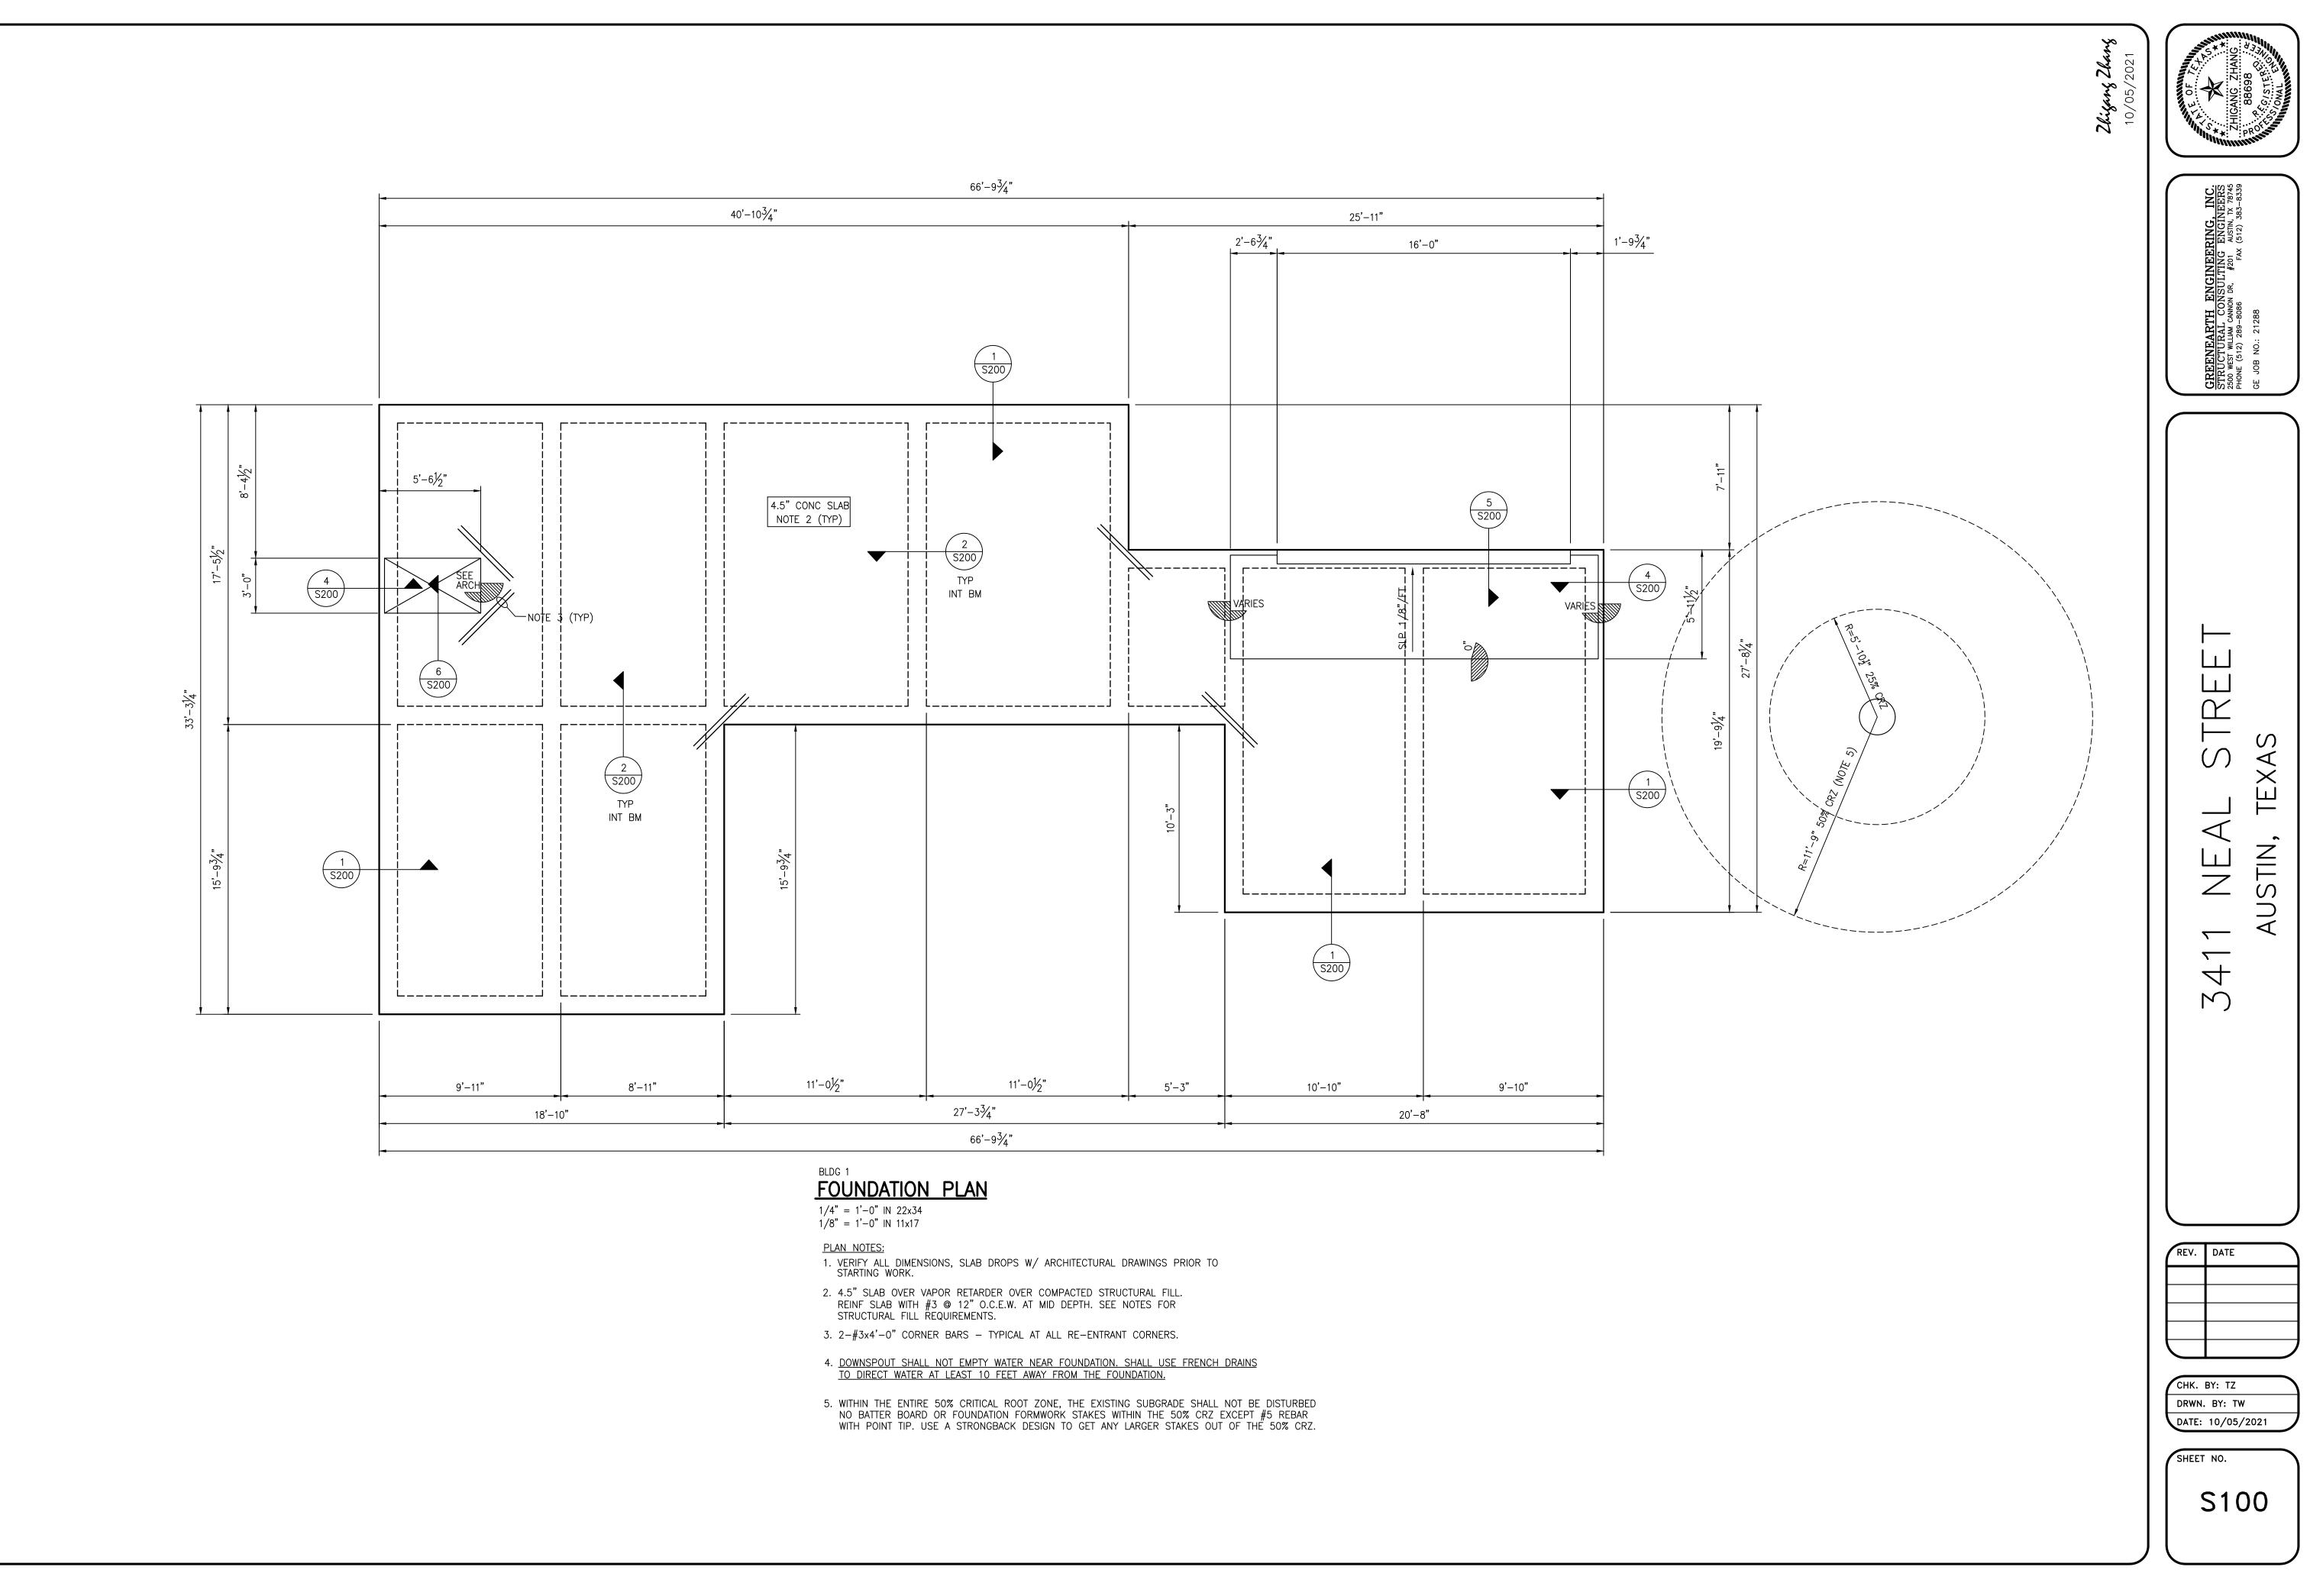


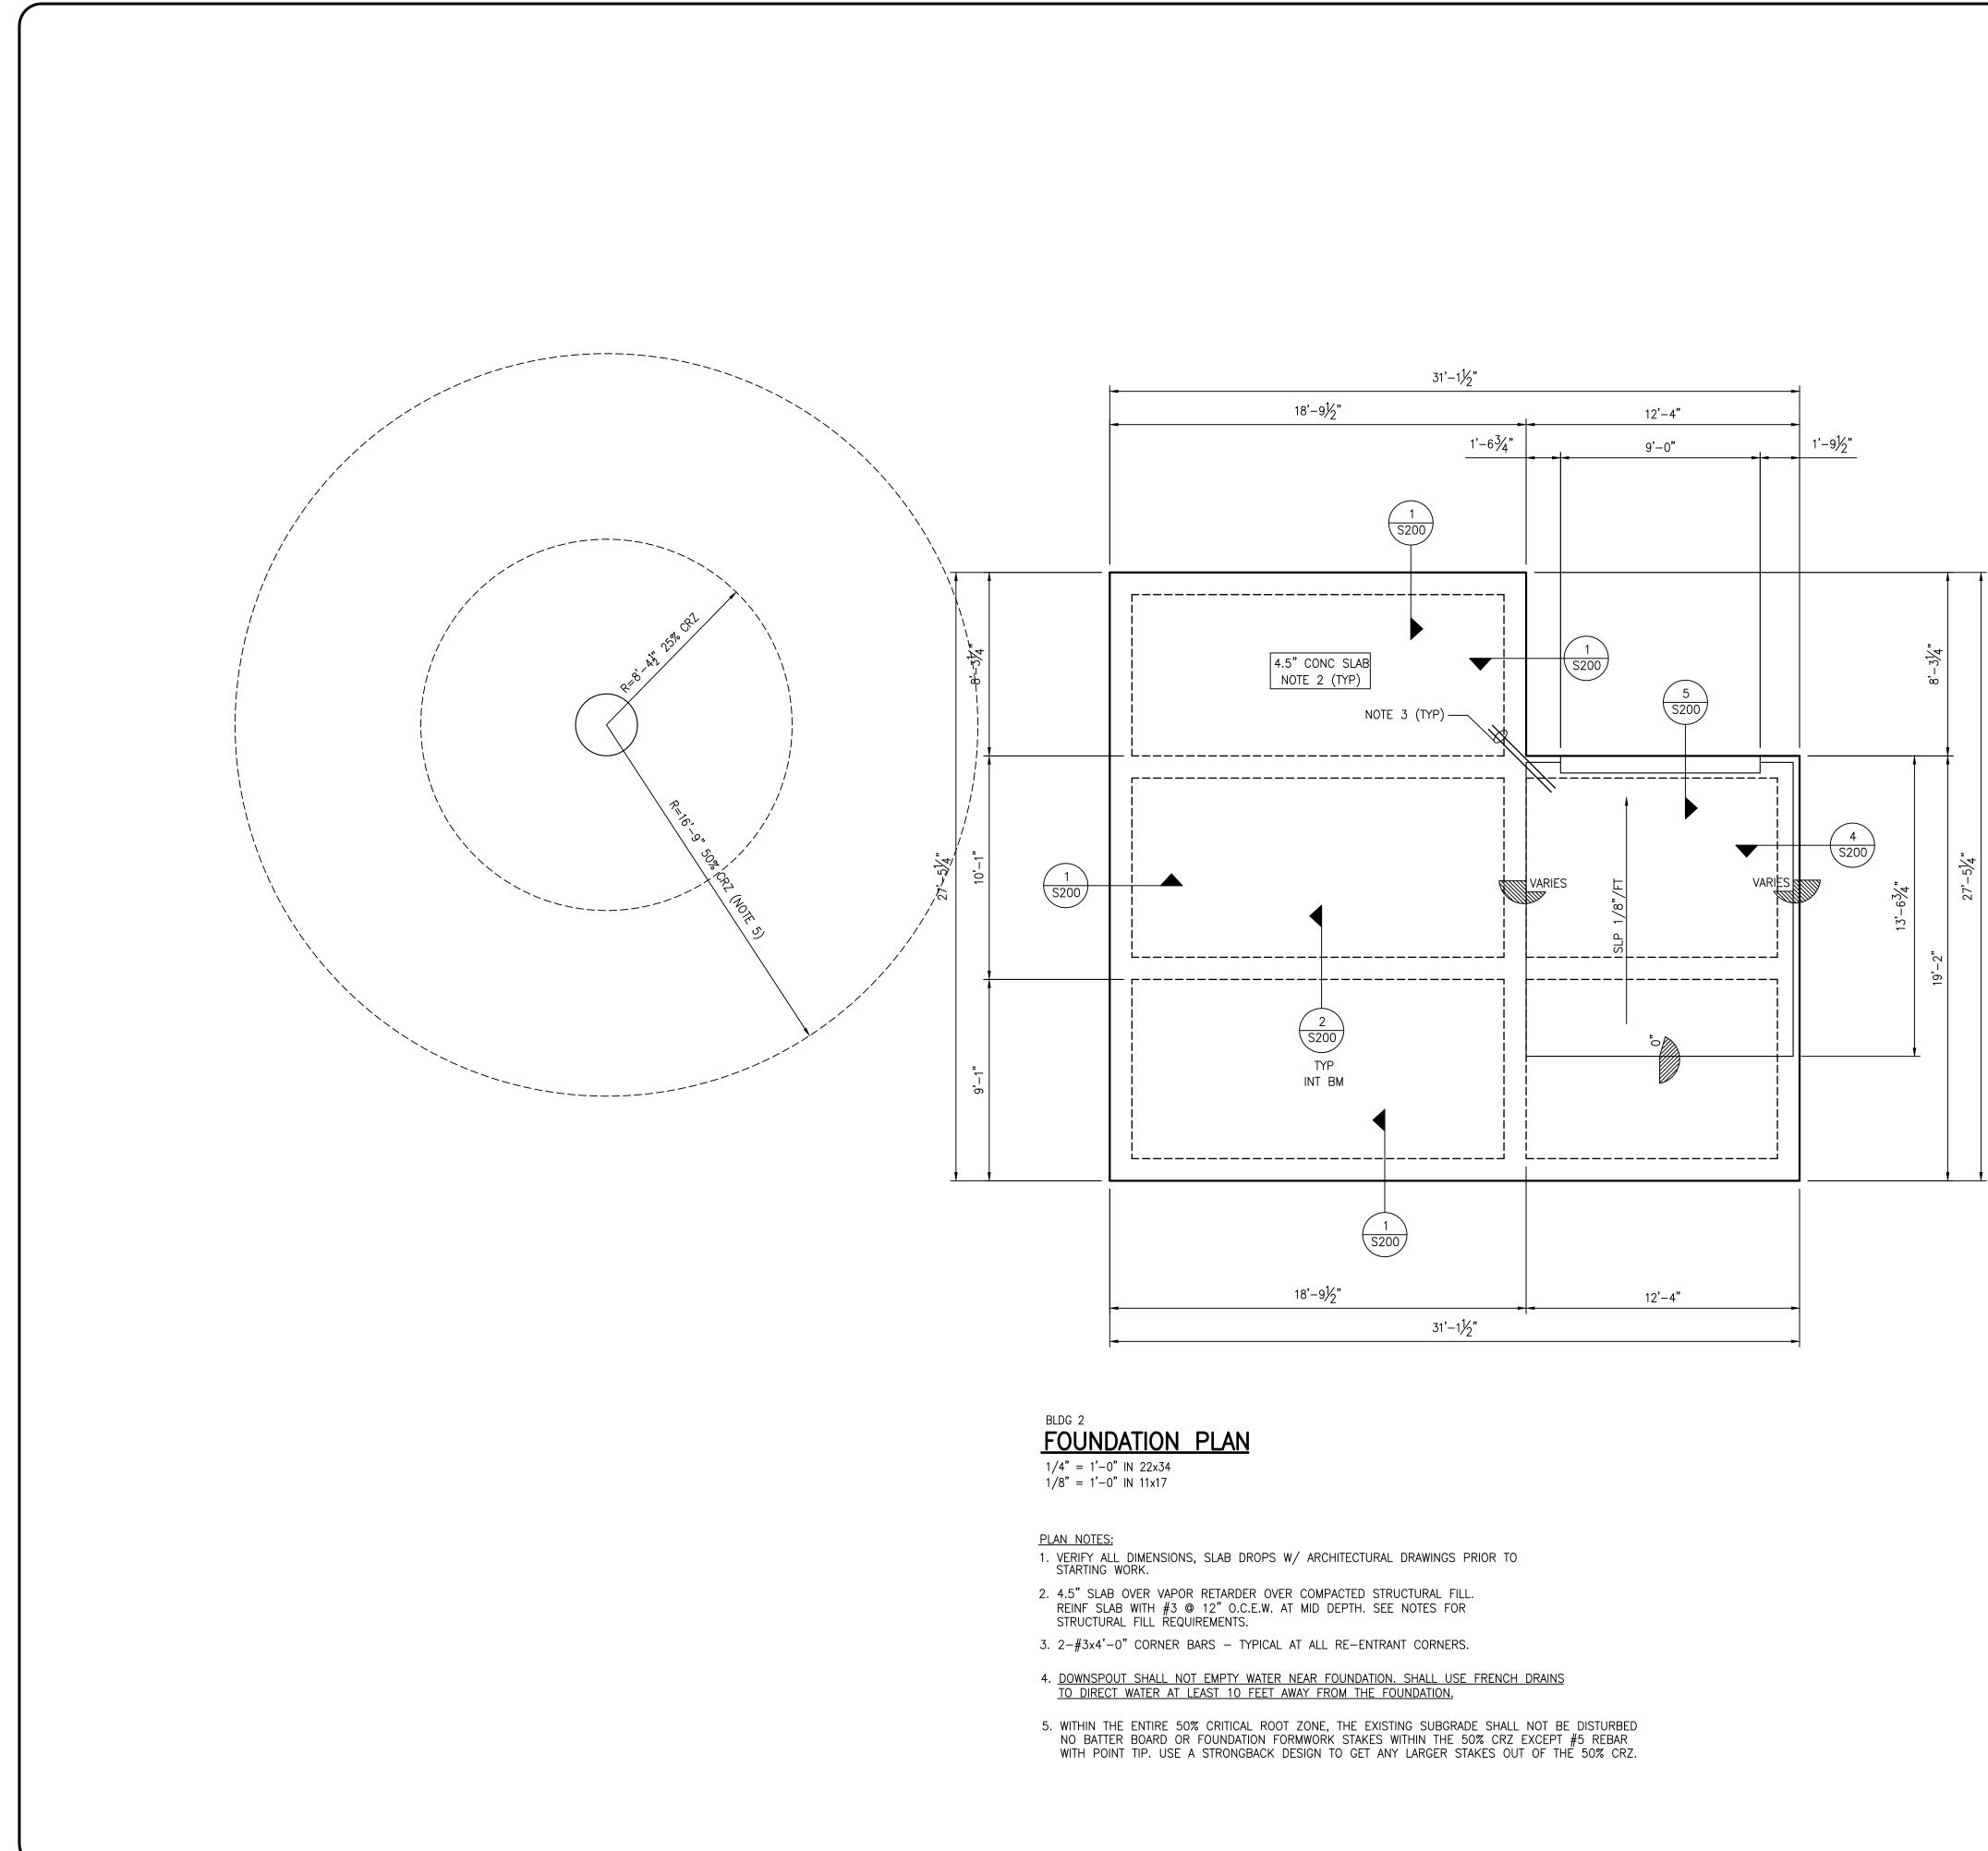



ZHIGANG ZHANG
GREENEARTH ENGINEERING, INC. STRUCTURAL CONSULTING ENGINEERS 2500 WEST WILLAM CANNON DR, #201 AUSTIN, TX 78745 PHONE (512) 289–8086 FAX (512) 383–8339 GE JOB NO.: 21288
3411 NEAL STREET AUSTIN, TEXAS
REV. DATE
CHK. BY: TZ DRWN. BY: TW DATE: 10/05/2021 SHEET NO. S101

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Zhizang Zha 10/05/2021




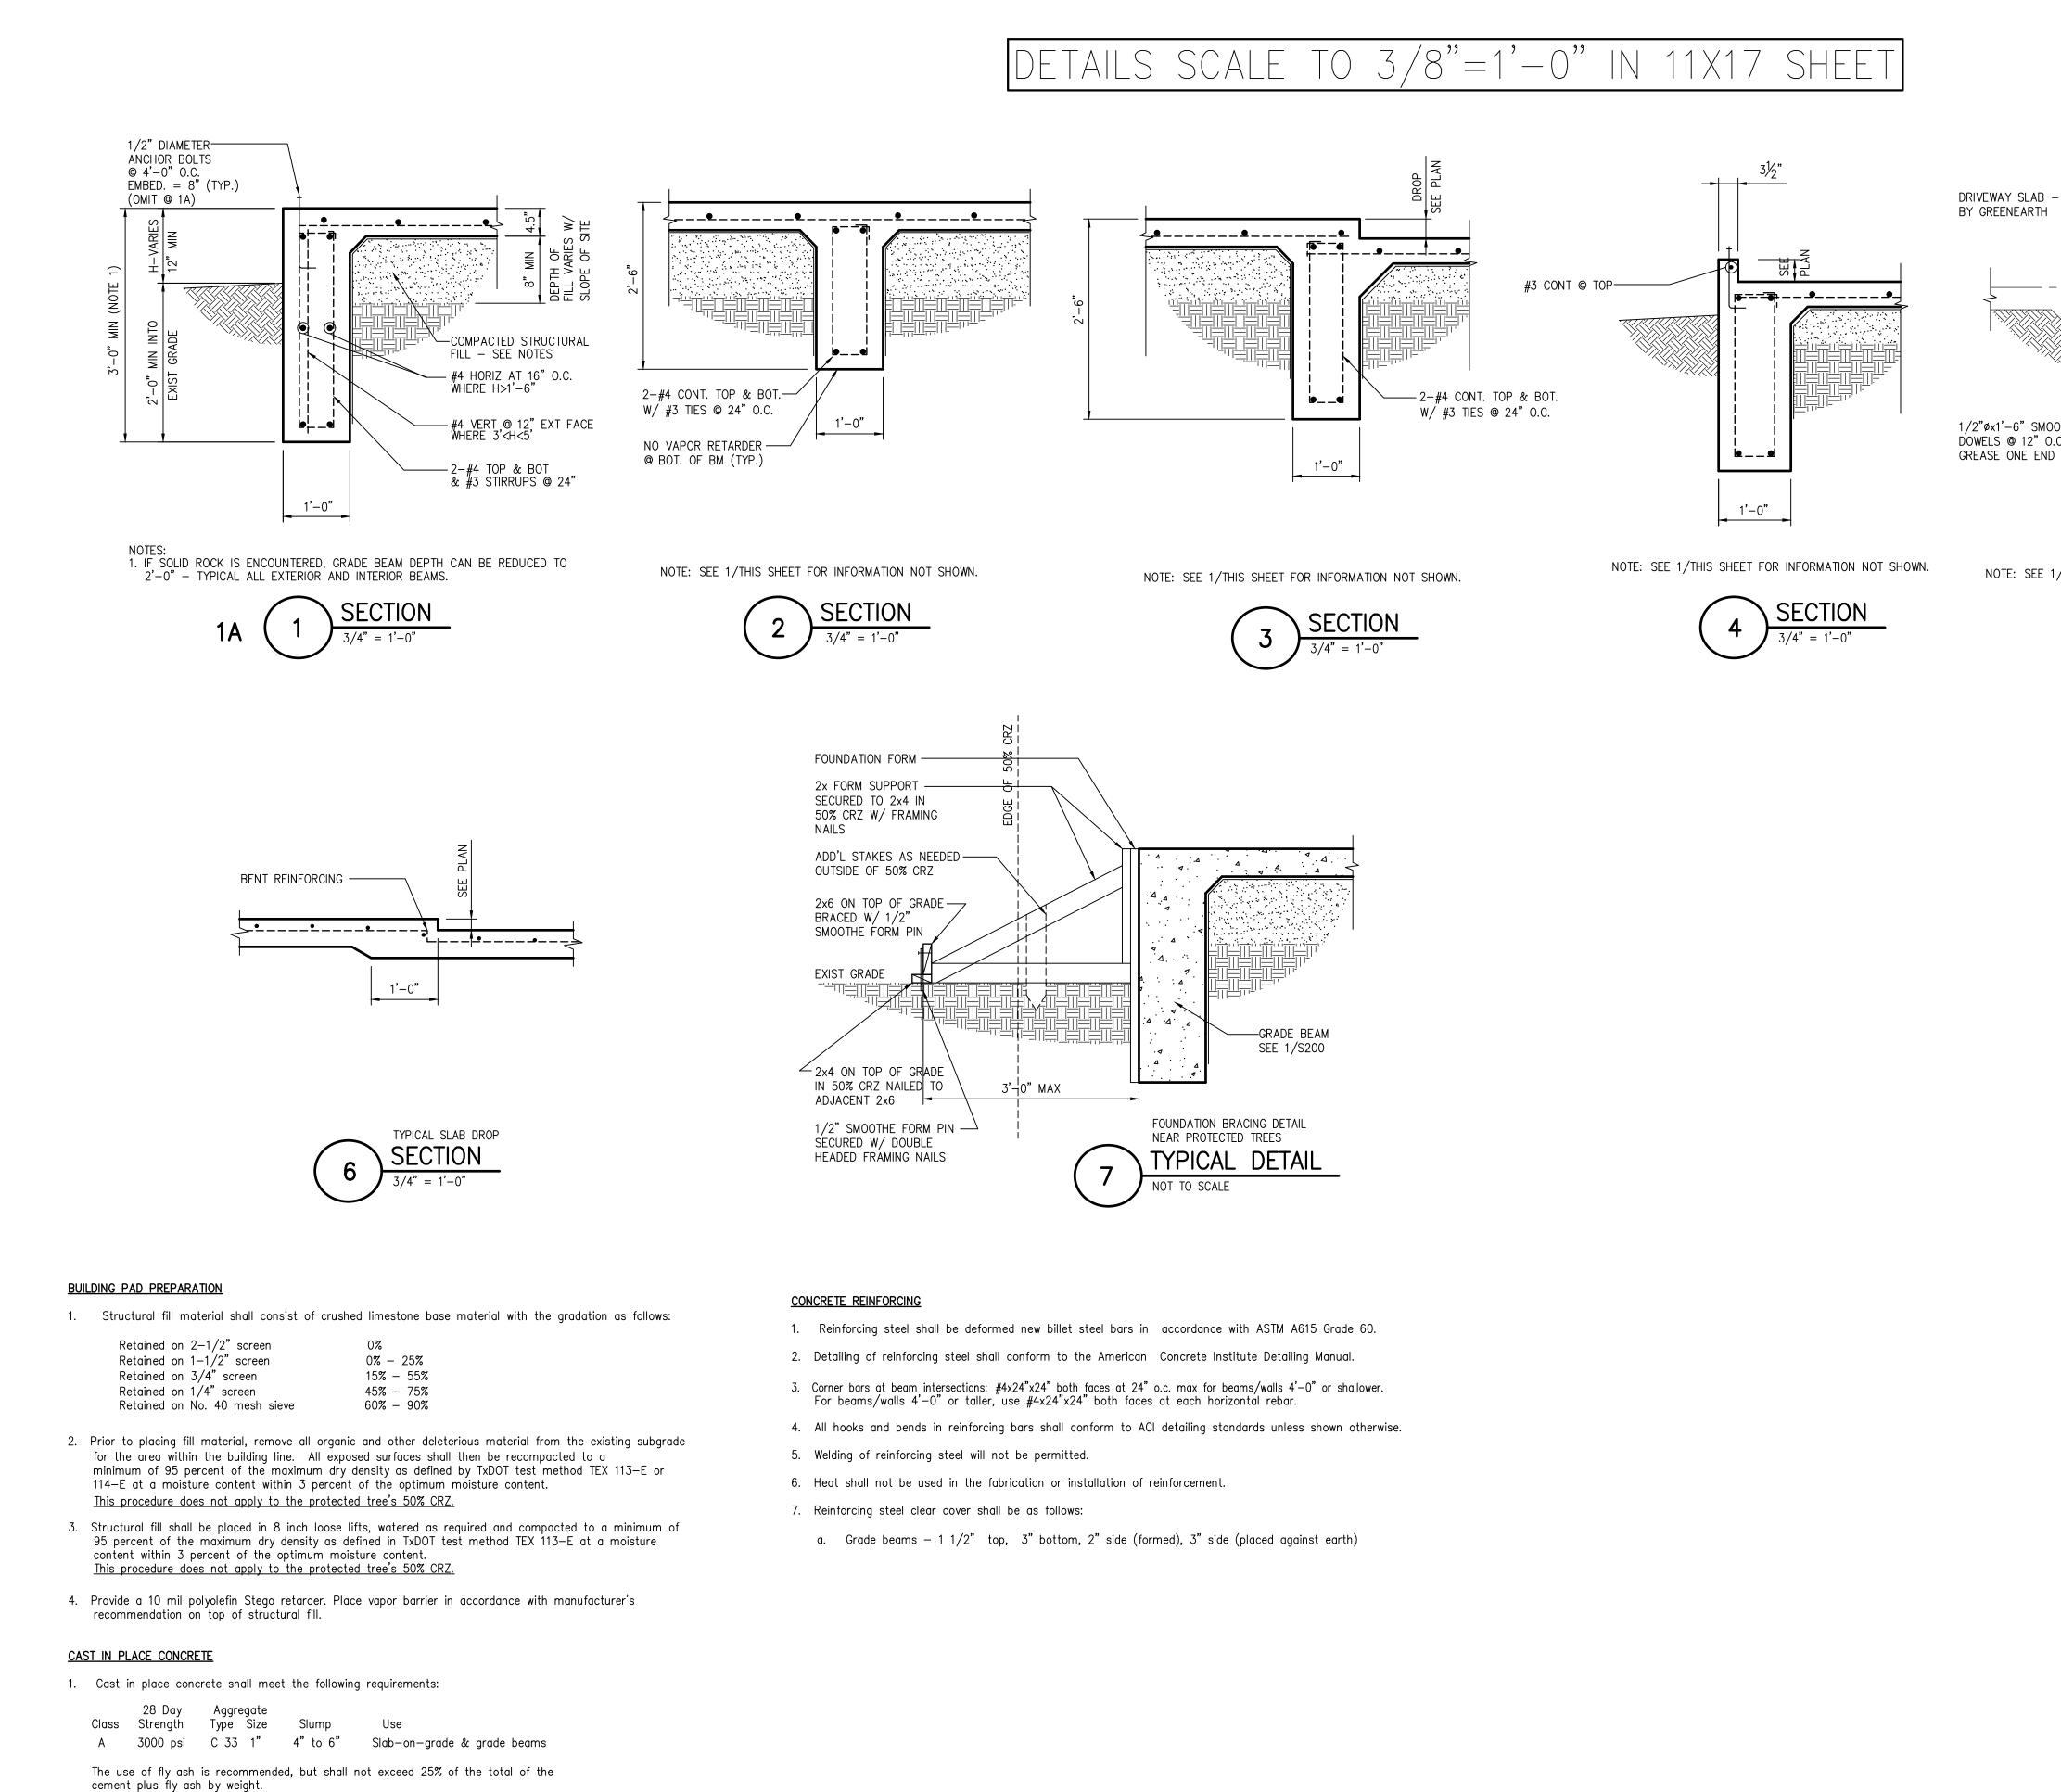


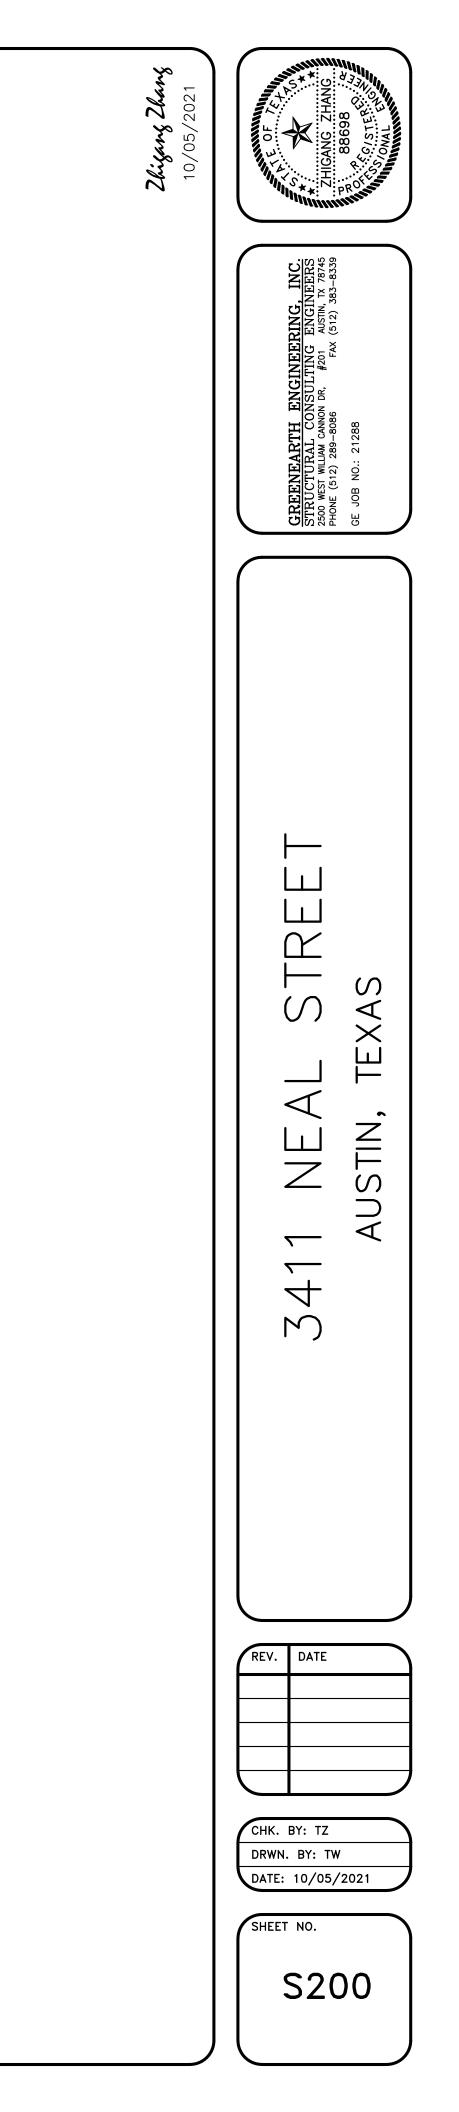


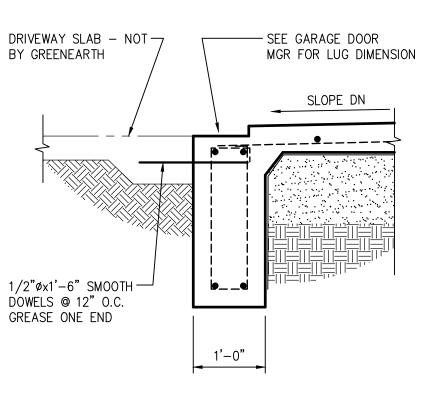
NOTE: SEE 1/THIS SHEET FOR INFORMATION NOT SHOWN. AT GARAGE DOOR



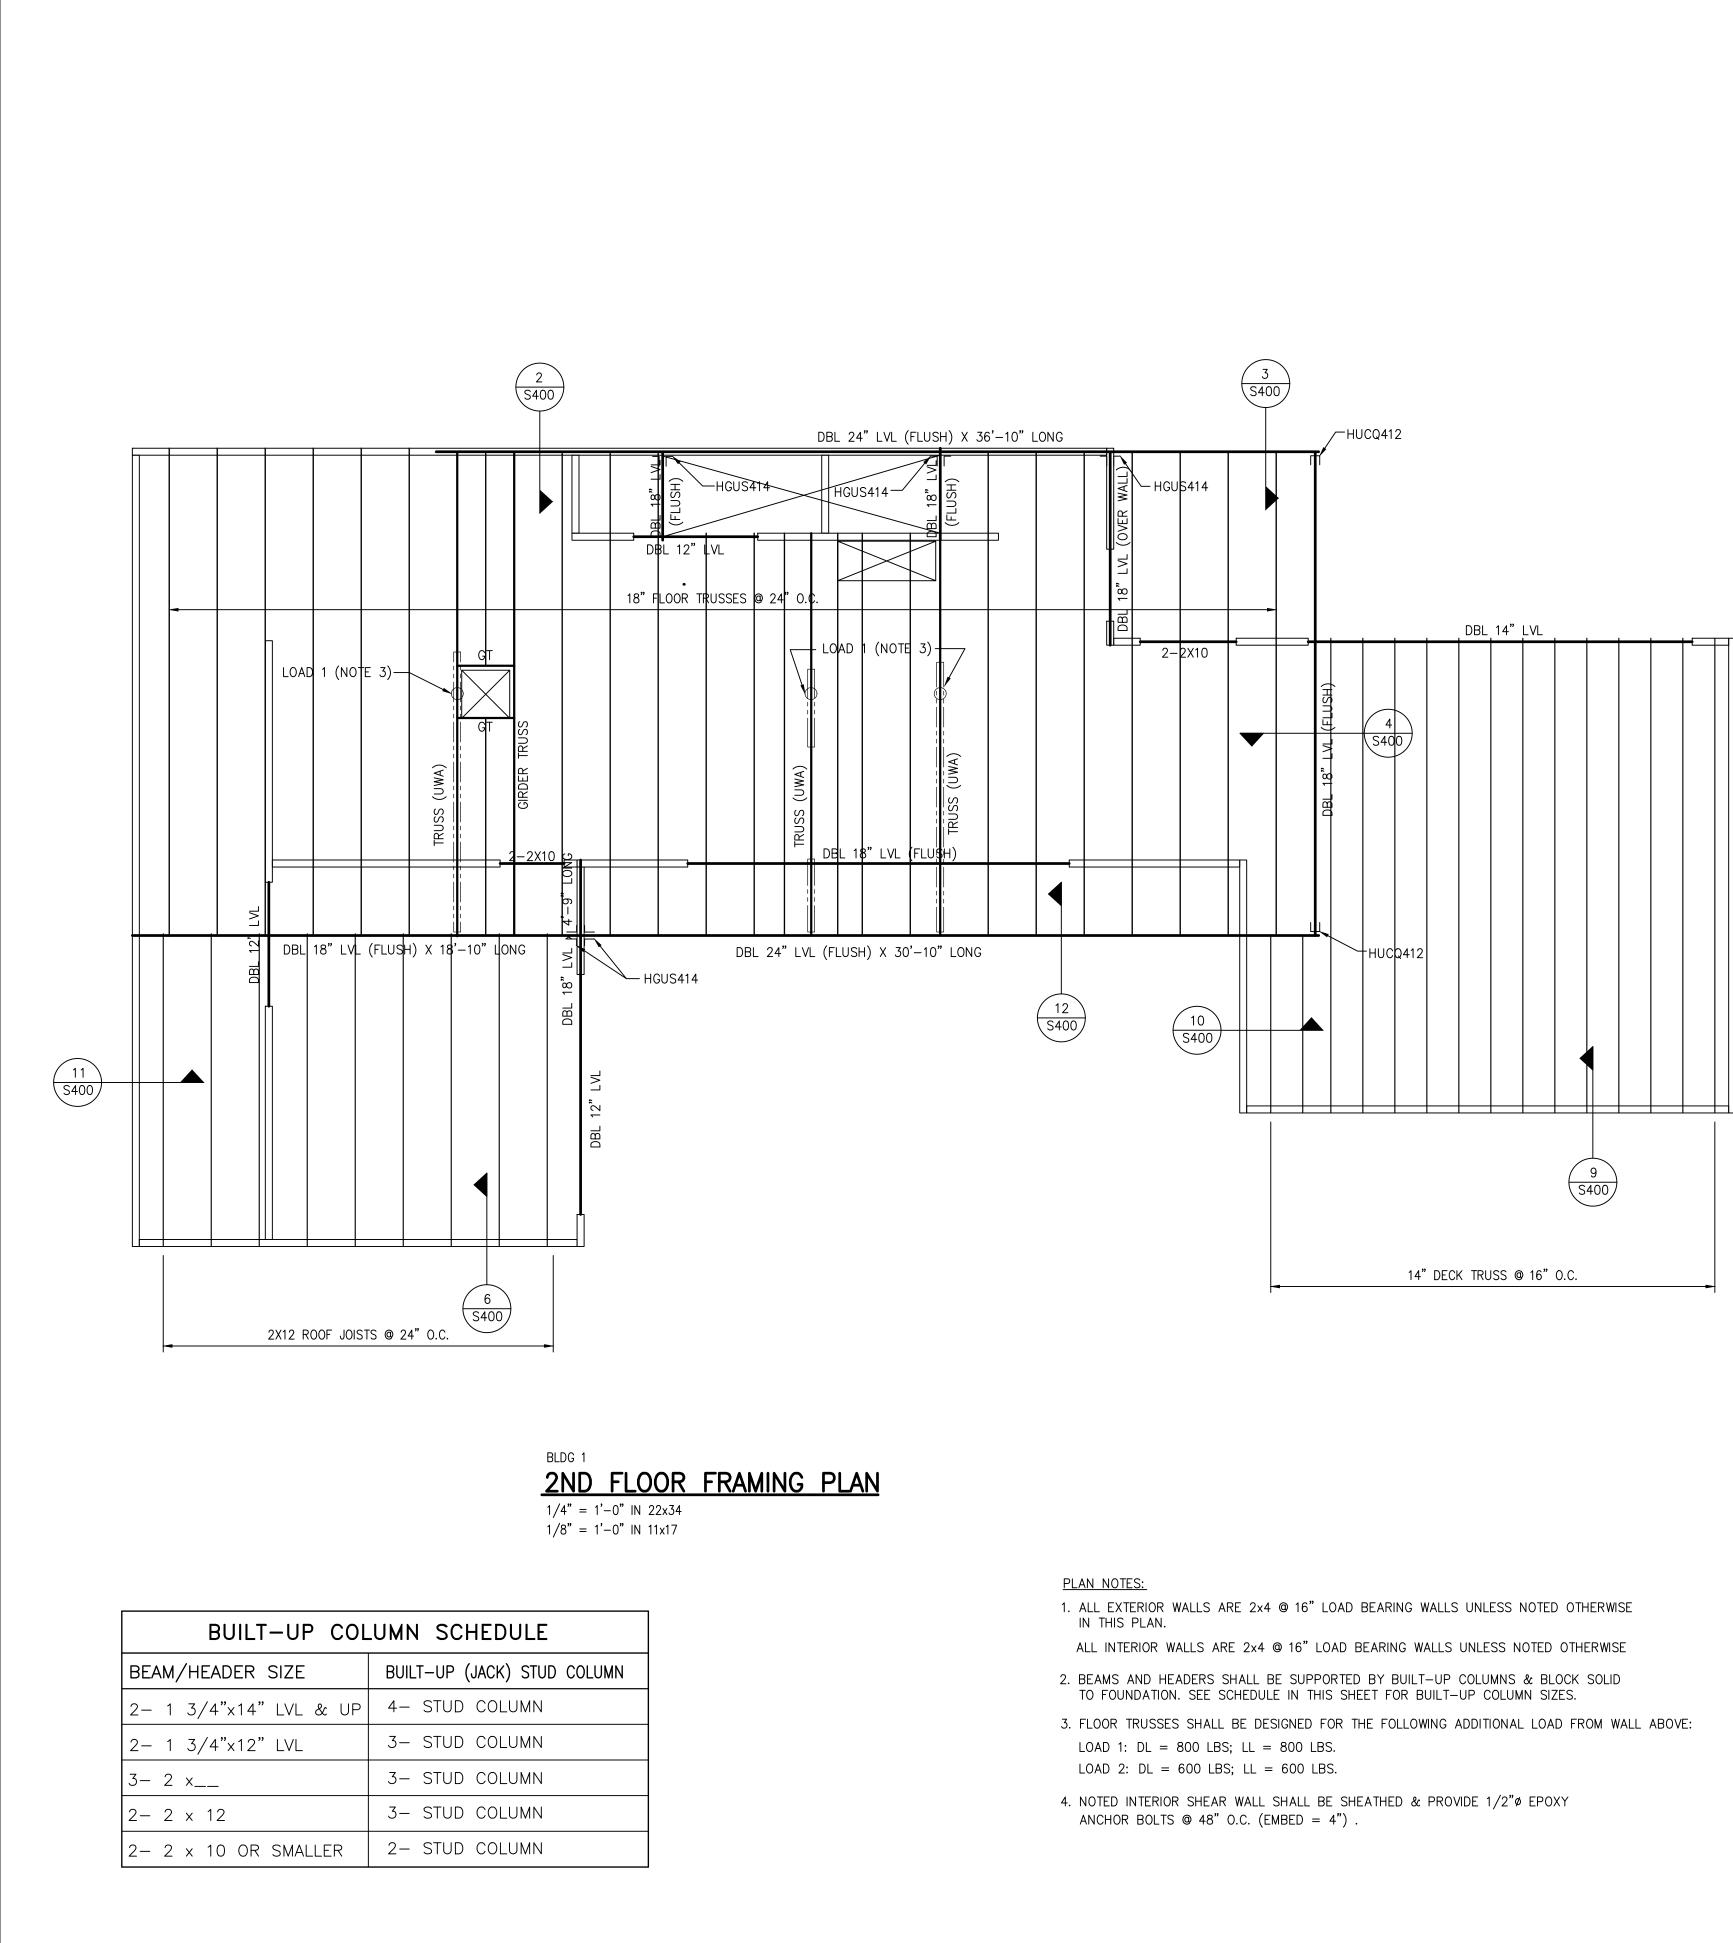

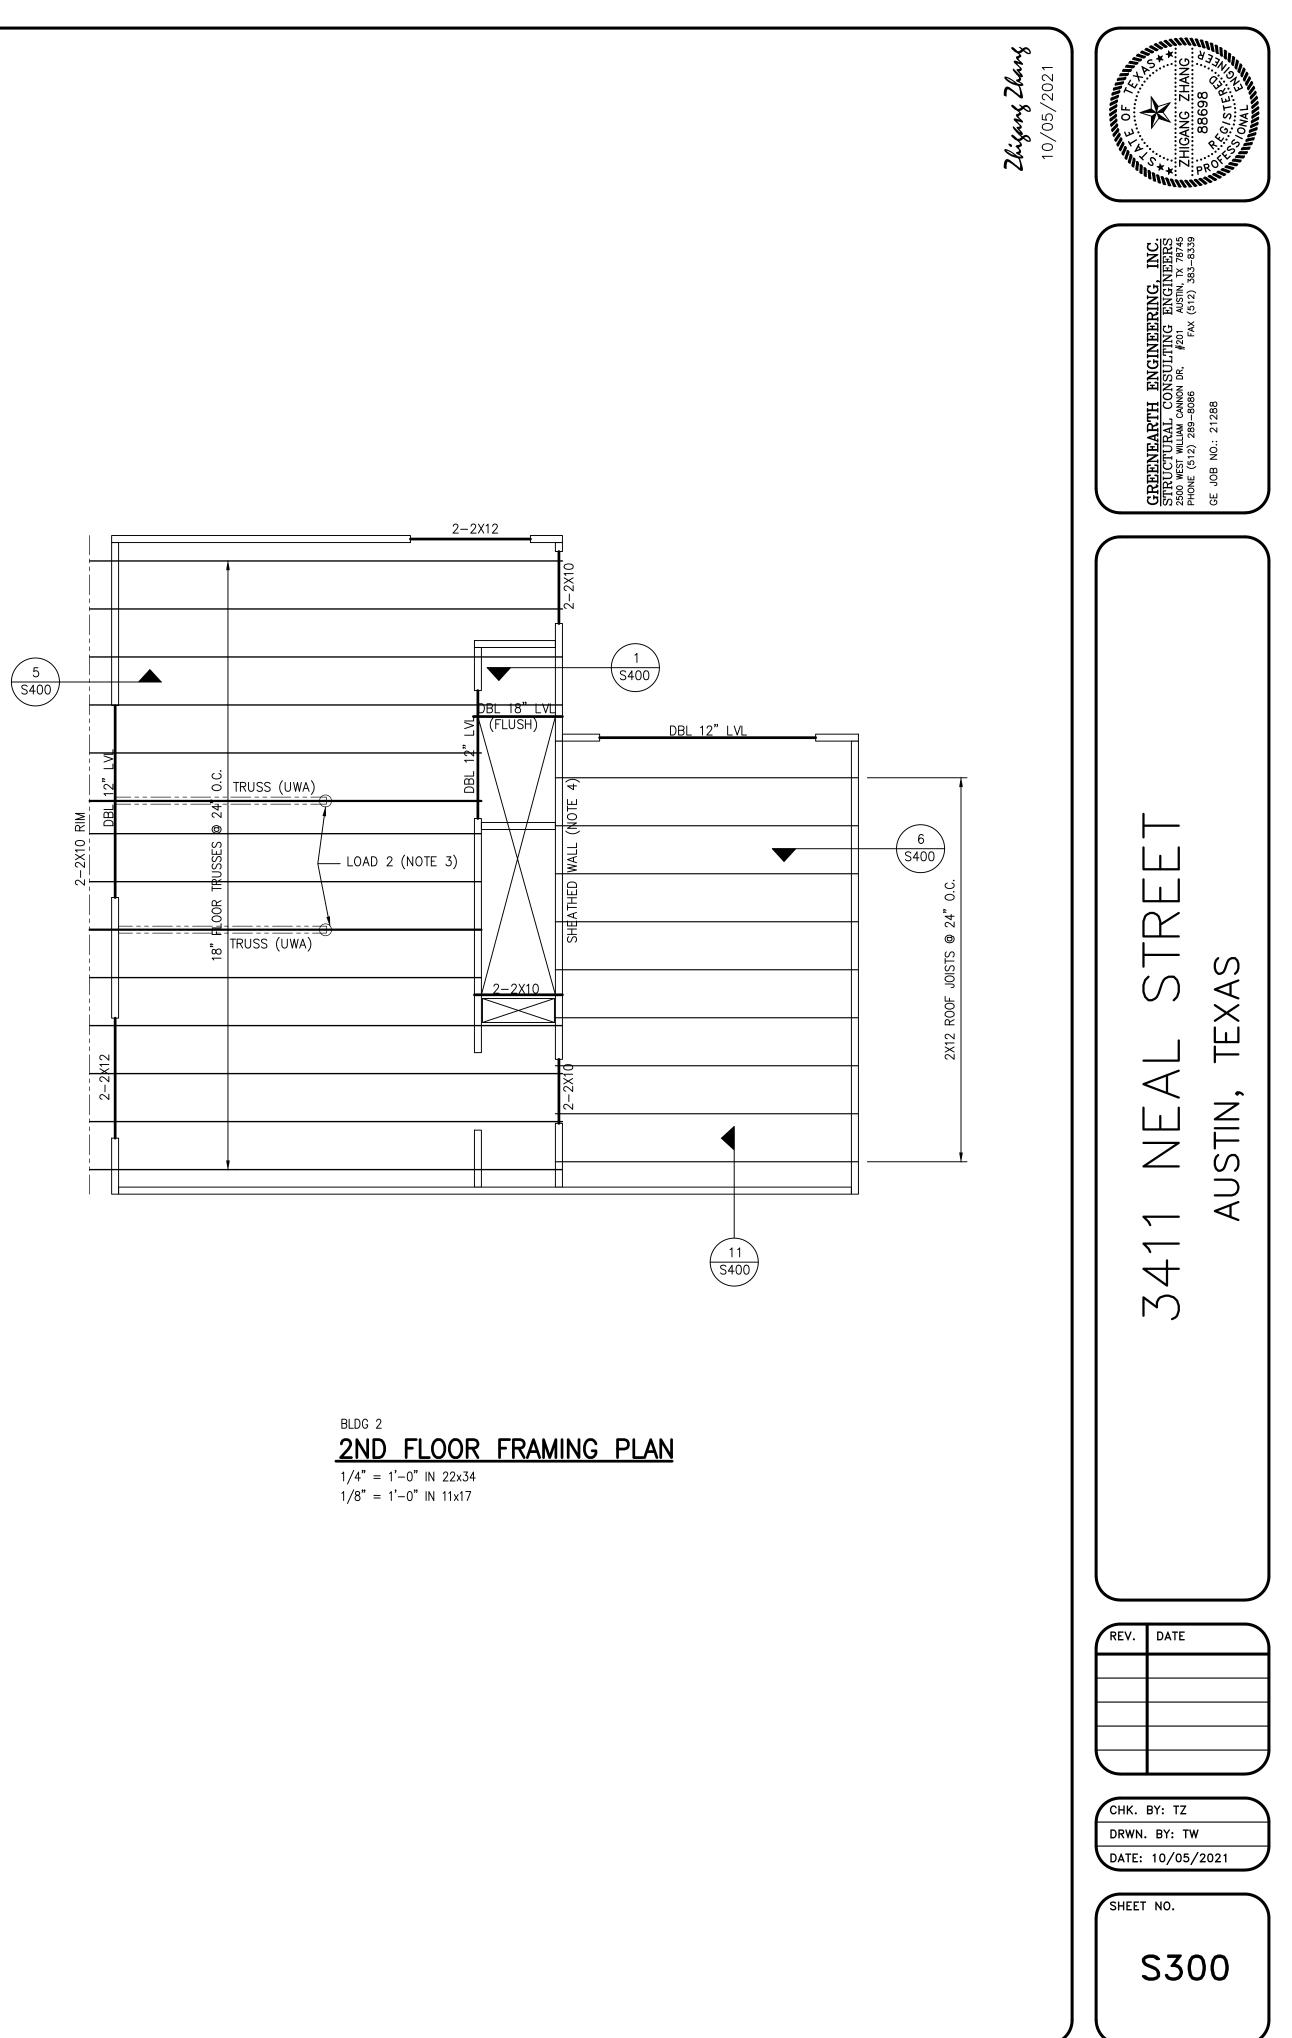

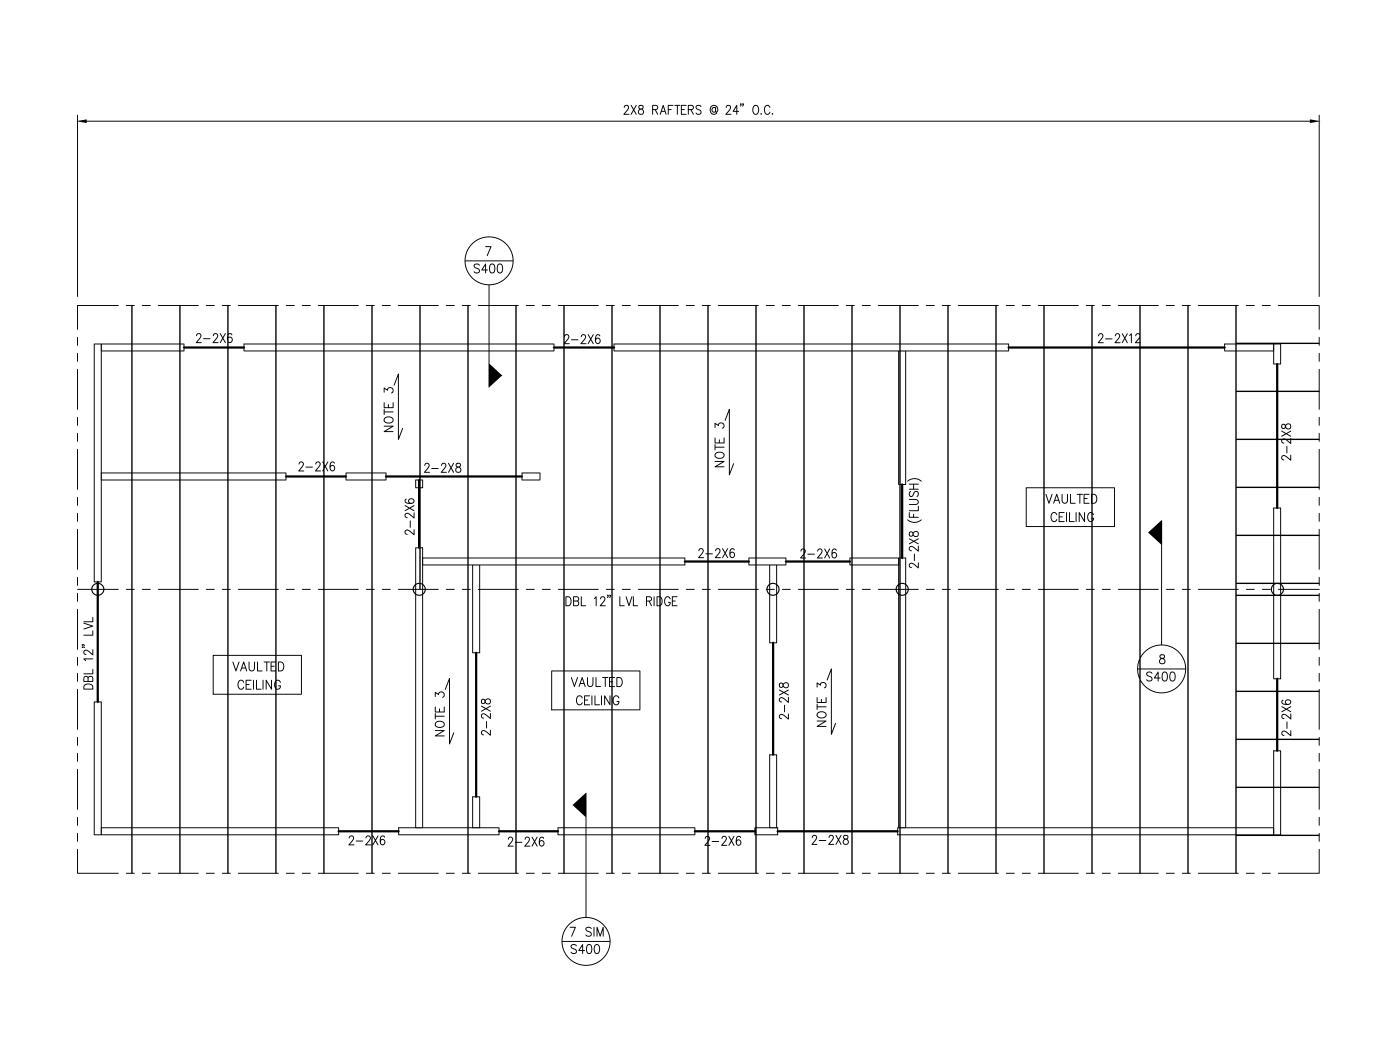

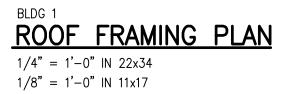

BUILT-UP COLUMN SCHEDULE			
BEAM/HEADER SIZE	BUILT-UP (JACK) STUD COLUMN		
2- 1 3/4"x14" LVL & UP	4- STUD COLUMN		
2- 1 3/4"x12" LVL	3- STUD COLUMN		
3- 2 x	3- STUD COLUMN		
2- 2 x 12	3- STUD COLUMN		
2- 2 x 10 OR SMALLER	2- STUD COLUMN		


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			-2X8	
			2-2X8 (FLUSH)	
	VAULTED			
2-2/8		3L 12" LVL RIDGE		
	VAULTED		2-2X6	
	VAULTED			


BLDG 2 **ROOF FRAMING PLAN** 1/4" = 1'-0" IN 22x34

1/8" = 1'-0" IN 11x17


<u>PLAN NOTES:</u>

- 1. ALL EXTERIOR WALLS ARE 2x4 @ 16" LOAD BEARING WALLS UNLESS NOTED OTHERWISE IN THIS PLAN.
- ALL INTERIOR WALLS ARE 2x4 @ 16" LOAD BEARING WALLS UNLESS NOTED OTHERWISE IN THIS PLAN.
- 2. BEAMS AND HEADERS SHALL BE SUPPORTED BY BUILT-UP COLUMNS & BLOCK SOLID TO FOUNDATION. SEE SCHEDULE IN THIS SHEET FOR BUILT-UP COLUMN SIZES.
- 3. 2×8 CEILING JOISTS @ 24" O.C. NOT SHOWN. ARROW DESIGNATES SPAN DIRECTION.
- 4. O DESIGNATES 2-2x4 BRACE TO CEILING BEAM OR WALL BELOW.

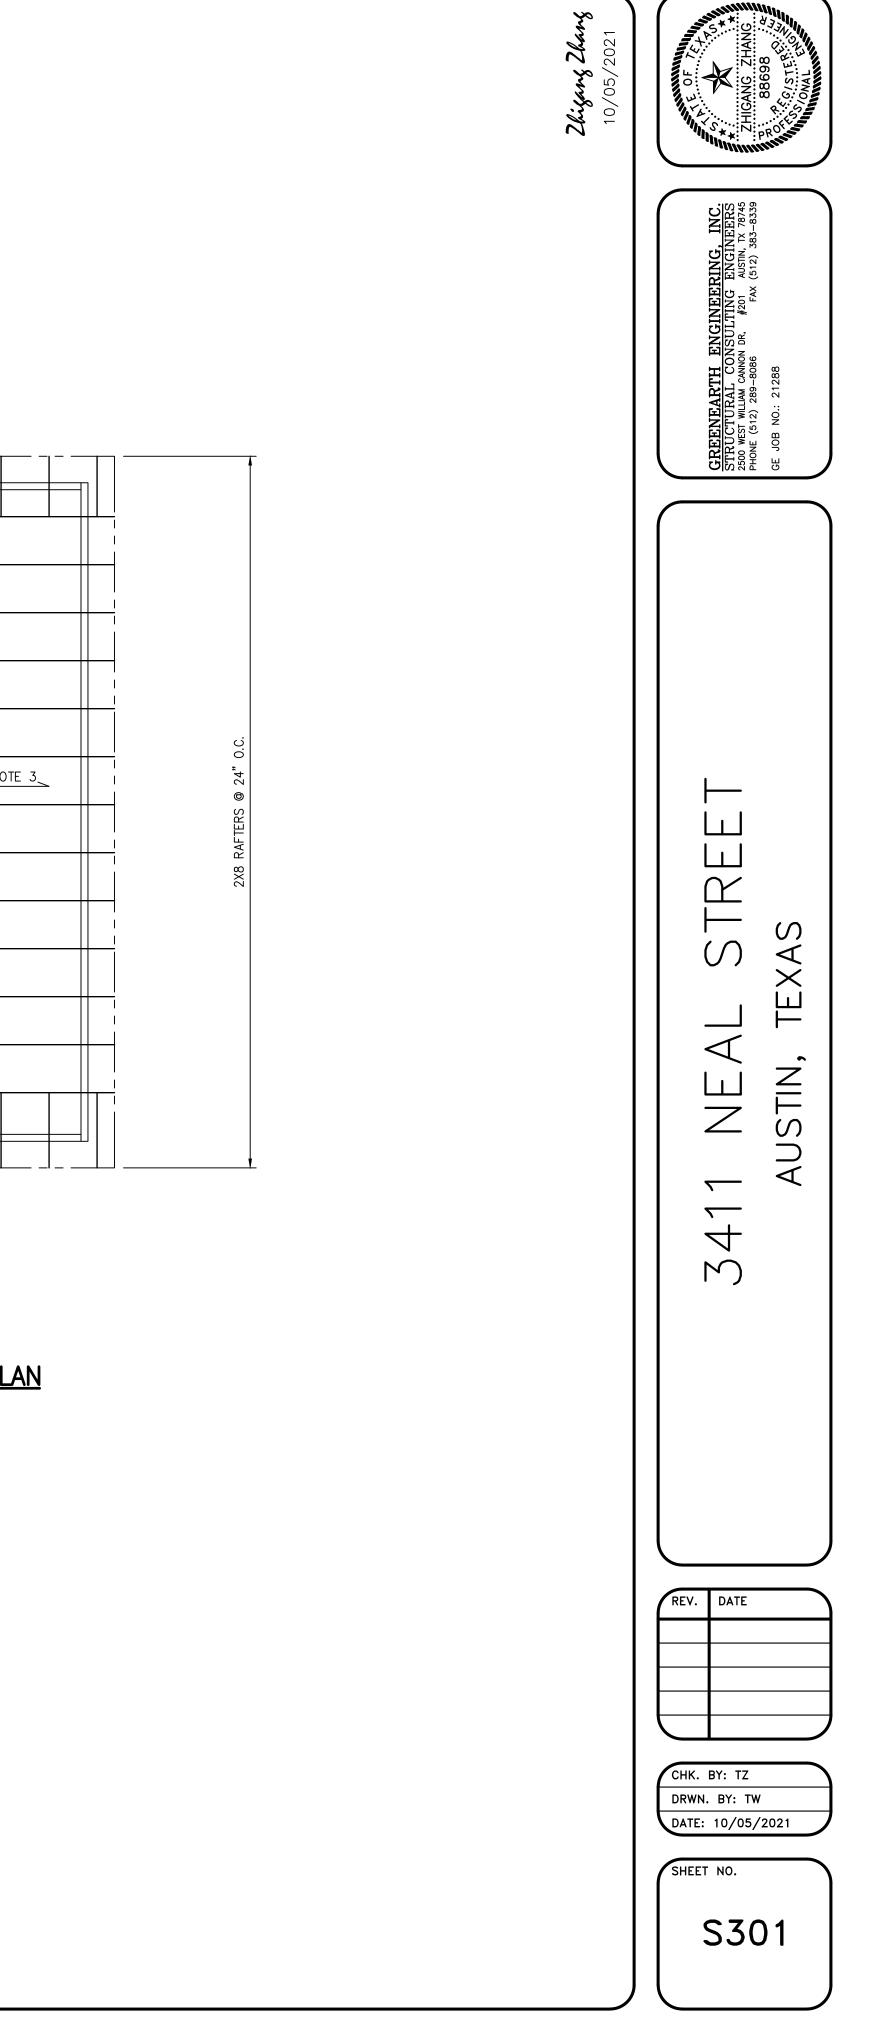


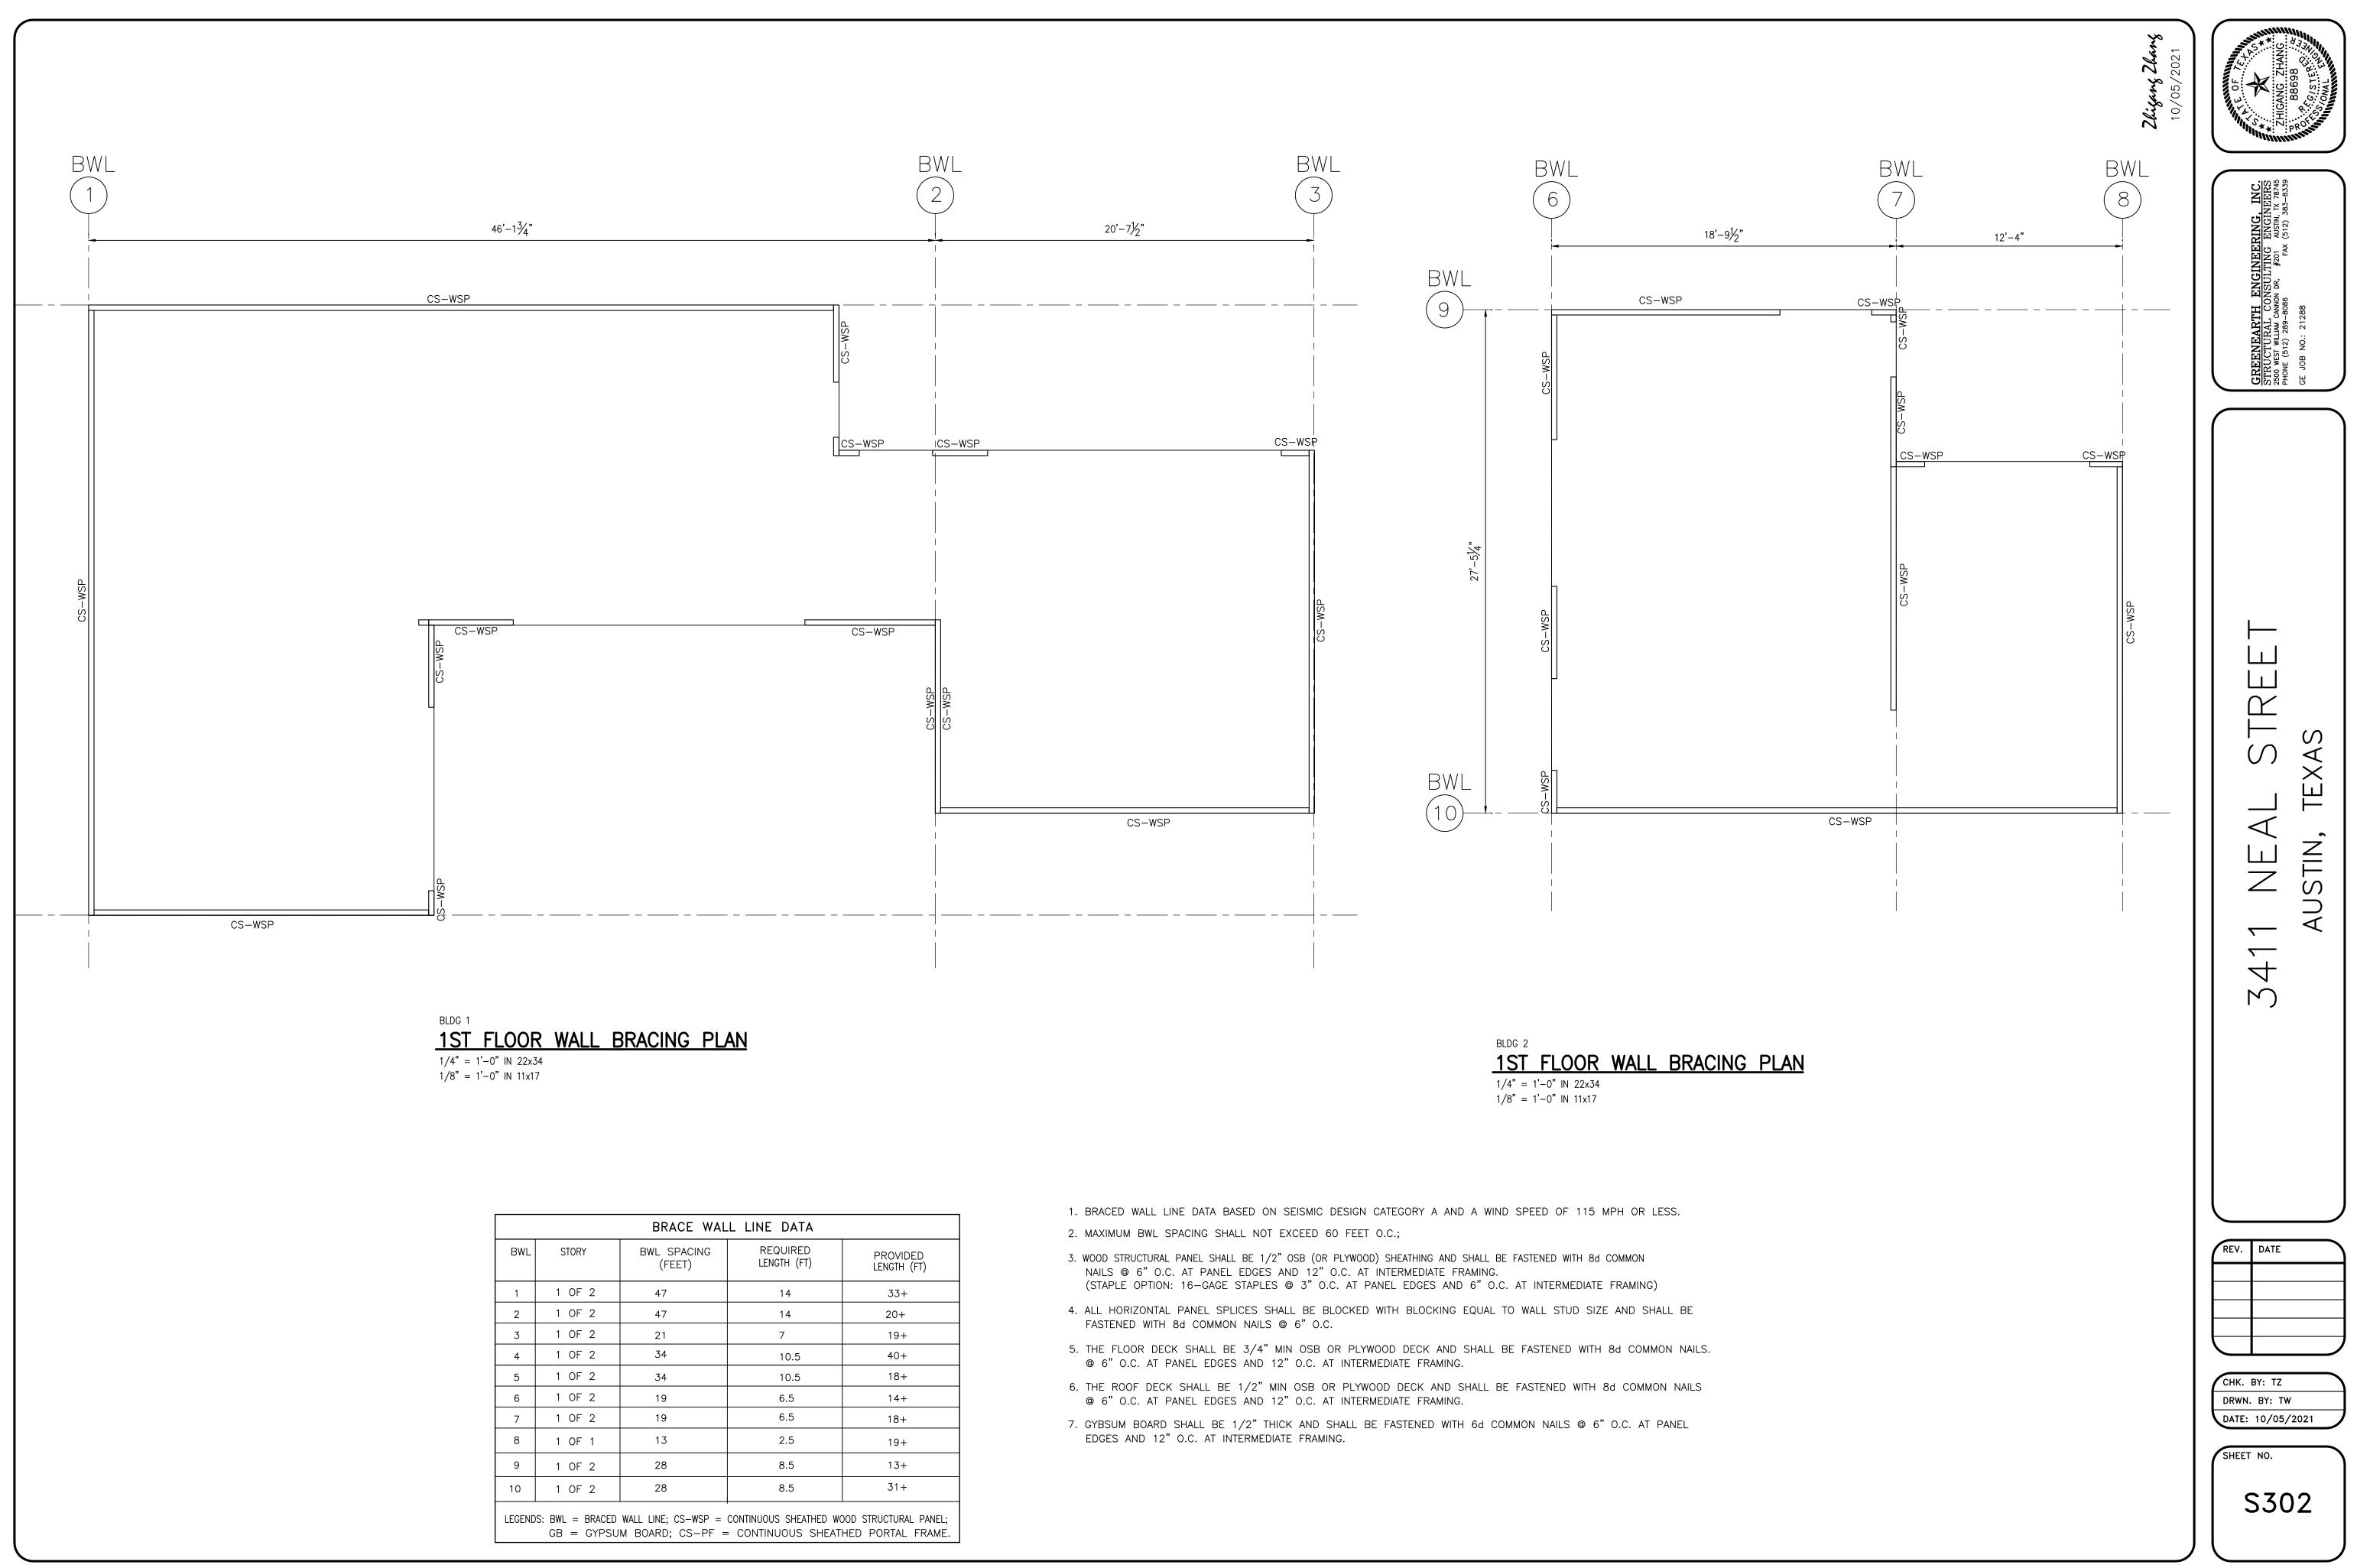

TA	
ED (FT)	PROVIDED LENGTH (FT)
	33+
	20+
	19+
5	40+
5	18+
	14+
	18+
	19+
	13+
	31+
	DOD STRUCTURAL PANEL;

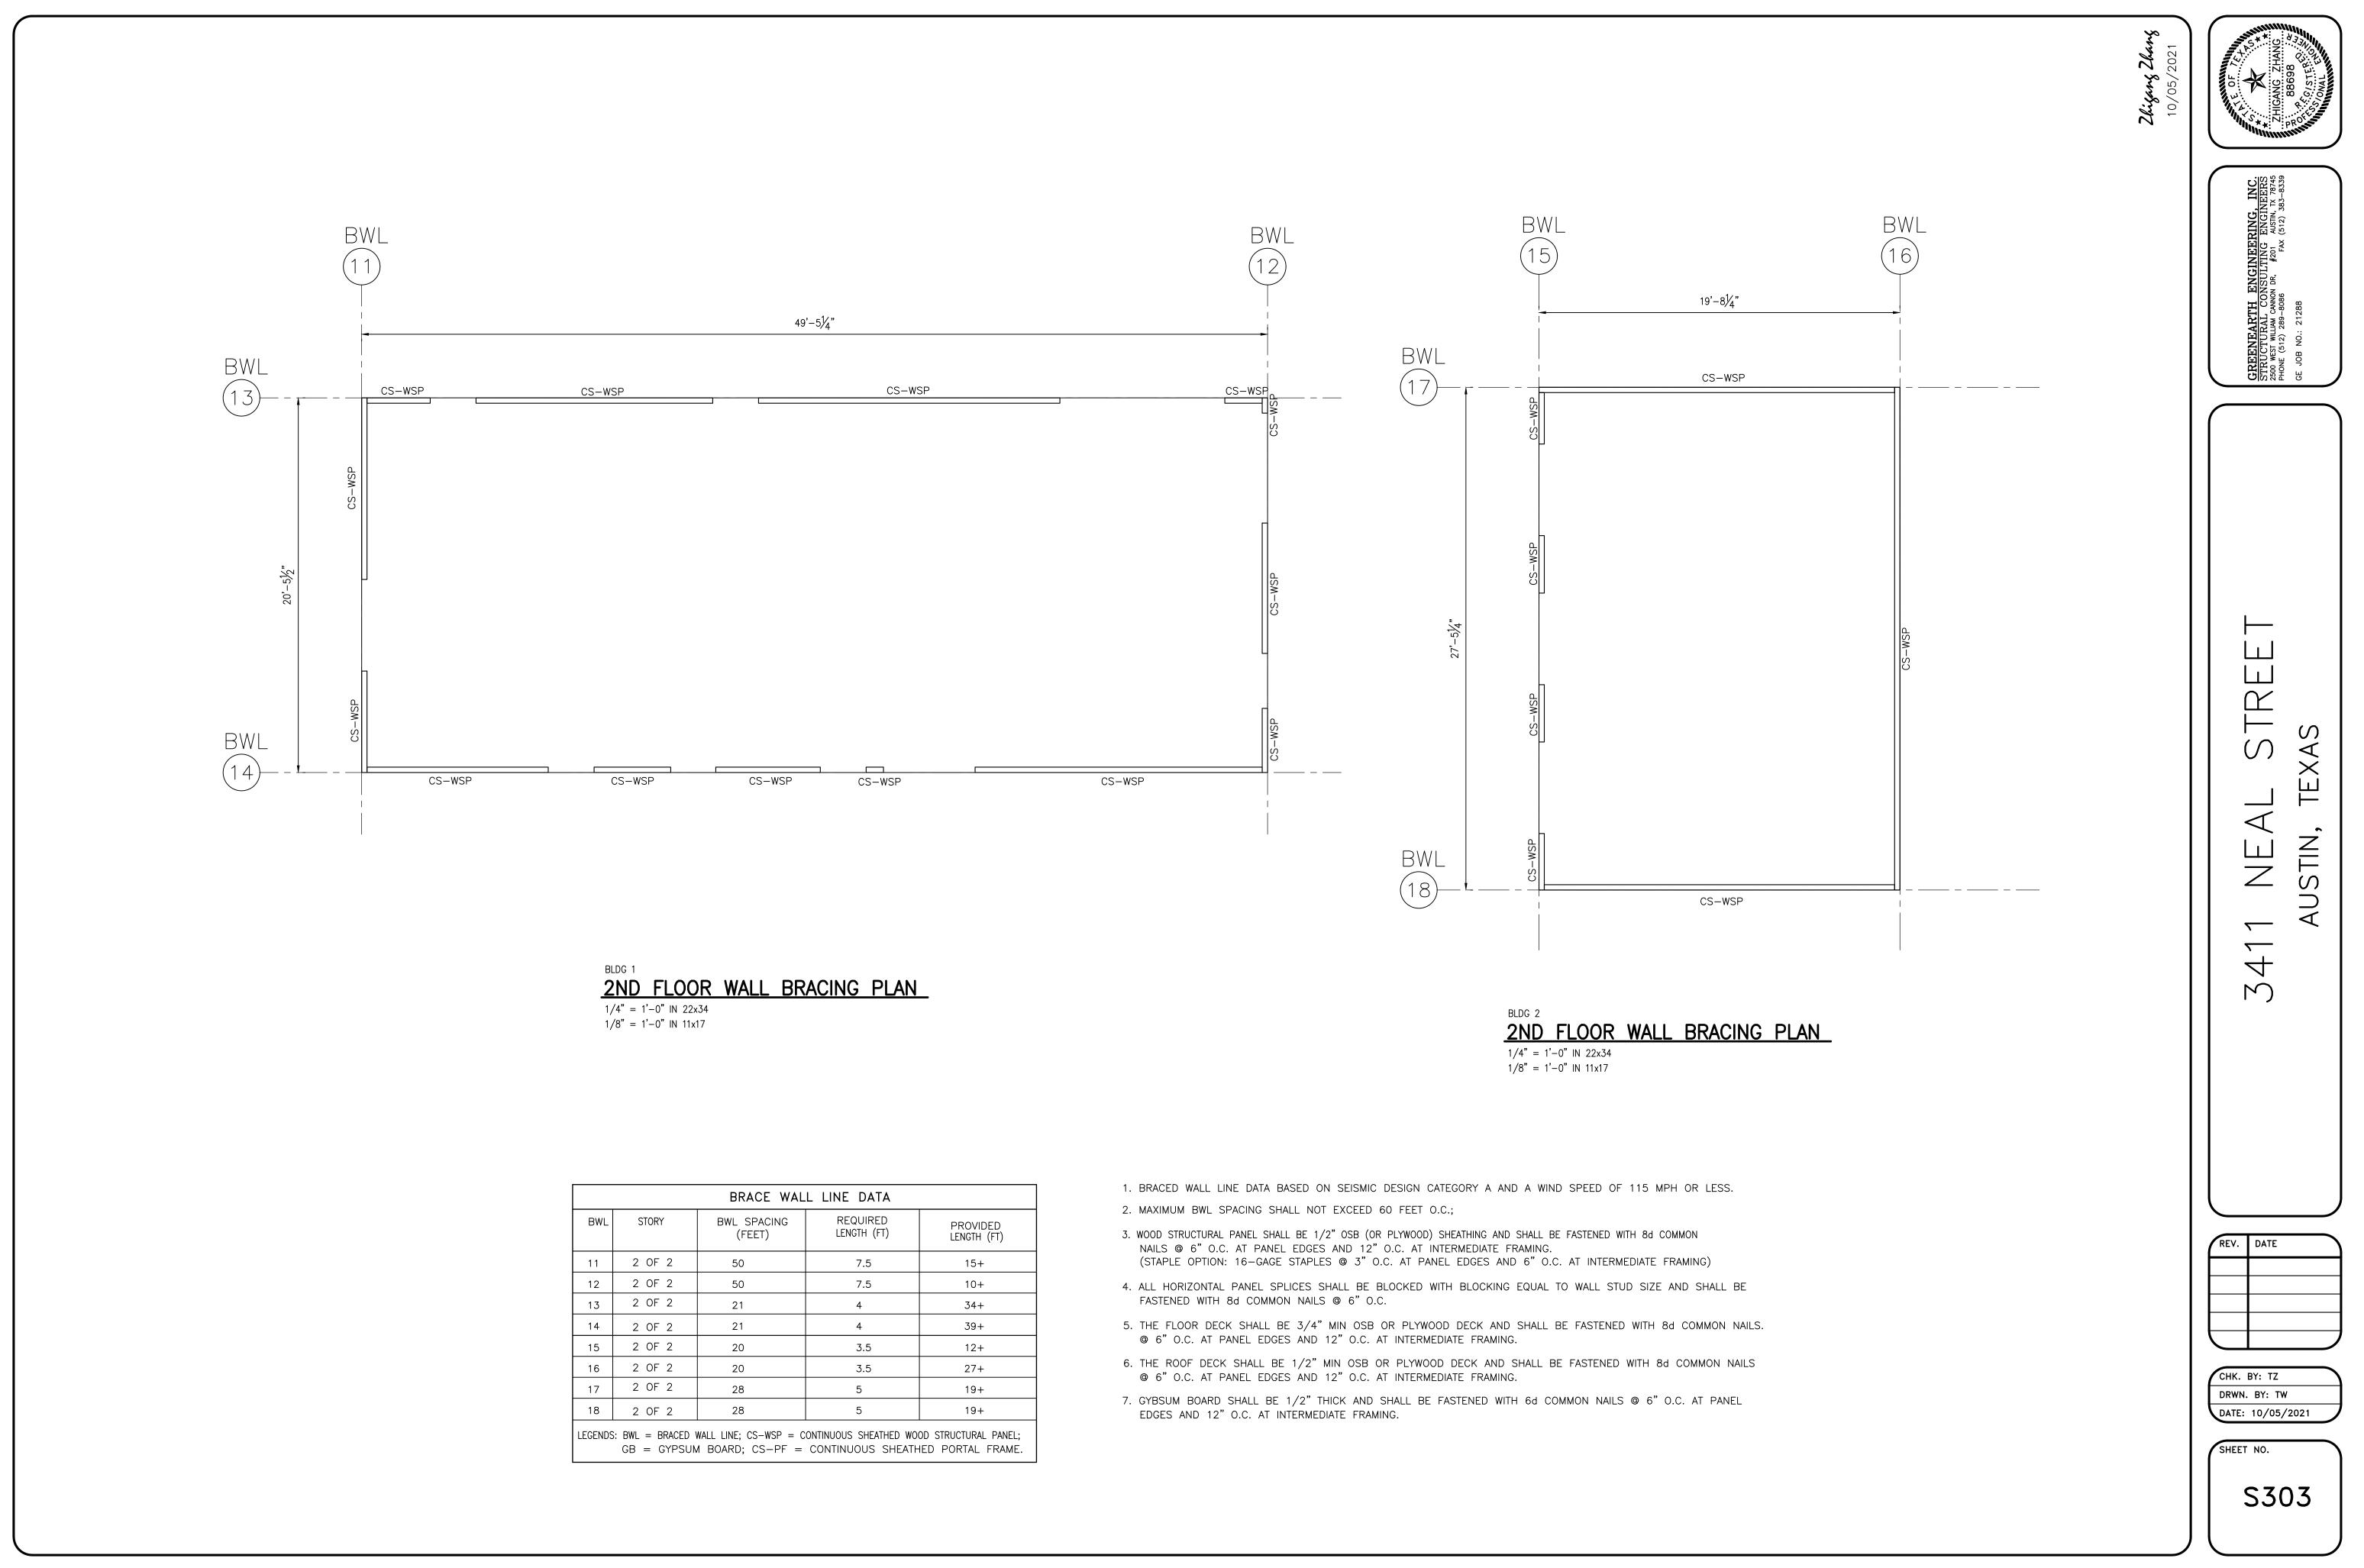

L	L LINE DATA	
	REQUIRED LENGTH (FT)	PROVIDED LENGTH (FT)
	7.5	15+
	7.5	10+
	4	34+
	4	39+
	3.5	12+
	3.5	27+
	5	19+
	5	19+
	ONTINUOUS SHEATHED WO CONTINUOUS SHEATH	

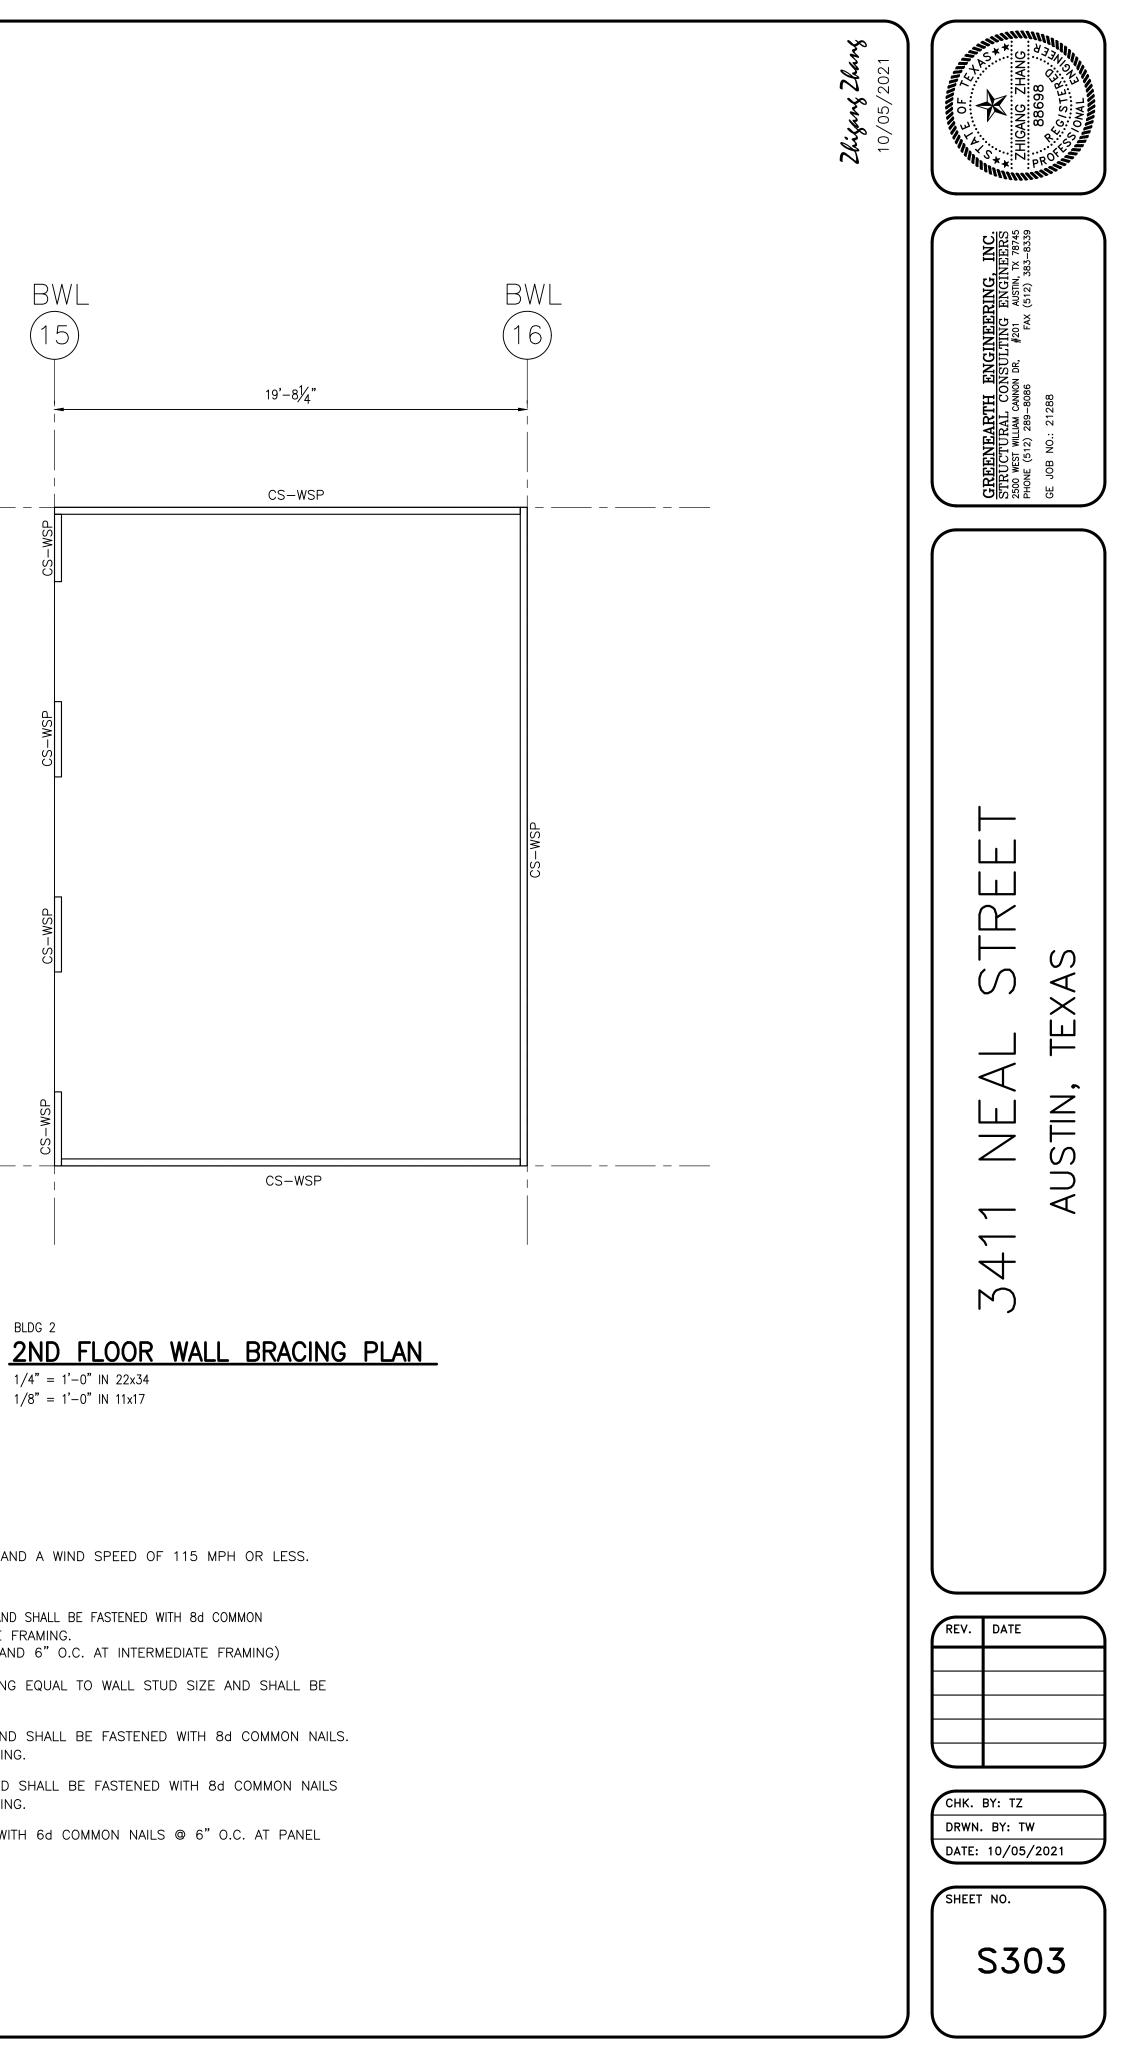

STRUCTURAL GENERAL NOTES

<u>CODES</u>

- 1. Building Code: 2021 International Residential Code.
- 2. Wood Framing: National Design Specifications For Wood Construction with Supplement, National Forest and Paper Products Association, Latest Edition
- 3. Structural Plywood: Plywood Design Specification, American Plywood Association, Latest Edition.
- 4. Prefabricated Metal Plate Connected Wood Trusses: Design Standard for Metal Plate Connected Wood Truss Construction, ANSI/TPI, Latest Edition.

DESIGN LOADS

1.

Liv	ve Loads	
а.	Roof	20 psf
b.	Floor	40 psf
c.	Stair	40 psf

TIMBER FRAMING

- 1. Unless otherwise noted, all structural framing lumber shall be clearly marked no. 2 southern yellow pine or douglas fir, except that non-loadbearing interior walls may be stud grade southern yellow pine, douglas fir, or spruce-pine-fir.
- 2. All wood headers, beams, and top plates shall be no. 2 Southern Yellow Pine or Douglas Fir.
- 3. All load bearing walls shall have solid 2x blocking at 4'-0" o.c. maximum vertically. End nail with 2-16d nails or side toe nail with 2-16d nails.
- 4. Provide double studs at all wall corners and on each side of all openings, unless noted or detailed otherwise.
- 5. The entire exterior wall framing shall be braced by a 1/2" thick panel of APA rated sheathing with an exposure 1 rating extending from the top plate to the sill plate. Where wall is taller than 8'-0'', provide multiple panels as required to extend from sill plate to top plate. Provide 2x blocking as required to support all panel edges. Nail with 8d common nails at 6" on center at supported edges and 12" on center at intermediate supports.
- 6. Solid 2x blocking or bandboard shall be provided at supports and cantilever ends of all wood joists, and between supports in rows not exceeding 8'-0" apart.
- 7. All framing members framing into the side of a header, hip, valley, ridge, truss or any other beams shall be attached using metal joist hangers manufactured by the Simpson Company or equal. The hanger shall be sized and installed in accordance with the manufacturers recommendations for the size of joist supported.
- 8. Nailing and attachment of all framing members and sheathing shall be as specified in the International Residential Code Nailing Schedule (Table R602.3) unless noted otherwise in the drawings. Common wire nails or spikes, or galvanized box nails shall be used for all framing unless noted otherwise.
- 9. Place a single plate at the bottom and a double plate at the top of all stud walls. Exterior sill plates shall be bolted to the foundation with 1/2" anchor bolts with a minimum embedment of 8" spaced at 4'-0" on center. Provide a minimum of two bolts per plate segment. Sill plates in contact with concrete or masonry shall be pressure treated with a preservative.
- 10. Provide double joists under all interior partition walls oriented parallel to the joists.
- 11. Provide triple studs (or cripples) at each end of any header, beam, ridge, valley, or hip spanning over 10'-0" unless noted otherwise. Provide double studs (or cripples) at each end of any header, beam, ridge, valley, or hip spanning 5'-0" to 10'-0" unless noted otherwise.
- 12. The new generation of pressure treated lumber products are highly corrosive to metal connectors and fasteners. All fasteners and metal connectors used in conjunction with the new generation of pressure treated lumber shall be hot-dip galvanized or stainless steel. These locations include, but are not limited to the following:
- Anchor bolts at sole plate to foundation. Nails from sole plate to wall studs.
- Nails at exterior plywood sheathing to sole plate. Bolts at ledger to concrete.
- Joist to treated ledger connections.
- All hangers on treated joists. Wood posts to concrete.
- Deck board to treated joists.

PREFABRICATED METAL PLATE CONNECTED WOOD TRUSSES

- Trusses shall be designed by the Contractor in accordance with the Truss Plate Institute "Design Standard for 1. Metal Plate Connected Wood Truss Construction" (ANSI/TPL 1-95).
- 2. Truss members shall be clamped in a mechanical or hydraulic jig with sufficient pressure to bring members into reasonable contact at all joints during application of connector plates.
- 3. Provide adequate erection bracing in accordance with Truss Plate Institute publication HIB-91.
- 4. Truss Manufacturer shall provide permanent bracing as required by the design of the trusses. Erection bracing may remain in place as permanent bracing where it does not interfere with the architectural finishes.
- 5. All timber truss members shall be Southern Yellow Pine with a maximum moisture content of 19%. Chord
- 6. Connection plates shall be manufactured by a WTCA member plate manufacturer. Plates shall be 20 gauge
- minimum, ASTM A446 grade A steel, with a G60 galvanized coating. 7. Trusses shall be designed in accordance with the following requirements:

members shall be no. 2 or better and web members shall be no. 3 or better.

- a. Top chords shall be designed to resist the local bending induced by the floor or roof uniform load on the top chord.
- b. Limit live load deflection of floor trusses to L/480. Total load deflections shall be limited to L/360.

COMPOSITE WOOD MEMBERS


- Where noted on the drawings, joists shall be TJI "SP" series engineered wood joists, and beams shall be "Micro-Lam" or "Parallam" beams as manufactured by the Trus Joist Macmillan Corporation.
- 2. Do not notch joists or beams. Drill holes through webs of engineered wood members for mechanical, electrical or plumbing services in accordance with the recommendations of the engineered wood product manufacturer.
- 3. Multiple wood beams up to three members thick shall be nailed together with three rows of 16d nails at 12" on center. Four or more multiple wood beams and any multiple wood beams utilizing beams thicker than 1 3/4" shall be bolted together with 1/2" diameter bolts top and bottom at supports and ends of the beam, then at 24" on center, staggered top and bottom for the full length of the beam.
- 4. Where multiples of two 1 3/4" Micro-Lam beams are noted on the drawings, contractor may provide single 3 1/2" beams in lieu of double 1 3/4" beams.
- 5. Provide web stiffeners where required by the manufacturer for the specified support condition.


STRUCTURAL STEEL


- 1. Structural Steel W-shapes shall conform to ASTM A992. Steel plates, angles, and channels may be ASTM A572, grade 50 or ASTM A36. Steel pipe shall conform to ASTM A501 or ASTM A53, Type E or S, grade B. Steel tube shall conform to ASTM A500, grade B, Fy 46 ksi.
- 2. Column base plates shall be grouted with a nonshrink, high strength nonmetallic grout. Pre-grouting of column base plates will NOT be permitted.
- 3. Splicing of structural steel members is prohibited without prior approval of the Engineer as to location and type of splice to be made. Any member having splice not shown and detailed on shop drawings will be rejected.
- Shop painting: Paint structural steel with one coat of manufacturer's standard red oxide primer applied at a rate to provide a uniform dry film thickness of 2.5 mils.


STRUCTURAL STEEL CONNECTIONS


- Welding shall conform to ANSI/AWS D1.1, latest edition.
- 2. Bolts shall conform to ASTM A325. Bolts shall be designed using values for bearing type bolts with thread allowed in the shear plane.

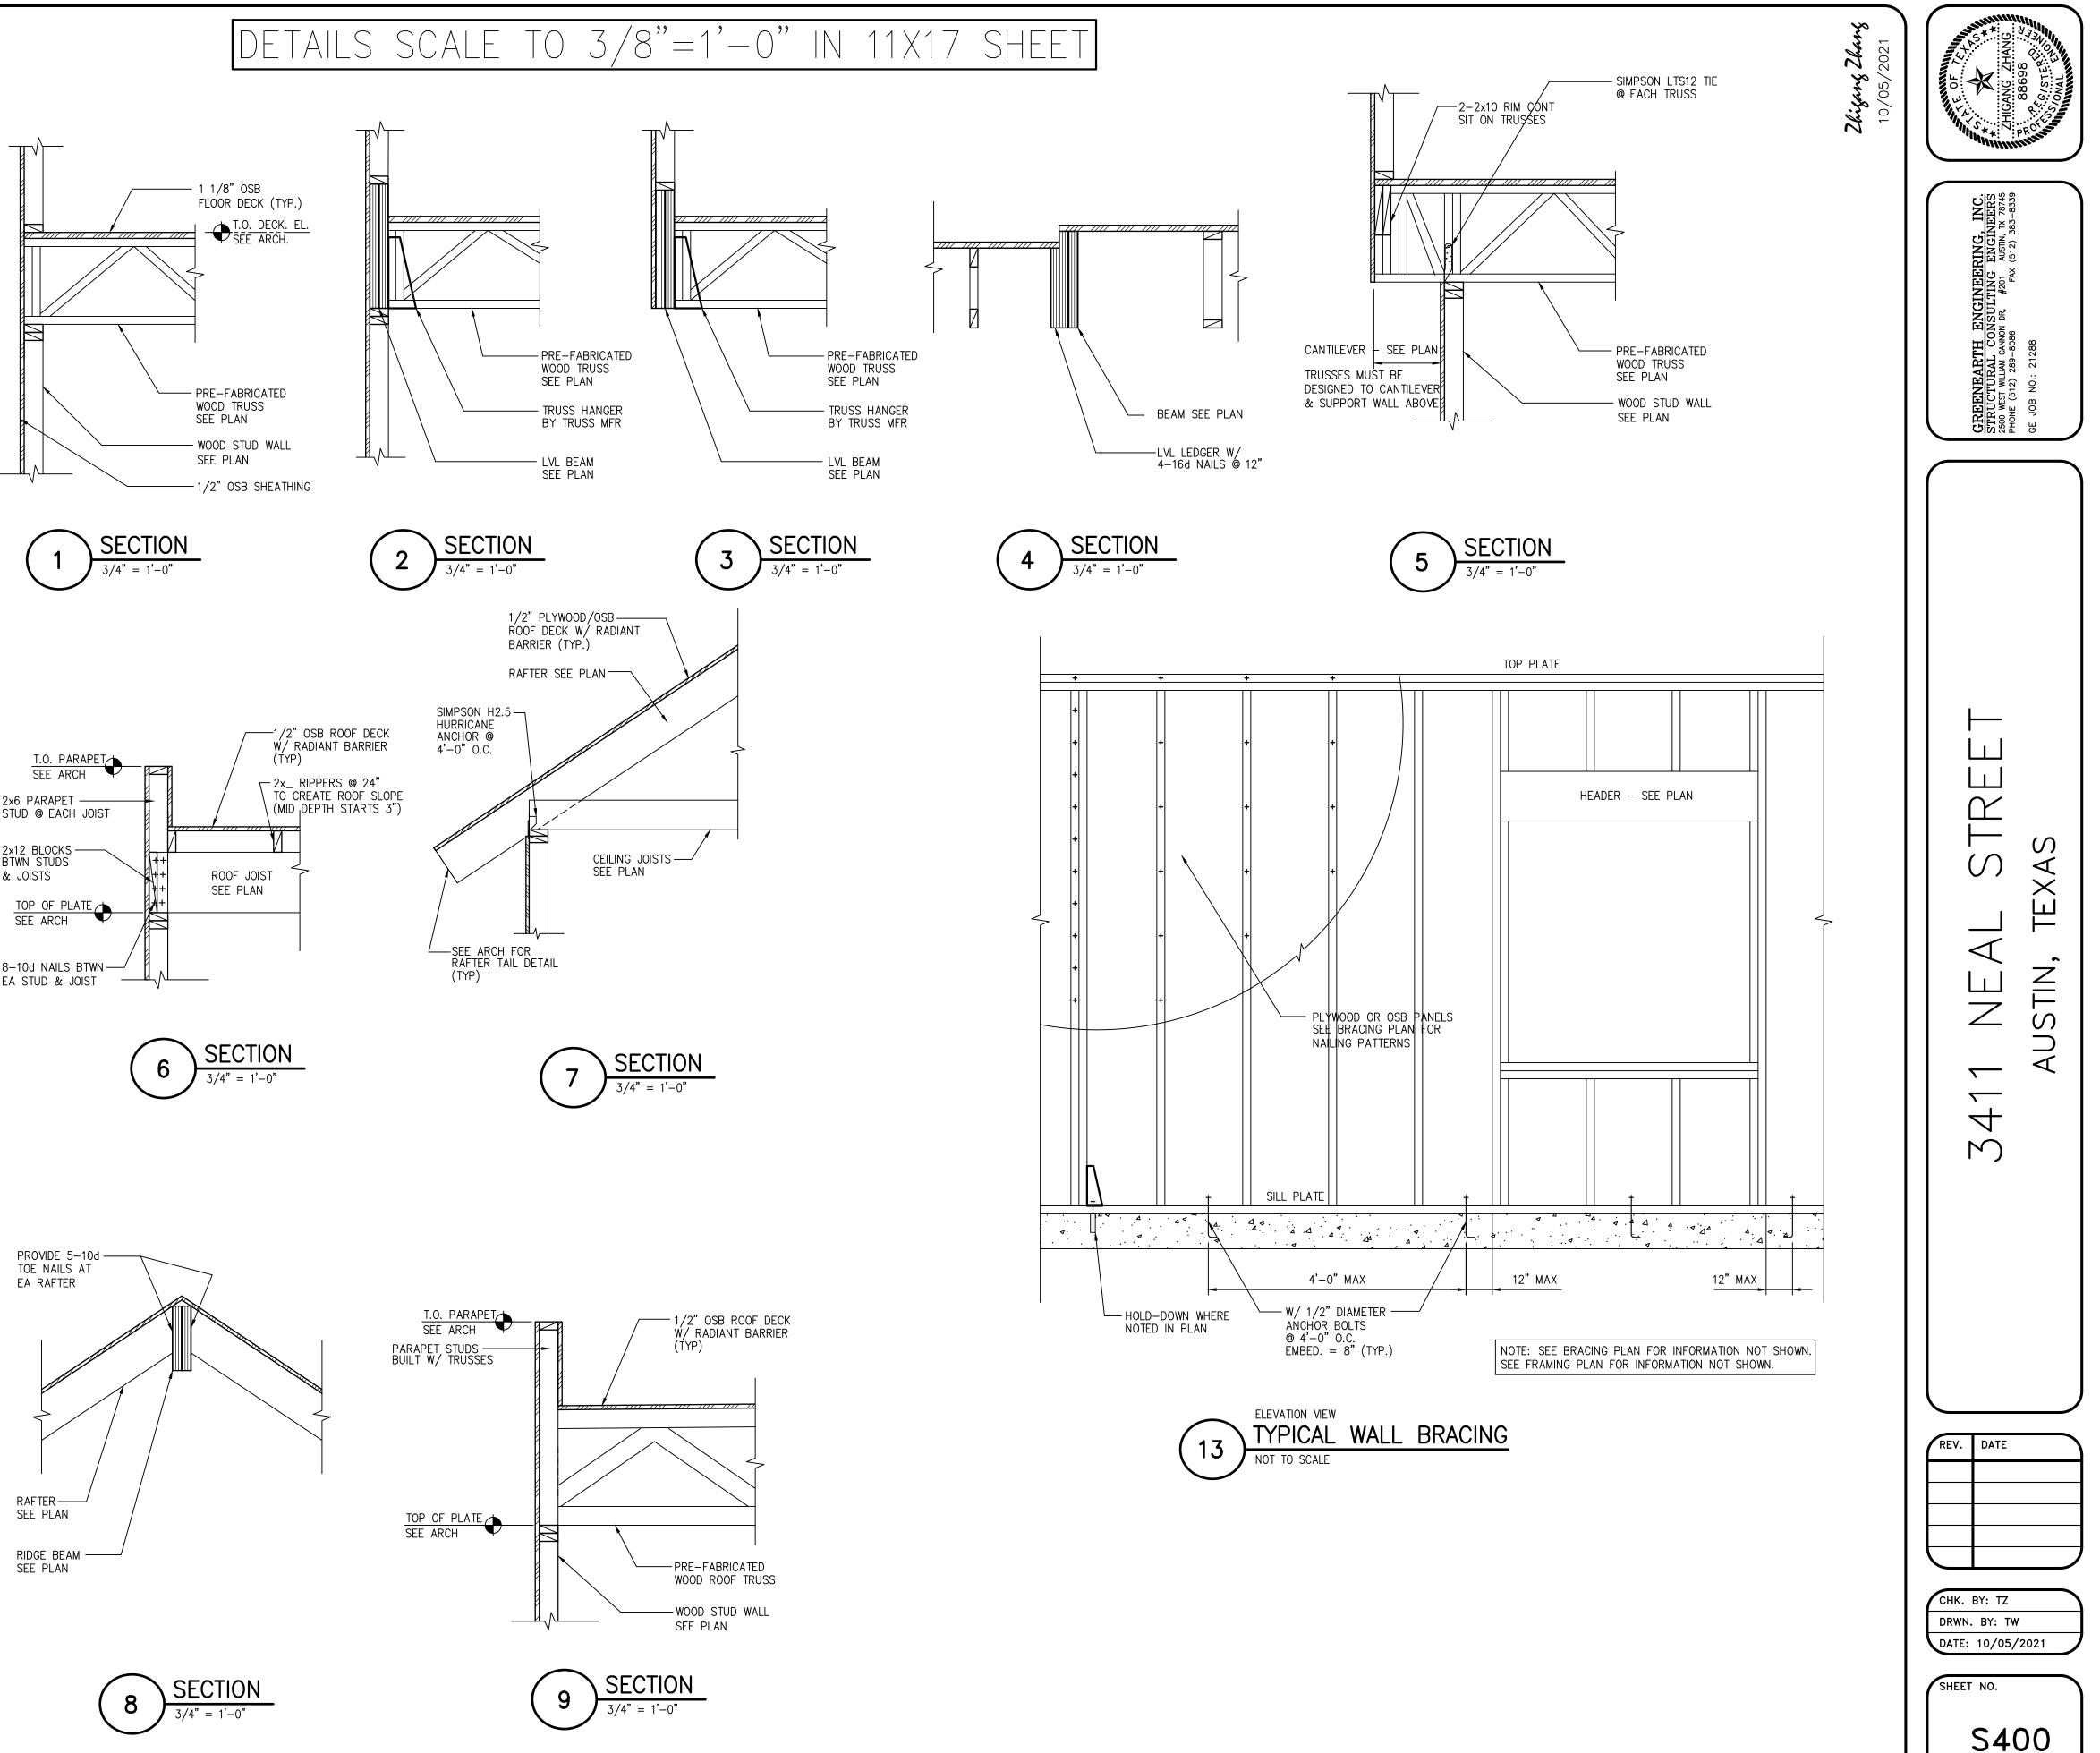

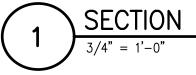


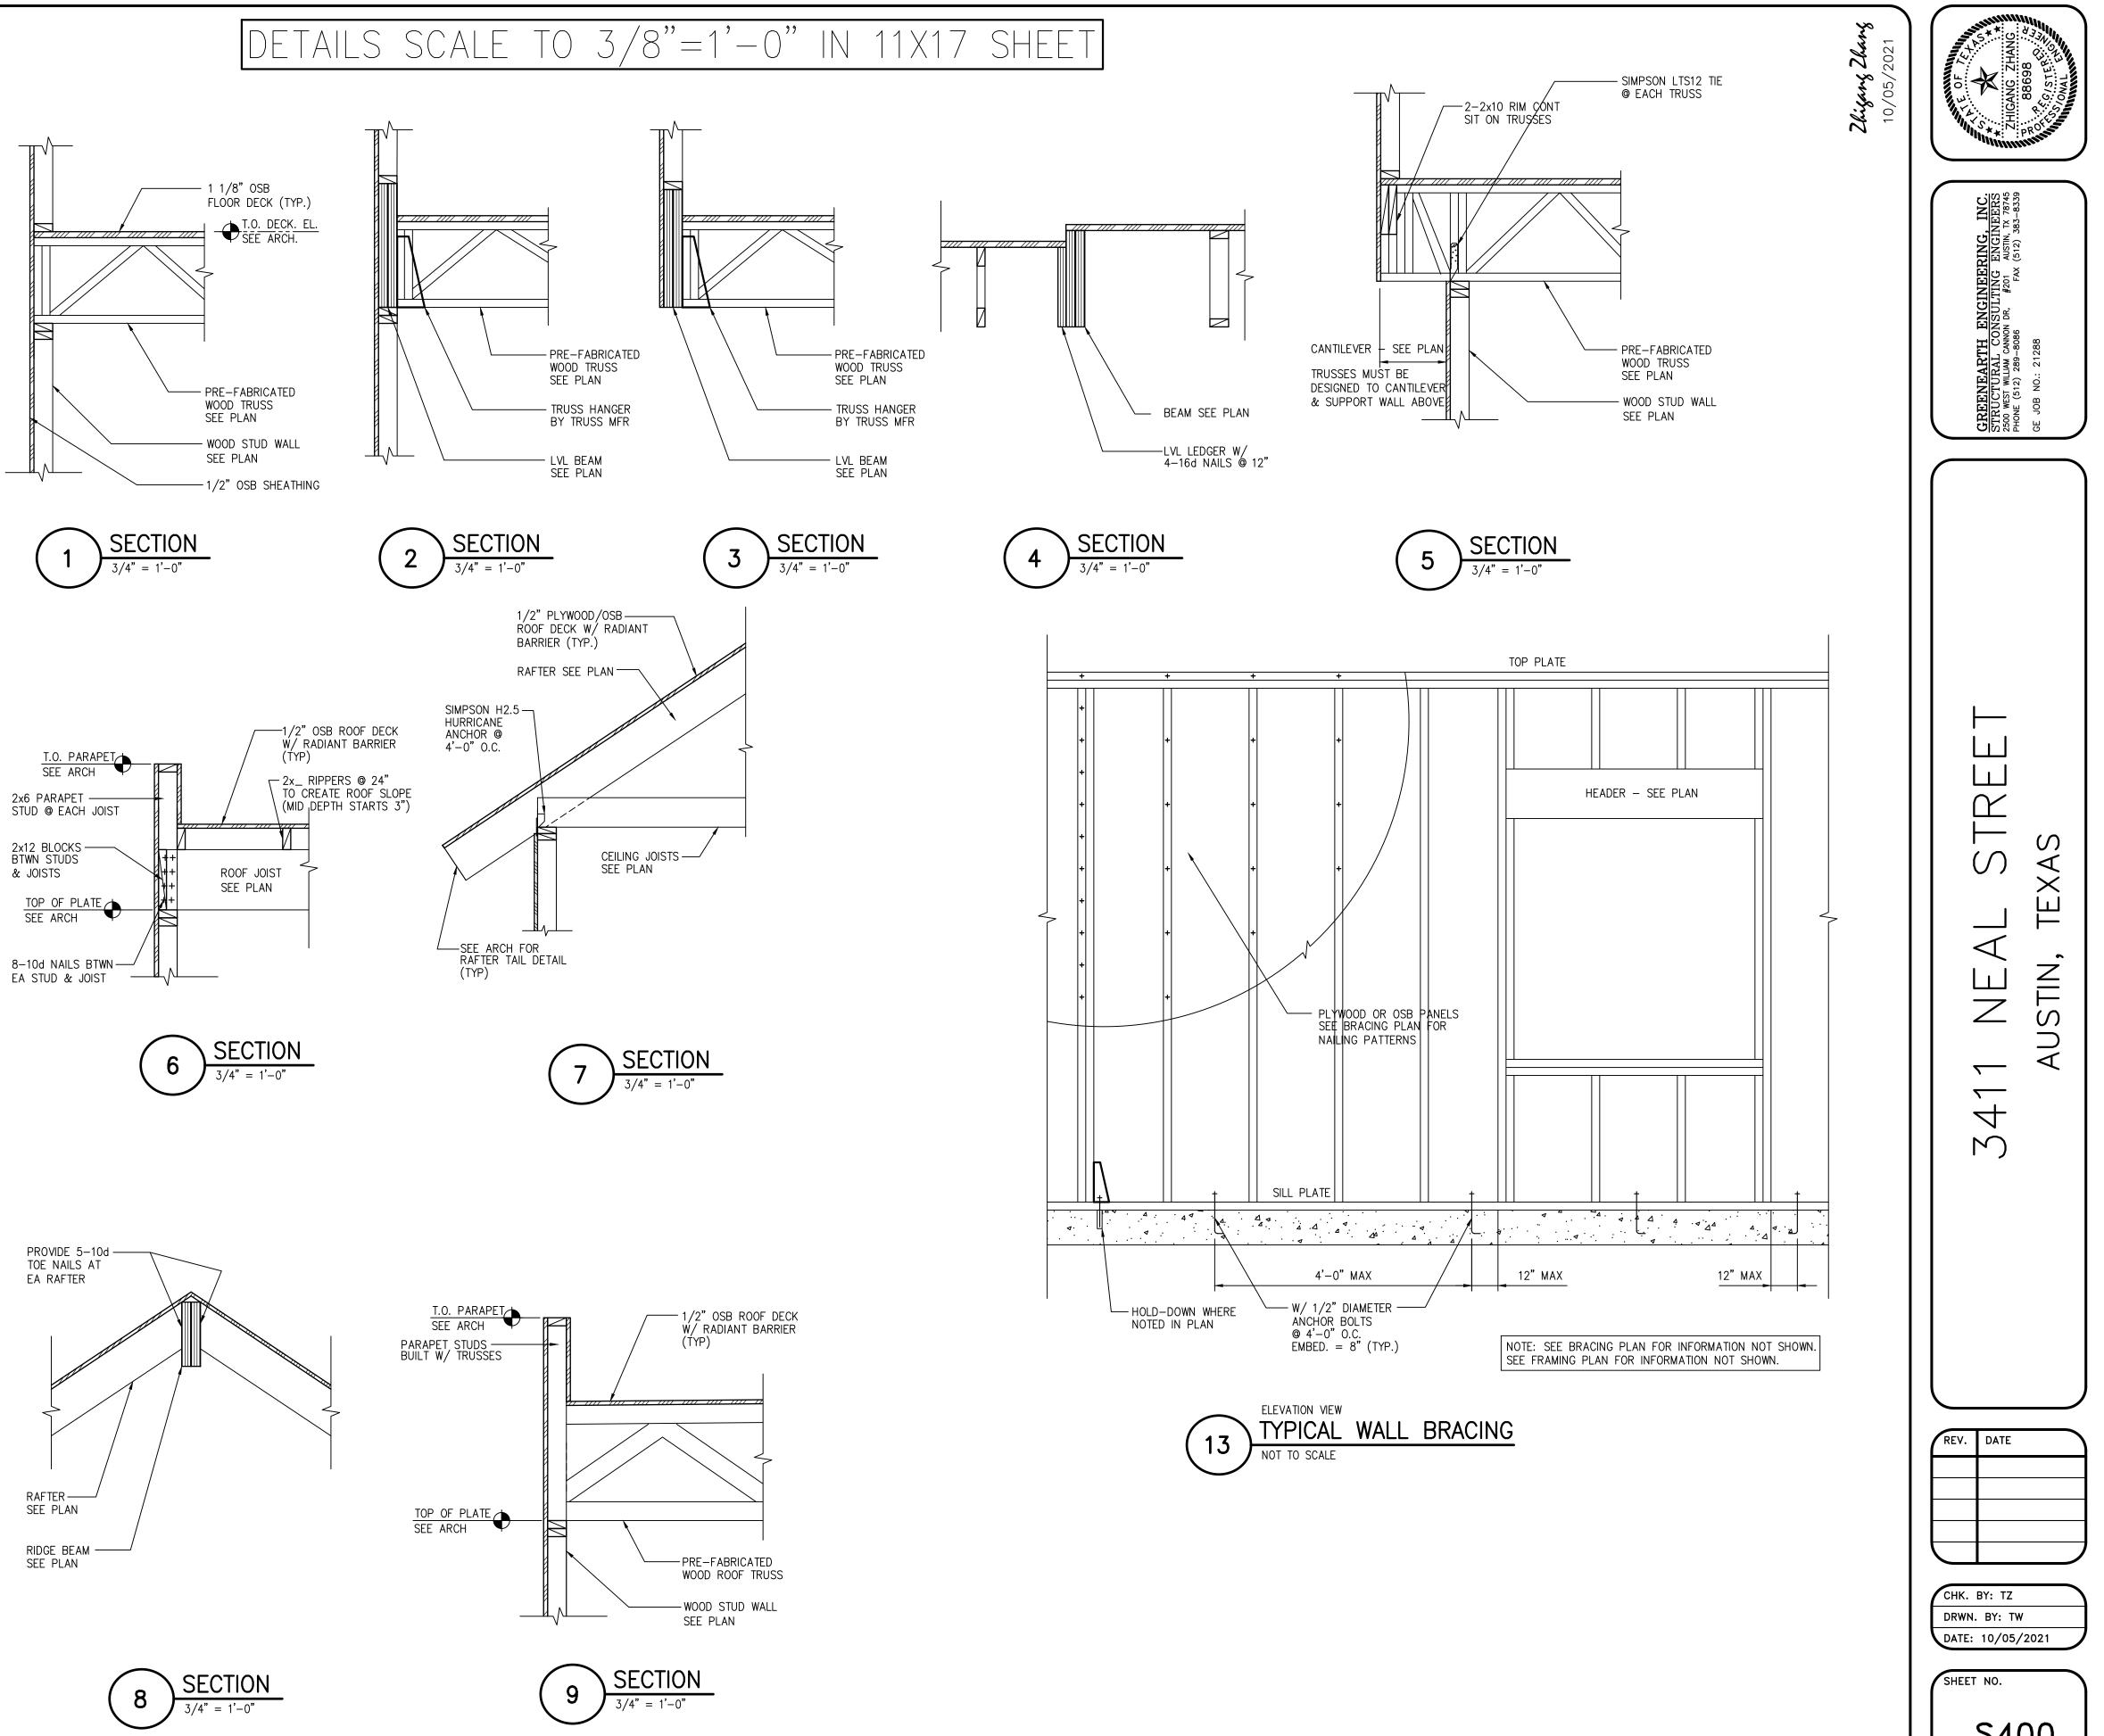

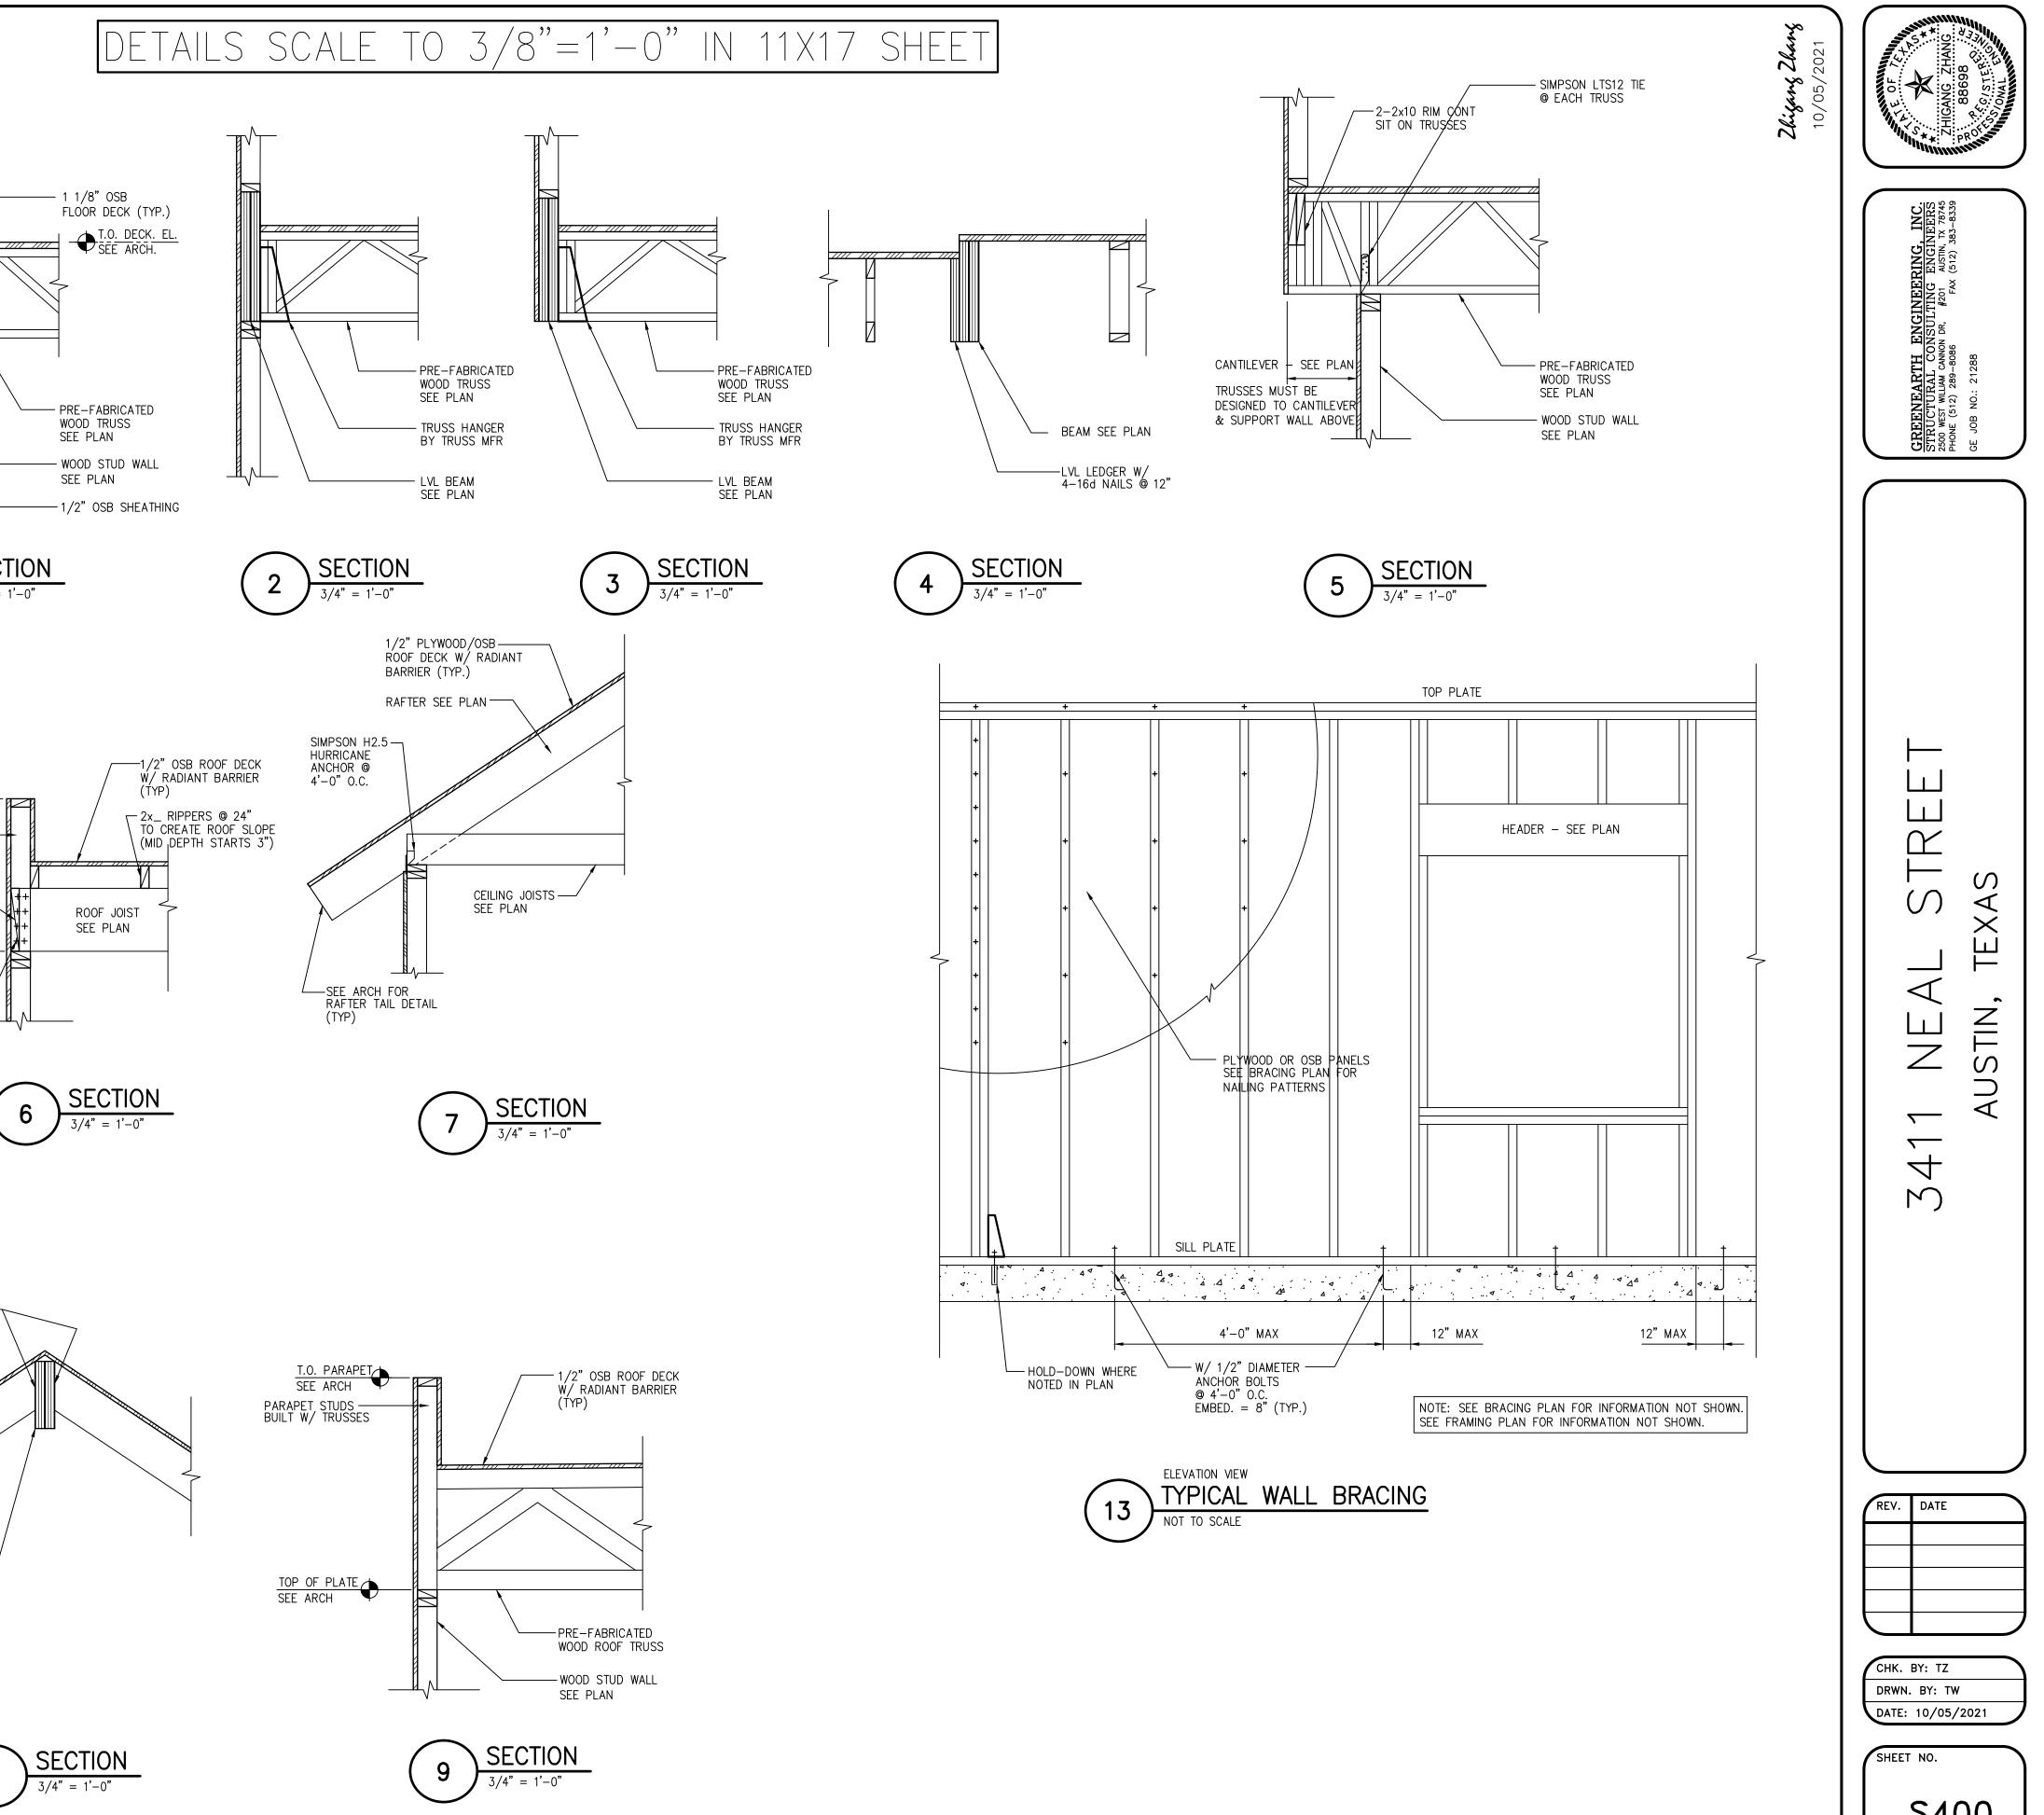

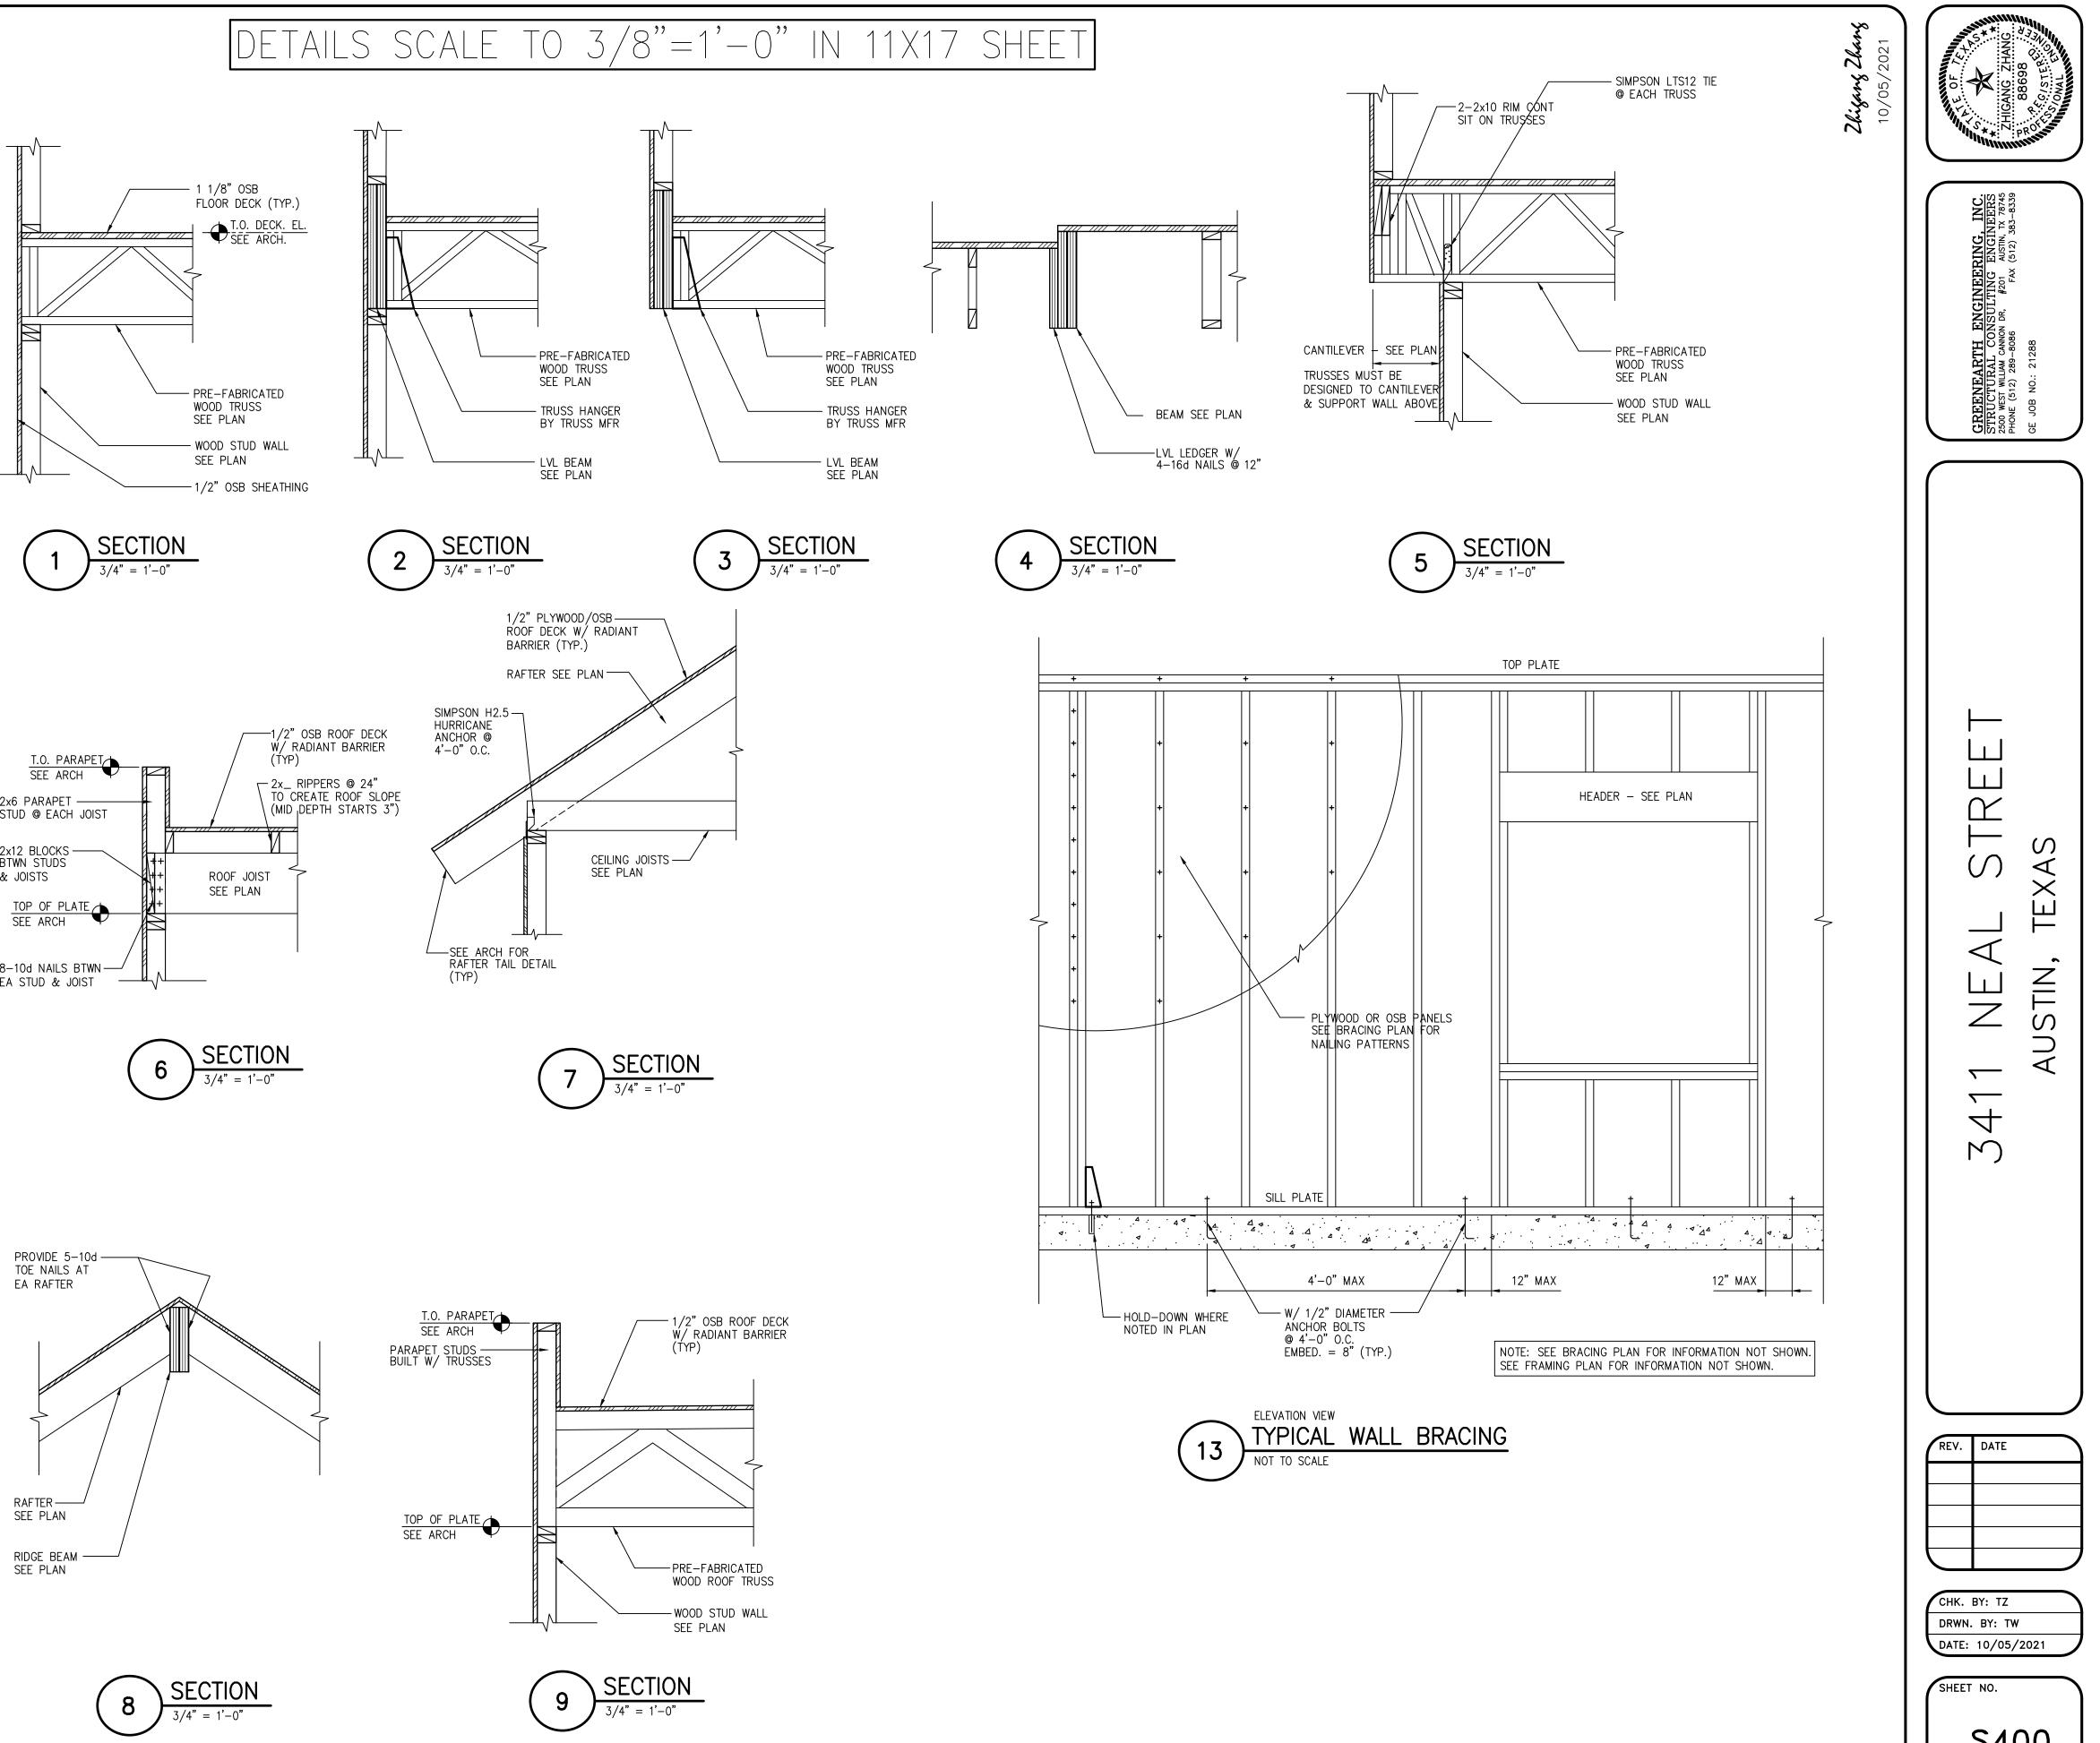



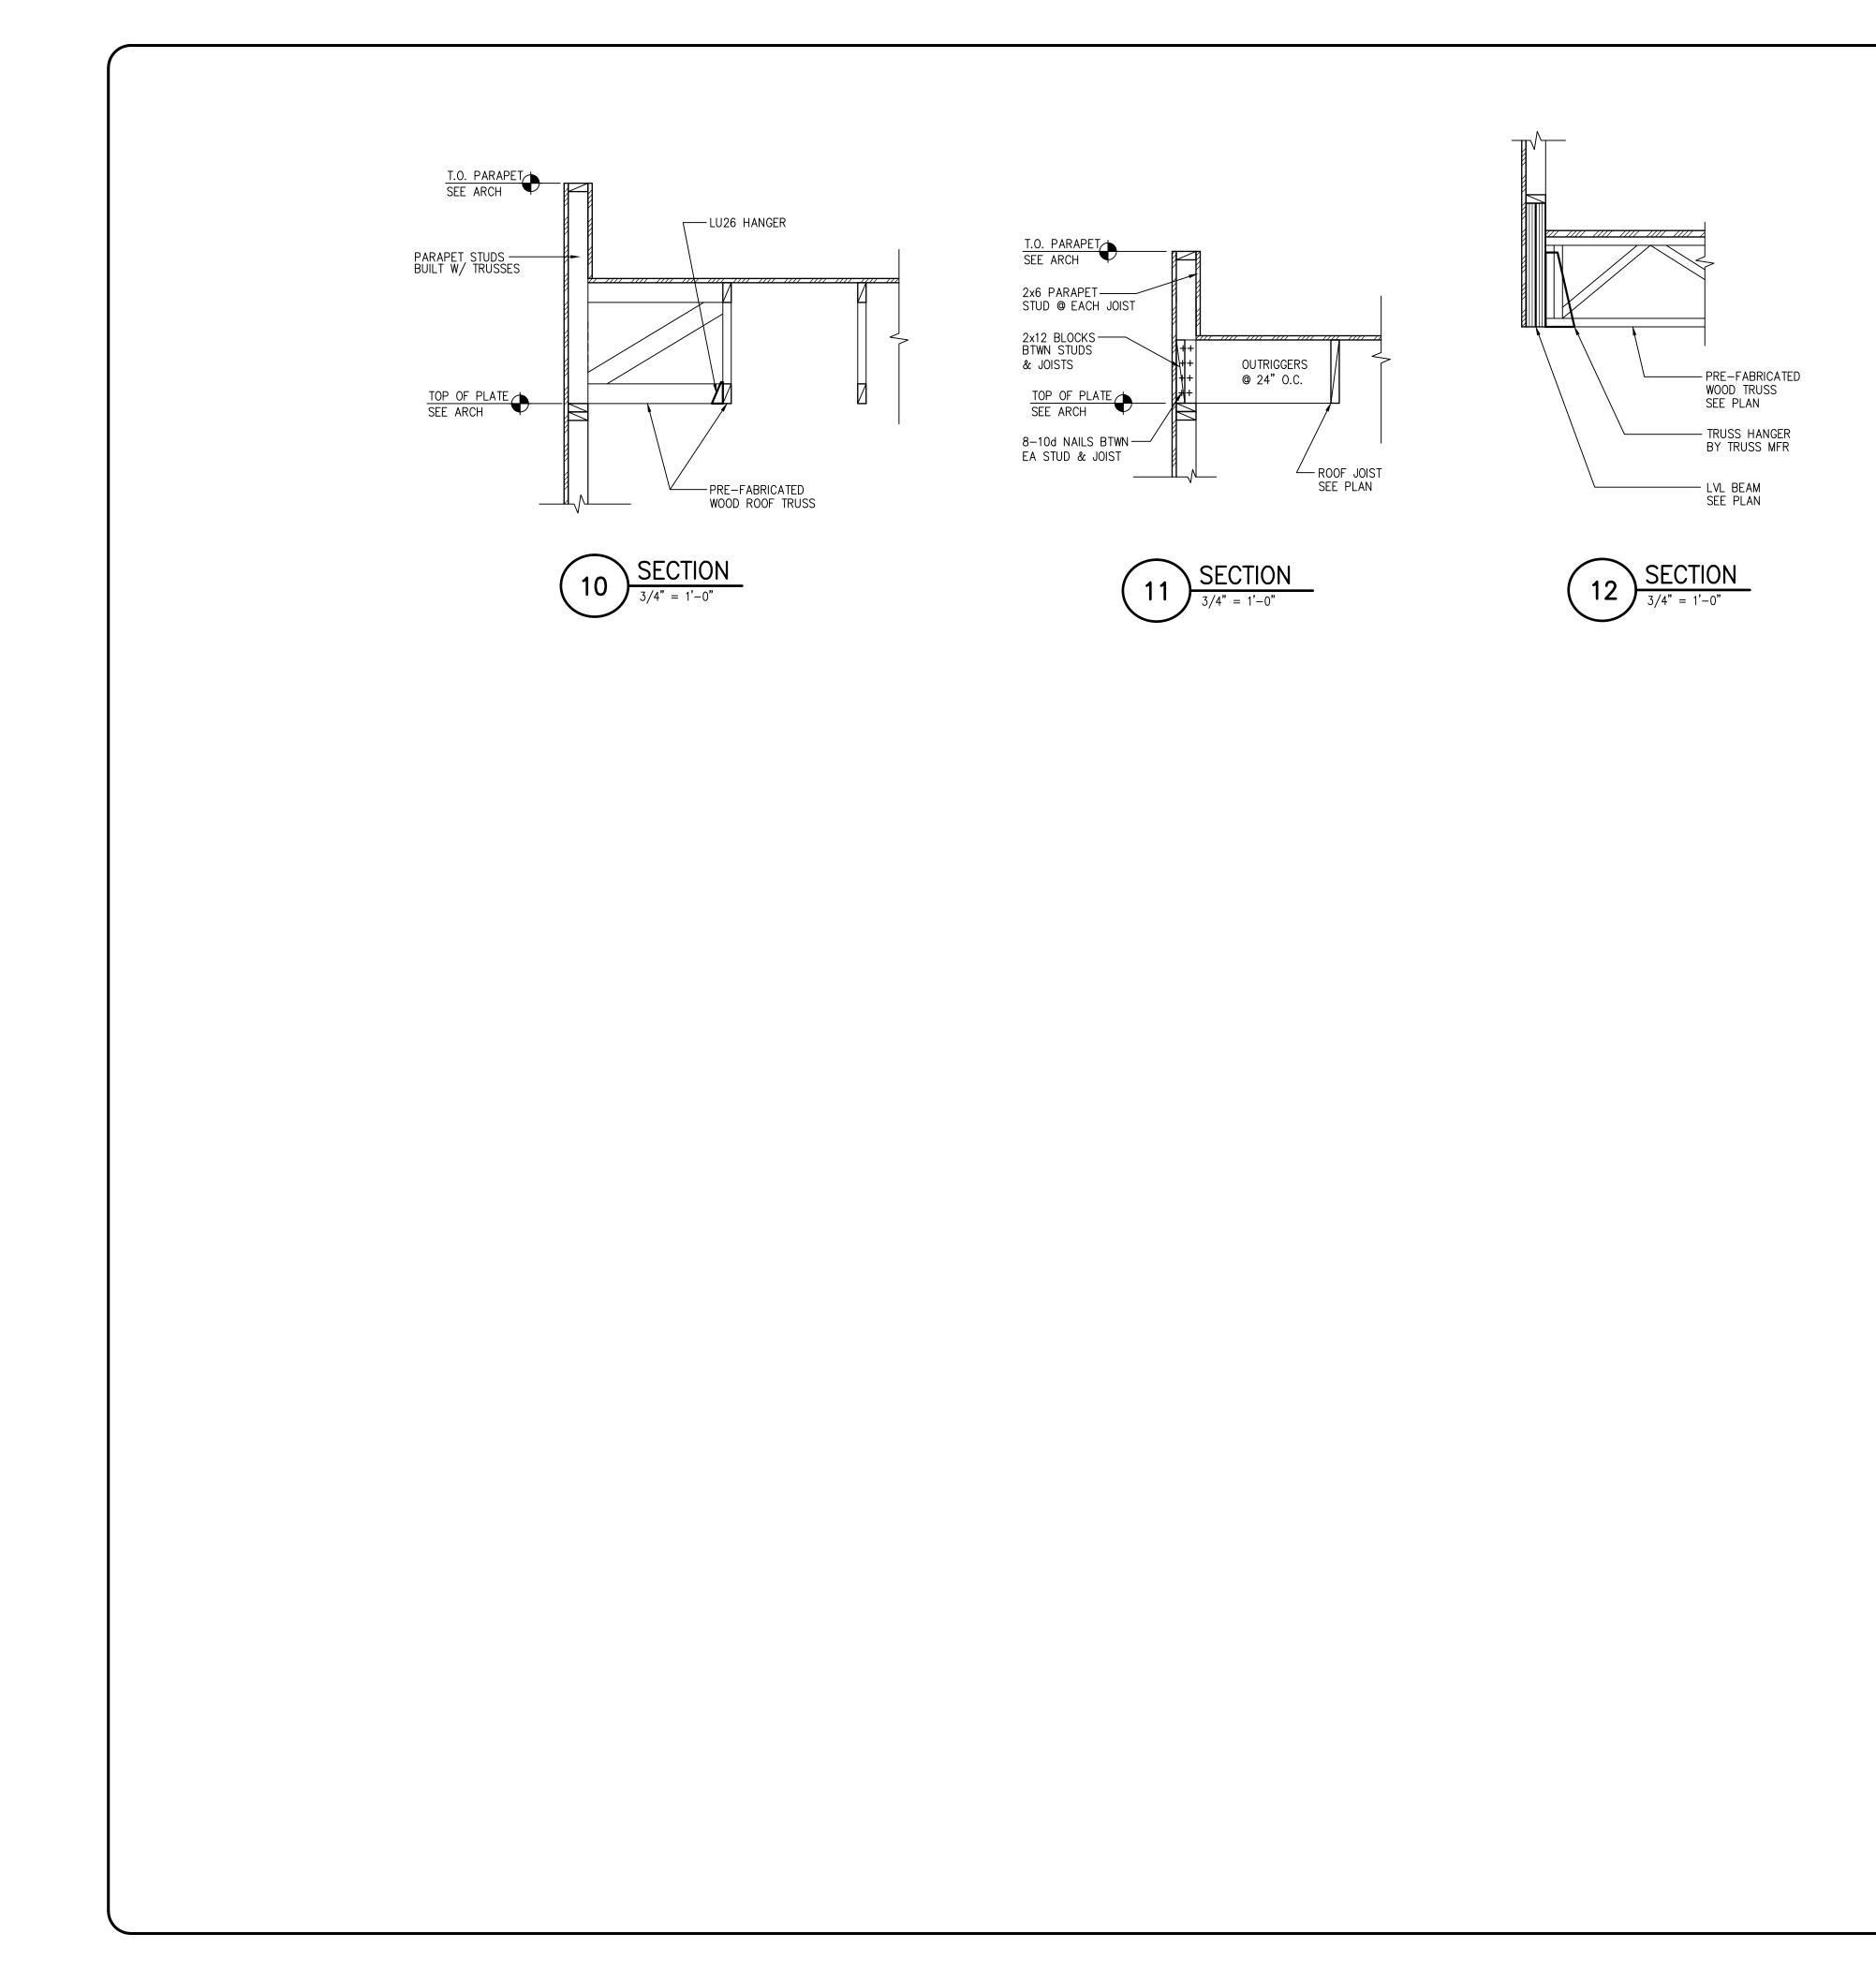

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3411 NEAL STREET AUSTIN, TEXAS
REV. DATE
CHK. BY: TZ DRWN. BY: TW DATE: 10/05/2021
SHEET NO. S401

Zhigang Zhang 10/05/2021