THE US AIRWAYS CLUB PALM BEACH INTERNATIONAL AIRPORT

WEST PALM BEACH, FLORIDA

PGAL

PIERCE GOODWIN ALEXANDER AND LINVILLE

201 NORTH UNION STREET SUITE 500 ALEXANDRIA, VIRGINIA 22314

PROJECT NUMBER

99078

ADDENDUM 2 · RESPONSE TO AIRPORT OPERATIONS COMMENTS

ADDENDUM 1 IUNE 26, 2000

ISSUED FOR BID

IUNE 14, 2000

ISSUED FOR PERMIT MAY 26, 2000

PROGRESS SET

MAY 15, 2000

CS.00

BUILDING CODE ANALYSIS

PROJECT AND DESIGN INFORMATION

PROJECT NAME: US AIRWAYS CLUB PALM BEACH INTERNATIONAL AIRPORT DROJECT ADDRESS PALM BEACH INTERNATIONAL AIRPORT WEST PALM BEACH, FLORIDA DESCRIPTION: AIRLINE CLUB-INTERIOR RENOVATION CODE JURISDICTION-PALM BEACH COUNTY WEST PALM BEACH, FLORIDA

BUILDING CODE + FEDERAL REGULATIONS:

CURRENT ISSUE OF THE FOLLOWING

APPLICABLE CODES

WHERE CODES OR ORDINANCES ARE IN CONFLICT. THE MORE STRINGENT SHALL APPLY

ACCESSIBILITY: ADA: AMERICANS WITH DISABILITIES ACT (1991 /CABO/ ANSI 117.1: ACCESSIBLE AND USABLE BLDGS AND FACILITIES — UBC CHAPTER 11

TYPE OF CONSTRUCTION

CONSTRUCTION TYPE 2B PROTECTED

OCCUPANCY

OCCUPANT LOAD

LOUNGE AND RECEPTION AREAS 1 965 SO FT @ 15 CROSS = 131 OFFICE/SERVICE AREAS

74 SO FT @ 300 GROSS = CALCULATED TOTAL OCCUPANTS = 139

TOTAL NUMBER OF ACTUAL SEATS (RE: A2.01) = 62

NUMBER OF EXITS REQUIRED 2 / 2 PROVIDED

MAXIMUM TRAVEL DISTANCE 200 FEET / MAXIMUM TRAVEL DISTANCE PROPOSED: 85'-8"

FIRE PROTECTION

FULLY SPRINKLERED BUILDING

AUTOMATIC SPRINKLER SYSTEM, AS PER NFPA 13

INDEX OF DRAWINGS

A6.00 ENLARGED RESTROOM PLAN

DETAILS AT RESTROOM


D1.00	DEMOLITION PLAN	A6.03	ENLARGED BAR SUPPORT PLAN
A0.00	GENERAL NOTES & ABBREVIATIONS	A6.04	DETAILS AT BAR
A1.00	FURNISHINGS PLAN	A6.05	DETAILS AT ENTRY
A2.00	PARTITION PLAN	A6.06	DETAILS AT BAR LOUNGE CURTAIN WALL
A2.01	FLOOR PATTERN PLAN	A7.00	DETAILS AT RECEPTION DESK
A3.00	REFLECTED CEILING PLAN	A7.01	DETAILS
A3.01	CEILING DETAILS	A7.02	DETAILS
A3.02	CEILING DETAILS	M-1	SCHEDULES, NOTES, AND LEGENDS.
A3.03	CEILING DETAILS	M-2	DEMOLITION AND NEW WORK FLOOR PLANS
A4.00	DOOR SCHEDULE AND DETAILS	M-3	DETAILS
A4.01	PARTITION TYPES AND DETAILS	E-1	SECOND LEVEL ELECTRICAL SITE PLAN.
A4.02 A4.03	PARTITION DETAILS	E-2	FLOOR PLAN POWER AND SYSTEMS AND LIGHT
	SCHEDULES	E-3	RISER DIAGRAMS SCHEMATICS AND SCHEDUL
A5.00	INTERIOR ELEVATIONS	FP-1	NOTES AND DETAILS
A5.01	INTERIOR ELEVATIONS	FP-2	DEMOLITION AND NEW WORK FLOOR PLANS
AC 00	ENLADOED DECEDOON DIAM	1 1 2	DEMOCRITION AND INCH WORK FLOOR FLAINS


LEGENDS, SCHEDULES, NOTES, DETAILS, RISERS,

DEMOLITION, NEW WORK PLUMBING FL. PLANS

CS.00 COVER SHEET/KEY PLAN/CODE ANALYSIS A6.02 ENLARGED PLAN AT WORK CARRELS

KEY PLAN 2 ND. LEVEL FLOOR PLAN

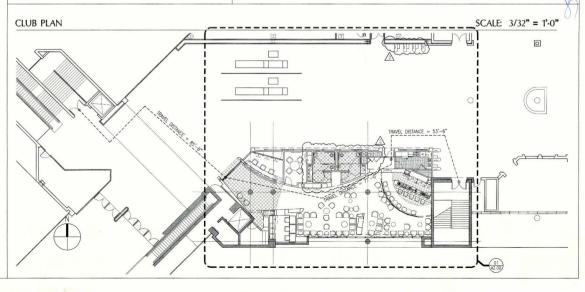

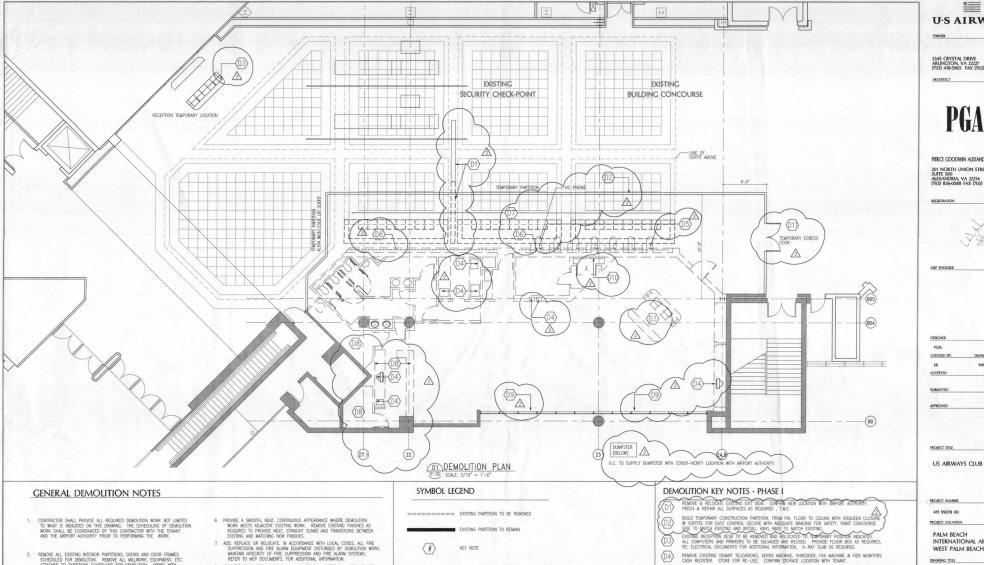

- REMOVE ALL EXISTING INTERIOR PARTITIONS, DOORS AND DOOR FRAMES SCHEDULED FOR DEMOLITION. REMOVE ALL MILLWORK, EQUIPMENT, ETC. ATTACHED TO PARTITIONS SCHEDULED FOR DEMOLITION. VERIFY WITH TENANT WHICH ITEMS ARE TO BE SAVED AND STORED FOR REUSE, PROOR TO COMMENCEMENT OF ACTIVITIES.
- REMOVE EXISTING ELECTRICAL DEVICES, OUTLETS, TELEPHONE AND DATA NEMOWS EXISTING ELECTRICAL DEVICES, OUTLETS, TELEPHONE AND DATA ADOCS AND THERMOSISTS IN PARTITIONS SCHEDULED FOR DEMOLITION ON, THE REQUIRED, TERMOSISTS IN PARTITIONS SCHEDULED FOR DEMOLITION ON, FOR EXPENDING DETAILS WITHOUT AND THE PARTITION OF THE PARTITION
- REMOVE ALL CONSTRUCTION DEBRIS FROM AREA AND DISPOSE OF IN A LAWFILL MANNER. ALL REMOVAL OF DEBRIS FROM THE TEMANT SPACE MUST OCCUR AFTER AIRPORT OPERATIONAL HOURS AND BE COORDINATED WITH THE AIRPORT AUTHORITY.

- RECURRED DEMOUTION WORK SHALL INCLUDE ALL NECESSARY WORK TO BE GENARD OF THIS COMMISCION FITTER VARIES THE STEEP OF THE BODING. GENARD OF THE STEEP OF THE STEE
- REMOVE ALL EXISTING FLOOR FINISHES. PREPARE EXISTING SLAB TO RECEIVE NEW FINISH, AS INDICATED IN THE FINISH SCHEDULE.
- REMOVE ALL WALL COVERINGS AND CERAMIC TILE FROM PARTITIONS TO REMAIN. PREPARE WALL SURFACES TO RECEIVE NEW FINISH.
- REMOVE ALL EXISTING CEILUNG FINISHES & FOXTURES. LIGHT FIXTURES & EQUIPMENT NOT REQUIRED FOR NEW CONSTRUCTION ARE TO BE STORED FOR FUTURE USE.
- 12. BELVICE ALL PLUMBING FIXTURES. MODRY EXISTING UTLITIES AS REQUIRED BY MAY CONSTRUCTION IN NOT REQUIRED. DO'L MICE'S AS REQUIRED.

 13. GENERAL, CONTRICTION TO PROVISE UMANS FOR DUTLITO CONTROL, DURNING DEMOLITION, TO PROVISIT DUST AND DEBRI FROM ENTERING BUILDING & HANCE STISTLING. RETURN ALL HONEYWELL TEMPERATURE SENSORS NOT REINSTALLED TO THE DEPARTMENT OF AIRPORTS.
- ALL HAZ CONTROLS TO BE DISCONNECTED OR REMOVED, SHALL BE COORDINATE
 WITH THE DEPARTMENT OF AIRPORTS MAINTENANCE DEPT PRIOR TO DEMOLITION
 NO CONTROLS SHALL BE REMOVED OR DISCONNECTED WHILE ENERGIZED.



CONSTRUCTION PHASING

(1) RELOCATE EXISTING SIGNAGE AT BUILDING CONCOURSE: SEE DEMO NOTE "D1" 2) BUILD TEMPORARY CONSTRUCTION PARTITION, SEE DEMO NOTE "D2" 3) COMMERCE DEMOLITION AS INDICATED DRIP PARASE 1.

1) BUILD NEW IDMINING PARTITION AS INDICATED ON A2 DO.

2) RECONSTRUCT EXISTING LIGHT SOFFIT @ CONCOURSE TO ALIGN WITH THE EXISTING AS INDICATED ON A3.00.

3) INSTALL ILLUMINATED ADVERTISEMENT BOARDS @ NEW DEMISING PARTITION CONFIRM LOCATION W/AIRPORT AUTHORITY.

4) INSTALL EXISTING PAY PHONES AT NEW LOCATION AS INDICATED ON DRAWING A2.00 CONFIRM LOCATION W/ AIRPORT AUTHORITY.

5) REMOVE TEMPORARY CONSTRUCTION PARTITION.

PHSE II - COMPLETE REMANDER OF GENOLITION & CONSTRUCTION OF INTEROR.

(NOTE: IN GREET TO MAINTAIN ARPORT SECURITY, DOOR OI 0 ENTRY 100 SHOULD BE OPERABLE
(NOTE) THE LUST STREET OF CONSTRUCTION. ABSOLUTELY NO ACCESS SHALL BE ALOWED THRU
THIS DOOR DURING THE CONSTRUCTION PERSON.

- (D4) REMOVE EXISTING TENANT TELEVISIONS, XEROX MACHINE, SHREDDER, FAX MACHINE & FIDS MONITORS CASH REGISTER. STORE FOR RE-USE. CONFIRM STORAGE LOCATION WITH TENANT.
- EXISTING PAY PHONES TO BE RELOCATED. MODIFY EXISTING UTILITIES AS REQUIRED. CAREFUL REMOVAL, STORAGE AND REINSTALLATION IS REQUIRED. VERIFY LOCATION WITH AIRPORT AUTHORITY. SEE SHEET ALOO FOR NEW LOCATION. (D5)
- EXISTING ILLUMINATED ADVERTISEMENT BOARDS, TO BE RELOCATED. MODIFY EXISTING UTILITIES AS REQUIRED. CAREFUL REMOVAL, STORAGE AND REINSTALLATION IS REQUIRED. VERIFY LOCATION WITH AIRPORT AUTHORITY. SEE DTL 8/AS.01 FOR NEW LOCATION.
- EXISTING SOFFIT LIGHT FIXTURES SPRINKLERS & SPEAKERS TO BE REMOVED AND RELOCATED. CONSTRUCT NEW SOFFIT TO ALLON WITH EXISTING AS INDICATED ON SWEET A3.00. MODIFY EXISTING UTILITIES AS REQUIRED. CAREFUL REMOVAL, STORAGE AND REINSTALLATION IS REQUIRED. REPAIR ALL FINISHES TO MATCH EXISTING.

DEMOLITION KEY NOTES - PHASE III

- D8 REMOVE EXISTING EQUIPMENT AT BAR, AND BAR SUPPORT, PATCH EXISTING SLAB AS REQUIRED. VERIEY WITH TENANT WHICH ITEMS ARE TO BE SAVED AND STORED FOR REUSE.
- (D9) REMOVE EXISTING WINDOW TREATMENT. CLEAN EXISTING GLASS.
- EXISTING ELECTRICAL PANELS TO BE RELOCATED REFER TO MEP DOCUMENTS FOR FURTHER

PROVIDE ONE KEY TO AIRPORT OPERATIONS, FOR ACCESS TO TEMPORARY DOOR. A.....



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TNF

INTERNATIONAL AIRPORT WEST PALM BEACH, FLORIDA

DEMOLITION PLAN

DRAWING SCALE

AS INDICATED REVISION DATES

ADDENDUM 2 06.29.00 ADDENDUM 1 06.26.00 ISSUED FOR BID 06.14.00

ISSUE DATE

ISSUED FOR PERMIT 05.26.00

D1.00

GENERAL CONSTRUCTION NOTES

- THE CONTRACT DOCUMENTS INCLUDE THE WORKING DRAWINGS, ADDENDA MODIFICATIONS, GENERAL CONDITIONS OF THE CONSTRUCTION CONTRACT AND SPECIFICATIONS.
- THE CONTRACT DOCUMENTS ARE INSTRUMENTS OF SERVICE AND SHALL REMAIN THE PROPERTY OF THE ARCHITECT WHETHER THE PROJECT FOR WHICH THEY ARE PREPARED IS EXECUTED OR NOT. THE CONTRACT DOCUMENTS SHALL NOT BE USED BY OWNER OR TENANT FOR OTHER PROJECTS OR EXTENSIONS TO THE PROJECT FOR A REA THEY TO BE MODIFIED IN ANY MANNER WHATSOEVER EXCEPT BY AGREEMENT IN WRITING WITH THE ARCHITECT.
- ALL WORK SHALL CONFORM TO THE REQUIREMENTS OF ALL CODES AND REGULATIONS OF ALL GOVERNMENTAL AUTHORITIES HAWING JURISDICTION. SOLIC CODES AND REGULATIONS SHALL HAVE PRECEDENCE OVER THAT WHICH DISCREPANCIES, OMISSIONS, CHANGES IN THE CODES OF CODE INTERPRETATIONS BY CODE OFFICIALS WHICH CAUSE A CHANGE IN THE WORK, NOTIFY THE ARCHITECT PRIOR TO PROCEEDING WITH THAT PORTION OF THE WORK AFFECTED BY THE CHANGE.
- 4. "FURNISH" MEANS SUPPLY ONLY FOR OTHERS TO PUT IN PLACE.
- "PROVIDE" MEANS FURNISH AND INSTALL, COMPLETE AND IN PLACE.
- "SIMILAR" MEANS COMPARABLE CHARACTERISTICS FOR CONDITIONS NOTED. CONTRACTOR TO VERIFY DIMENSIONS AND ORIENTATION.
- "TYPICAL" MEANS IDENTICAL FOR CONDITIONS NOTED
- IN THE EVENT OF CONFLICT BETWEEN DATA SHOWN ON DRAWINGS AND DATA SHOWN ON THE SPECIFICATIONS, THE SPECIFICATIONS SHALL COVERN. DIMENSIONS NOTICE ON DRAWINGS SHALL FOR PRECEDENCE CHES GALED DIMENSIONS NOTICE ON THE STATE OF THE SPECIFICATION OF A SMALLER SCALE. SHOULD THE CONTRACTOR AT ANY TIME DISCOVER AN ERROR IN A DRAWING OR SPECIFICATION OF A DISCREPANCY OR VARIATION BETWEEN DIMENSIONS OR OTHER INFORMATION, HE SHALL, NOT PROCEED WITH THE WORK AFFECTED UNTIL CLAFFICATION HAS BEEN MADE BY THE ARCHITECT
- HORIZONTAL DIMENSIONS INDICATED ARE TO/FROM FINISHED FACE OF CONSTRUCTION, EXCEPT AS NOTED.
- VERTICAL DIMENSIONS ARE FROM TOP OF FLOOR SLAB, EXCEPT WHERE NOTED TO BE FROM ABOVE FINISHED FLOOR (AFF).
- 11. DIMENSIONS ARE NOT ADJUSTABLE WITHOUT APPROVAL OF ARCHITECT UNLESS NOTED (±).
- THE FINISHED WORK SHALL BE FIRM, WELL ANCHORED, IN TRUE ALIGNMENT, PLUMB, LEVEL, WITH SMOOTH, CLEAN, LUNFORM APPEARANCE WITHOUT WAYS, DISTORDINS, HOLES, MARKS, ORDINS, STANS OR DISCOLORATION, JOINTS SHALL BE CLOSE FITTIND, NEAT AND WELL SCRIBED. THE FINISH SHALL BOT PRESENT HEAZMOODS, INDIATE CORNERS ALL WORK SHALL HAVE PROVISION FOR PARISHON, CONTROL ON SHARMOOD AND SHRINWARE AS RESEARCH TO TRUTHER WAY THE PRESENT GRACES, BUCKLING AND MARPING DUE TO TEMPERATURE AND HUMBHOT!
- CUT AND FIT COMPONENTS FOR ALTERATIONS OF EXISTING WORK AND INSTALLATION OR NEW WORK. PATCH DISTURBED AREAS TO MATCH ADJACENT MATERIALS AND FINISHES IN EVERY RESPECT.
- PATCH AND REPAIR ALL FIRESTOP DAMAGED OR REMOVED DURING PERFORMANCE OF THE WORK. FIREPROOF NEW PENETRATIONS REQUIRED BY THE WORK.
- COORDINATE AND PROVIDE BLOCKING/BACKING IN PARTITIONS BEHIND ALL WALL-MOUNTED ITEMS. ALL CONCEALED WOOD TO BE FIRE-TREATED.
- MAKE ALL NECESSARY PROVISIONS FOR ITEMS TO BE FURNISHED OR INSTALLED BY TEMANT. PROVIDE PROTECTION FOR THESE PROVISIONS UNTIL COMPLETION OF THE PROJECT. GENERAL CONTRACTOR TO COORDINATE IDENTIFIED N.I.C. ITEMS WITH APPROPENIE TRADES, OR TEMANT'S
- GENERAL CONTRACTOR SHALL REVIEW THE BASE BUILDING CONTRACT DOCUMENTS OR EXISTING BASE BUILDING CONDITIONS AND SHALL COMPLY WITH ALL BASE BUILDING REQUIREMENTS AND DESIGN CRITERIA


- 18. GENERAL CONTRACTOR SHALL BE RESPONSIBLE FOR CHECKING CONTRACT DOCUMENTS, FIELD CONDITIONS AND DIMENSIONS FOR ACCURACY AND CONFIRMING THAT WORK IS BUILDABLE AS SHOWN BEFORE PROCEEDING WITH CONSTRUCTION. CLARIFICATIONS REGARDING ANY CONFLICTS SHALL BE ACHEVED PRIOR TO RELATED WORK BEING STAMTED.
- 19. GENERAL CONTRACTOR SHALL VERIFY THAT NO CONFLICTS EXIST IN LOCATIONS OF ANY AND ALL MECHANICAL, TELEPHONE, ELECTRICAL, PLUMBING AND SPRINKLER COUPMENT (TO INCLUDE ALL PIPING, DUCTYONER AND CONDUIT) AND THAT ALL REQUIRED CLEARANCES FOR INSTALLATION AND MAINTENANCE OF ABOVE USED EQUIPMENT ARE PROVIDED. ELEMENTS TO BE EXPOSED OR CONCEALED SHALL BE DETERMINED AND REVIEWED WITH AGCHIECT PRIOR TO CONSTRUCTION PROCEEDING.
- GENERAL CONTRACTOR AND SUBCONTRACTORS SHALL COORDINATE THE LAYOUT AND EXACT LOCATION OF ALL PARTITIONS, DOORS, ELECTRICAL/TELEPHONE/DATA OUTLETS, LIGHT SWITCHES AND ACCESS PANELS WITH ARCHITECT IN THE FIELD BEFORE PROCEEDING WITH CONSTRUCTION.
- GENERAL CONTRACTOR IS RESPONSIBLE FOR AND SHALL PROVIDE PROTECTION FOR ALL EXISTING FINISHES INCLUDING ELEVATORS, LOBBIES AND CORRIDORS OF THE BASE BUILDING. ANY REPAIR TO EXISTING AREAS ARE NOT PART OF THIS PROJECT OR CONTRACT UNLESS OTHERWISE NOTED.
- 22. SUBMIT SHOP DRAWINGS AND SAMPLES FOR ALL TRADES WITHIN 10 DAYS FROM CONTRACT DATE. TO THE ARCHITECT, ALLOWING TEN (10) WORKING DAYS FOR REVIEW. NO CONSTRUCTION SHALL PROCEED UNITL THE SHOP DRAWING APPROVAL FOR ANY PRODUCT HAS BEEN APPROVED BY THE ARCHITECT. ALL TRADES SHALL BE REVIEWED BY THE ARCHITECT AT THE SAME THE. CONTRACTOR SHALL PROVIDE MANUFACTURER'S SPECIFICATION, INSTALLATION INSTRUCTION, SHOP DRAWINGS AND SAMPLES FOR REVIEW AND APPROVAL OF ALL MATERIALS AND METHODS TO BE USED PRIOR TO ORDERING OR PROCECIONS WITH THE WORK. CONTRACT DOCUMENTS, CONTRACT DOCUMENTS, CONTRACT DOCUMENTS, CONTRACT TO CHARLETS, CONTRACT TO THE OWNERS AND AMPLES AND METHODS TO BE WELLD TO THE OWNERS AND AMPLES AND THE ARCHITECT IN WRITING, IMMEDIATELY TO RESOLVE DISCREPANCES PRIOR TO PROCEEDING.
- EXERCISE EXTREME CARE AND PRECAUTION DURING CONSTRUCTION OF THE WORK TO MIMIMIZE DISTURBANCES TO ADJACENT TENANTS AND THEIR OCCUPANTS PROPERTY, PUBLIC THOROUGHARES, ETC. CONTRACTOR SHALL TAKE PRECAUTIONS AND BE RESPONSIBLE FOR THE SAFETY OF ALL BUILDING OCCUPANTS FROM CONSTRUCTION PROCEDURES.
- ATTACHMENTS, CONNECTIONS OR FASTENINGS OF ANY NATURE ARE TO BE PROPERLY AND PERMAMENTLY SECURED IN CONFORMANCE WITH BEST PRACTICE AND THE CONTRACTOR IS RESPONSIBLE FOR IMPROVING THEM ACCORDINGLY AND TO THESE CONDITIONS. THE DRAWINGS SHOW ONLY GENERAL CONDITIONS TO ASSIST CONTRACTOR. THEY DO NOT LIQUISTRATE NOR ARE THEY INTENDED TO SUGGEST EVERY SUCH DETAIL REQUIRED TO PERFORM THE WORK.
- THE CONTRACTOR SHALL CONTINUOUSLY CHECK ARCHITECTURAL AND STRUCTURAL CLEARANCES FOR ACCESSIBILITY OF EQUIPMENTS AND MECHANICAL AND ELECTRICAL SYSTEMS. NO ALLOWANCE OF ANY KIND WILL BE MADE FOR THE CONTRACTOR'S NEGLIGENCE TO FORSEE MEANS OF INSTALLING EQUIPMENT INTO POSITION INSDE STRUCTURES.

ACCESS TO THE CUSTOMS SPACE BELOW, MUST BE COORDINATED IN ADVANCE WITH AIRPORT OPERATIONS, CENERAL CONTRACTOR SHALL PROVIDE PROTECTION FOR ALL EXISTING FINISHES. ALL SURFACES ARE TO REPAIRED AS REQUIRED T.M.E.

- ONLY NEW ITEMS OF RECENT MANUFACTURE, OF STANDARD QUALITY, FREE ONLY NEW TIESTS OF RELEAST MANUFACTURE, OF STANDARD DUALITY, FIRE FROM DEFECTS, WILL BE PERMITTED ON THE WORK, REJECTED THE WITH TIESTS OF THE QUALITY SPECIFIED. FAILURE TO REMOVE REJECTED MATERIALS AND EQUIPMENT SHALL NOT RELEVE THE CONTRACTOR FROM THE RESPONSIBILITY FOR QUALITY AND CHARACTER OF ITEMS USED NOR FROM ANY OTHER GUIGATION IMPOSED ON HIM BY THE CONTRACT.
- ALL SLAB PENETRATIONS MUST BE X—RAYED PRIOR TO DRILLING IN ORDER TO ESTABLISH EXISTING CONDITIONS BELOW. IN CASE OF CONFLICT CONTACT ARCHITECT IMMEDIATELY, ALL SLAB X—RAYS MUST BE COORDINATED WITH THE AIRPORT AUTHORITY IN ADVANCE AND CONDUCTED AFTER BUSINESS HOURS.
- "TENANT" = "US AIRWAYS"

"OWNER" MEANS AIRPORT AUTHORITY

REFERENCE SYMBOLS

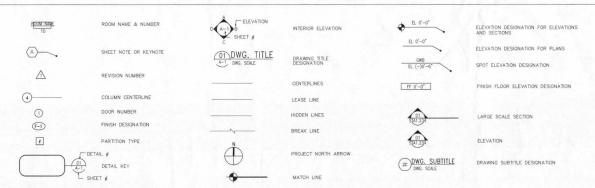

STANDARD ABBREVATIONS

2	ANGLE	LAM.	LAMINATE
± 0	ANGLE DIAMETER OR ROUND PLUS OR MINUS	LAM, LB, LDR, LIN, FT,	LAMINATE POUND(S) LEADER LINEAR FFFT
\$ f	AT CENTER LINE POUND OR NUMBER	LLH. LLV LPT LT LTG.	LEAUER LINEAR FEET LONG LEG HORIZONTAL LONG LEG VERTICAL LOW POINT LIGHT
AB ABV.	ANCHOR BOLT ABOVE	LT LTG.	LIGHTING
ACOUS. ADA ADD. A.F.F. ALLOW.	ABOVE ACCOUSTICAL AMERICANS WITH DISABILITIES ACT ADDENDUM	LTH LVL.	LENGTH LEVEL
ADD. A.F.F.	ADDENDUM ABOVE FINISHED FLOOR ALLOWANCE	MAT.	MATERIAL
ALT. ALUM.	ALTERNATE ALTIMINUM	MAX. MECH	MAXIMUM MECHANICAL
APC ATC	ACOUSTICAL PANEL CEILING ACOUSTICAL TILE CEILING	MED. MTL. MFR.	METAL MANUFACTURER
AVG.	AVERAGE		
BD.	BOARD	MISC. MOLDG. MTG.	MISCELLANEOUS MOLDING MOUNTING
BLDG. BLK	BUILDING BLOCK		
BLKG. BM	BLOCKING BEAM BOTTOM	N NFPA.	NORTH NATIONAL FIRE PROTECTION ASSOCIATION NOT IN CONTRACT NOMINAL
BOT. BPL	BEARING PLATE	N.I.C. NOM.	NOMINAL NUMBER
		NO. N.T.S.	NUMBER NOT TO SCALE
CAB. CJ CL	CABINET CONTROL JOINT CENTER LINE	O.C.	ON CENTER
CLG. CLO.	CEILING CLOSET	O.D. OFF.	OUTSIDE DIAMETER OFFICE OPENING
CLR. CMU	CENTER LINE CEILING CLOSET CLEAR CONCRETE MASONRY UNIT	O.D. OFF. OPNG. OPP. OPP.H.	OPPOSITE OPPOSITE HAND
COL. CONC.	COLUMN CONCRETE	OPP.H.	OFFOSIE PANO
CONST. CONT. CORR. CPT.	COLOMN CONCRETE CONSTRUCTION CONTINUOUS CORRIDOR CARPET	PBD. PB.	PARTICLE BOARD PULL BOX
	CARPET CERAMIC TILE COUNTER SUNK	PL. PLAM. PLYWD. PNL	PULL BOX PLATE PLASTIC LAMINATE
CTRSK	COUNTER SUNK	PLYWD. PNL	PLATE PLATIC LAMINATE PLYWOOD PANEL(ING) POUISH PAIR
DET.	DETAIL	POL PR. PT.	POLISH PAIR POINT
DIA	DETAIL DIAMETER DIMENSION	PTN.	PARTITION PAINTED
DN. D.O.	DOWN DOOR OPENING DOOR DRAWING	PWR.	POWER
DR. DWG. DPX		R RAD.	RADIUS RADIUS
DWR	DRAWER	RB.	RUBBER BASE ROUND
E EA.	EAST EACH	REC RECPT. REF.	ROUND RECESSED RECEPTICLE REFERENCE
EA. EB EJ	EACH EXPANSION BOLT EXPANSION JOINT ELEVATION	REINF.	REINFORCED REOLIBED
EL. ELEC.	ELEVATION FLECTRIC	RESIL. REV. RM.	RESILIENT REVISE
ELEV. EMER.	ELEVATION ELECTRIC ELEVATION(S) EMERGENCY ENCLOSURE	RM. R.O.	ROUGH OPENING
ENCL EQ. EQUIP	ENCLOSURE EQUAL EQUIPMENT	S SC. SCM.	SOUTH SOUD CORE
EXIST. EXP.	EXISTING EXPANSION		SOUTH SOLID CORE SOLID CORE MATERIAL SCHEDULE
EXPO.	EXPOSED	SECT. SH.	SECTION SHELF
FD.	FLOOR DRAIN	SHT. SIM.	SHEET SIMILAR
FF. FH	FLOOR DRAIN FINISH FLOOR FLAT HEAD FLAT HEAD WOOD SCREW	SQ. SQ. IN.	SQUARE SQUARE INCH STAINLESS STEEL
FHWS. FIN.		SST. ST. STD. STOR. STR.	STAINLESS STEEL STEEL STANDARD
FLR. FLUOR. F.O.F. F.O.S.	FLUORESCENT FACE OF FINISH	STOR. STR.	STANDARD STORAGE STRUCTURE
F.O.S. FRT.	FACE OF STUDS FIRE RETARDANT TREATED	SUSP. SYM. SYS.	SUSPENDED SYMMETRICAL SYSTEM
FRT. F.S. FT. FURR.	FINISH FLOOR FLUORESCENT FACE OF FINISH FACE OF STUDS FIRE RETARDANT TREATED FULL SIZE FOOT (FEET) FURRED		
FURK.	FURRED	TACK T&B T&G	TACKABLE TOP AND BOTTOM
GA. GL	GAUGE GLASS GYPSUM WALL BOARD	TEL. TELCOM	TACKABLE TOP AND BOTTOM TONGUE AND GROOVE TELEPHONE TELECOMMUNICATIONS
GWB. GYP.	GYPSUM WALL BOARD GYPSUM	TERR THK.	THICKNESS
H.C.	HOLLOW CORE HEAD	THRU TR'D TV	THROUGH TREATED TELEVISION
HDWD. HDWE.	HLAD HARDWOOD HARDWARE	TYP.	TYPICAL
H.M. HORIZ	HOLLOW METAL HORIZONTAL	UL	UNDERWRITERS LABORATORY UNLESS OTHERWISE NOTED
HR. HT.	HOUR HEIGHT	U.O.N. USSG	UNLESS OTHERWISE NOTED UNITED STATES STANDARD GAUGE
ID	INSIDE DIAMETER	v	
IN. INCAND.	INCH INCANDESCENT	V.C.T. VERT. V.I.F.	VOLT(AGE) VINYL COMPOSITION TILE VERTICAL VERTY IN FIELD
INCL. INSUL. INT.	INCLUDE INSULATION INTERIOR		
INI.	IOINT	W/ W/ WD.	WIDTH WITH WOOD
JBOX	ELECTRICAL JUNCTION BOX	W/O WP.	WITHOUT WATER PROOF
		WT.	WEIGHT



U-S AIRWAYS

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RECISTRATION

MEP ENGINEER

CHECKED BY ACCEPTED

SUBMITTED

DESIGNER

APPROVED

PROJECT TITLE

US AIRWAYS CLUB

PROJECT NUMBER 411 99078 00

PROJECT LOCATION PALM BEACH INTERNATIONAL WEST PALM BEACH, FLORIDA

DRAWING TITLE

CENERAL NOTES AND ABBREVIATIONS


> AS INDICATED REVISION DATES

ADDENDUM 2 0629.00 ADDENDUM 1 0626.00 ISSUED FOR BID 06.14.00 ISSUE DATE

ISSUED FOR PERMIT 05.26.00

SHEET NUMBER

A0.00

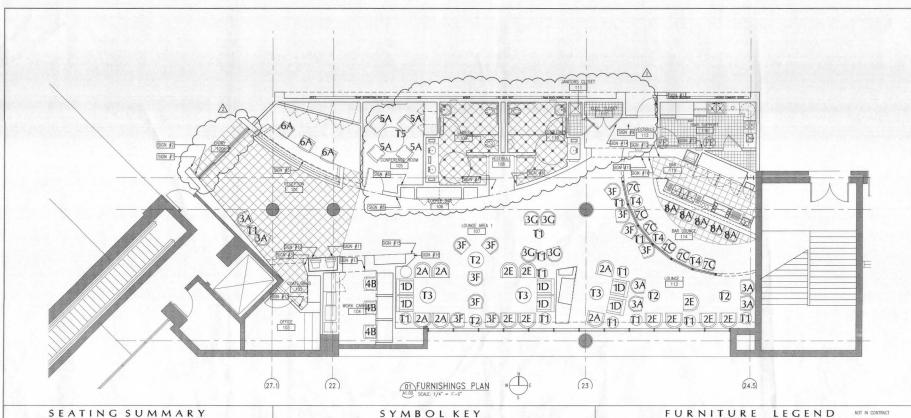

SEATING SUMA	AARY				SYMBO	DLKEY		10.		FURN	IITURI	LEGEND	NOT IN CONTRACT
	TO THE PARTY OF						- SEE 7 - 12	MARK	ITEM	QUANTITY	MANUF.	ITEM # / SIZE	REMARKS
				NEW	PARTITIONS			1	LOUNGE CHAIR	(12) TWELVE	BERNHARDT	AMBASSADOR №9352 33D x 36W x 33.75H	WOOD FINISH TO MATCH ARCHITECTS SAMPLE
LOUNGE AREA 1	22		EXISTING PARTITIONS						LOUNGE	(22) TWENTY-TWO	BERNHARDT	DUNHILL ∯7452 29.25D x 32.5W x 32H	WOOD FINISH TO MATCH ARCHITECTS SAMPLE
LOUNGE AREA 2	17		SIGNS TO BE PROVIDED AND INSTALLED BY GENERAL CONTRACTOR.						LOUNGE	(11) ELEVEN	BERNHARDT	MAYFAIR #9752 27D x 29.75W x 31 5/8H	WOOD FINISH TO MATCH ARCHITECTS SAMPLE
BAR LOUNGE	11		SIGN # SIGNS TO BE FIELD LOCATED BY ARCHITECT. INSTALLATION HEIGHTS TO MEET						TASK	(6)	BERNHARDT	AVENUE #517M	WOOD FINISH TO MATCH
CONFERENCE ROOM	4		CURRENT ADA STANLANDES. REFER TO SPECIFICATIONS FOR ADDITIONAL INFORMATION. T# TABLE INDICATOR. REFER TO TABLE LEGEND FOR ADDITIONAL INFORMATION. ALL TABLES TO BE PROVIDED BY OTHERS. #1-11 FURNITURE INDICATOR. REFER TO FURNITURE LEGEND FOR ADDITIONAL INFORMATION.					5	CHAIR	SIX (6)	BERNHARDT	26D x 23.5W x 34.5−37.5H AVENUE #520M	ARCHITECTS SAMPLE WOOD FINISH TO MATCH
WORK CARRELS	3							-	CHAIR	SIX (6)	BERNHARDT	26D x 25.5W x 37.250H AVENUE #517M	ARCHITECTS SAMPLE WOOD FINISH TO MATCH
								6	CHAIR BAR	SIX (4)	DESIGN AMERICA	26D x 23.5W x 34.5-37.5H KNICKERBOCKER HANDRAIL CHAIR #3301	ARCHITECTS SAMPLE
RECEPTION	5		ALL FURNITURE, INDICATED IN LEGEND, IS TO BE PROVIDED BY TENANT.					7	CHAIR	FOUR		23D x 21W x 32OH	ARCHITECTS SAMPLE
TOTAL	62		A-H FABRIC INDICATOR, REFER TO FABRIC LEGEND FOR ADDITIONAL INFORMATION, ALL FABRICS, INDICATED IN LEGEND, ARE TO BE PROVIDED BY TENANT.				8	BAR STOOL	(6) S0X	DESIGN AMERICA -	KNICKER BOCKER HIGH CAFE HANDRAIL CHAIR ∦3301 - 220 x 21W x 29SH	PROVIDED WITH CUSTOM STAINLE STEEL FOOT REST	
TOTAL	V2						9	PLANTER	(11) ELEVEN	NEVINS	#8200.2420 24"D X 20"H	STAINLESS STEEL FINISH	
	FIE EXTINGUISHER - CLASS A TYPE . WITH RECESSED FIRE		TYPE . WITH RECESSED FIRE EXTINGUI	SHER CABINET	10	TABLE LAMPS	(15) FIFTEEN	ARTEMIDE	#003.105 ARCADIA	CHERRY WOOD STFM			
			LABEL ACCORDINGLY NFPA-10				11	TRASH RECEPTACLES	(14) FOURTEEN	NEVINS	#7514.1026	STAINLESS STEEL FINISH PROVIDE OPTIONAL LINER	
			NOTE:	ALL FURNITURE TO	BE PROVIDED BY TENANT.	U.N.O SHOWN FOR INFORMATION ONLY		12	VISUAL PRESENT	(1)	MALCON	GMCRTP3BACK PANELS GMCRWW 2906	PROVIDE WITH
						LEGEND	NOT IN CONTRACT		CABINAT	F A F	BRIC	7.8D X 50.8W X 49.5H	GMCRTP3 BACK PANELS NOT IN CONTRACT
		MARK	ITEM	QUANTITY	MANUF.	ITEM # / SIZE	REMARKS	MARK	MANUF.	NAME		# / COLOR	REMARKS
		T 1	20 INCH	(12)	CONCEPTS PLUS	=	REFER TO SHEET A7.00	A	SPINNEYBECK	ANDES		CONQUISTADOR	-
		T 2	DRUM TABLE 25 INCH	TWELVE (5)	CONCEPTS PLUS	-	DETAIL 01 REFER TO SHEET A7.00	R	SPINNEYBECK	SABRINA	0	6043 WHIGHT OPTION #1	7 17 17 E
		T 3	DRUM TABLE 30 INCH	FIVE (6)	CONCEPTS PLUS	-	DETAIL 02 REFER TO SHEET A7.00	6	TEXTUS	HAPSBURG	THE	SASZO7 JENNESE COLLECTION	
		2/27	COFFEE TABLE 24 INCH	SIX (2)	CONCEPTS PLUS	-	DETAIL 03 REFER TO SHEET A7.00		HBF	GLASGOW		202 PEWTER 602-82	
		T 4	BAR TABLE	TWO	-		DETAIL 04	D				NICKEL	-
		T 5	48 DIAMETER CONF. RM. TABLE	(1) ONE	CONCEPTS PLUS		REFER TO SHEET A7.01 DETAIL 01	E	BERNHARDT	BALANCE SKY LARK		3274-902 DOVE GRAY	
								F	LUNA	MORLA COLLLECTION REDONDO		IICKEL MRD-85R	5
								G		\ - \			

2345 CRYSTAL DRIVE ARLINGTON, VA 22227 (703) 418-5965 FAX (703) 418-7986

PIERCE COODWIN ALEXANDER & LINVILLE 201 NORTH UNION STREET SUITE 500 ALEXANDRIA, VA 22314 (703) 836-0588 FAX (703) 836-8027



CHECKED BY ACCEPTED

PROJECT TITLE

US AIRWAYS CLUB

PROJECT NUMBER

411 99078 00 PROJECT LOCATION

PALM BEACH INTERNATIONAL AIRPORT PALM BEACH, FLORIDA


FURNISHINGS PLAN


DRAWING SCALE AS INDICATED REVISION DATES

ADDENDUM 2 06.29.00 ADDENDUM 1 06.26.00 ISSUED FOR BID 06.14.00

ISSUE DATE SSUED FOR PERMIT 05.26.00

J A1.00

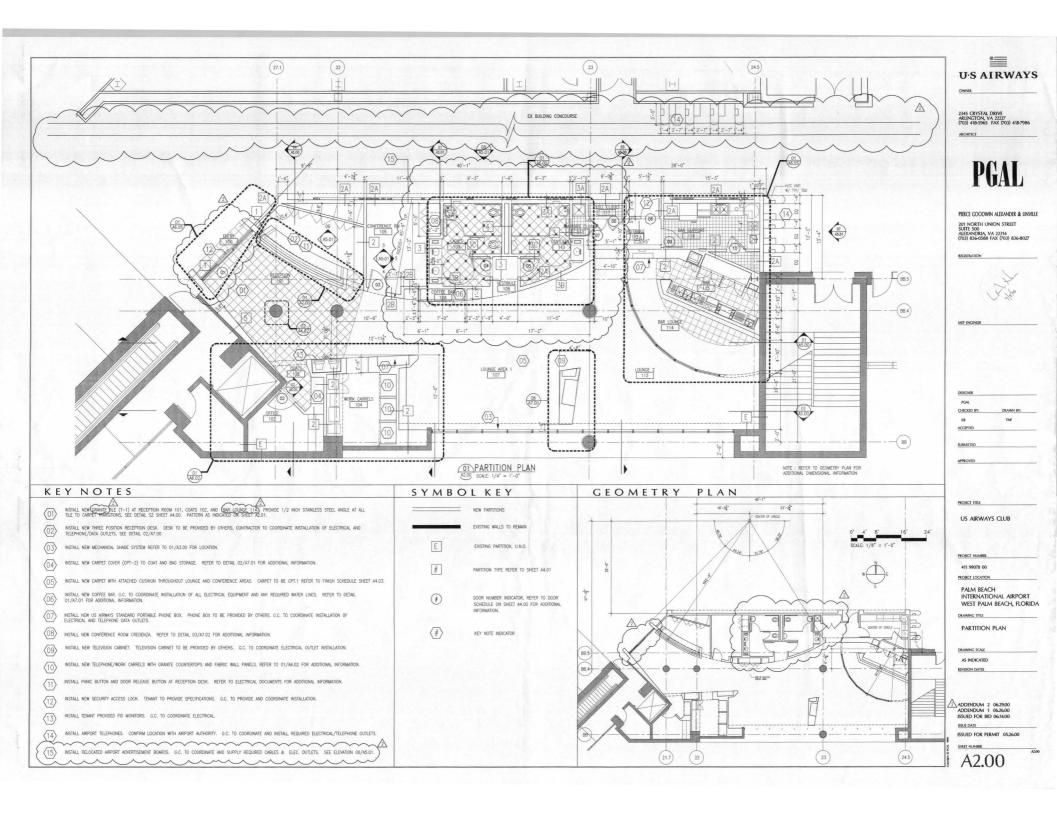

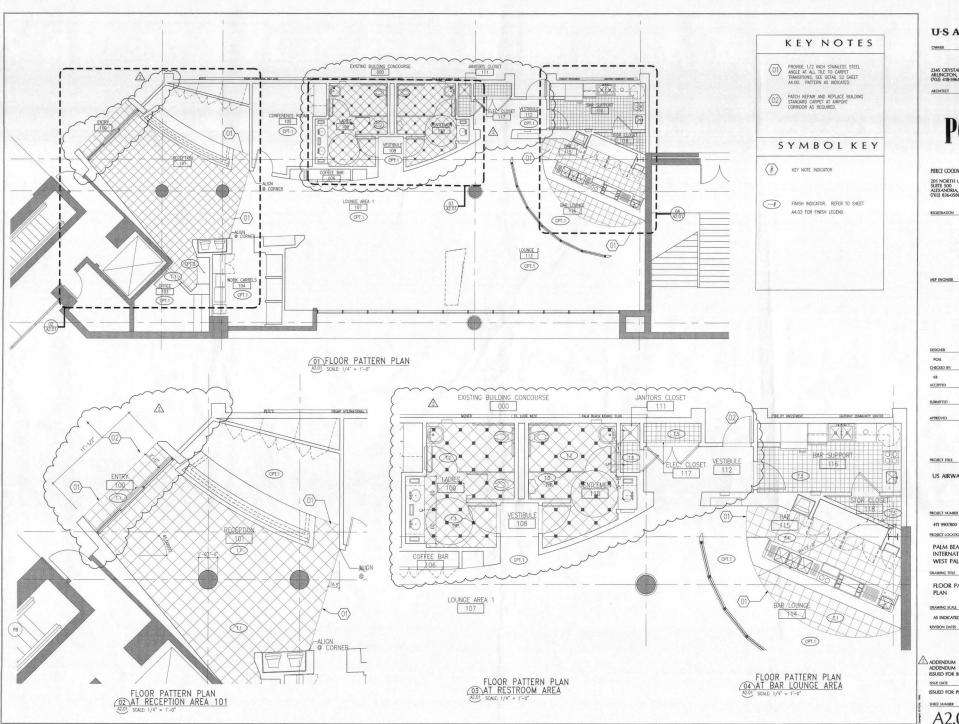



OWNER

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PIERCE GOODWIN ALEXANDER & LINVILLE 201 NORTH UNION STREET SUITE 500 ALEXANDRIA, VA 22314 (703) 836-0588 FAX (703) 836-8027



US AIRWAYS CLUB

411 9907800

PROJECT LOCATION

PALM BEACH INTERNATIONAL AIRPORT WEST PALM BEACH, FLORIDA

FLOOR PATTERN PLAN

DRAWING SCALE AS INDICATED


REVISION DATES

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SHEET NUMBER

A2.01



R	EFLECTED CEILING PLAN GENERAL NOTES		LIGH	TFIX	TURE	LEG	END		LIGHT	TFIX	TURE	LEG	END
		SYMBOL	DESCRIPTION	MANUFACTURER	MODEL NUMBER	LAMP	REMARKS	SYMBOL	DESCRIPTION	MANUFACTURER		LAMP	REMARKS
1.	COORDINATE DUCT/LIGHT/SPRINKLER LOCATIONS WITH MEP DOCUMENTS.	40	RECESSED DOWNLIGHT DIMMABLE	CON-TECH	CTR1602N-P-BLK BLACK CONE NARROW WHIE TRIM	(1) 50W GE-TAL MR16 WIDE FLOOD	LOCATED AT LOUNGE AREAS AND CONFERENCE ROOM.	N-	FLUORESCENT STRIP LIGH 3' LENGTH	HT LITHONIA LIGHTING	STANDARD STRIP S RS	(1)40W T12	MOUNT AT UTILITY CLOSET
2.	CENTER FIXTURES AND/OR DEVICES WITHIN 2' X 2' CELING GRID TILES UNLESS OTHERWISE NOTED. ALL DEVICES (INCLUDING JUNCTION BOXES, WAY/HAC CONTROLS, SHUT-OFF YALVES, ETC.) REQUIRING ACCESS WILL BE REDUCTEY LOCATED ANAY FROM DRIVABLE CIBINGS. MECHANICAL AND PULLIPINGS APEAS ARE TO BE	В	2 X 2 FLUORESCENT PARABOLIC LENSE 9 CELLS	LIGHTOLIER	VRA2G9LP3200C	T8 120V	LOCATED AT OFFICE.	₹	FLUORESCENT COVE_LIGHT	SEE MEP DOCUMENTS	SEE MEP DOCUMENTS	SEE MEP DOCUMENTS	EXISTING FIXTURES TO BE RELOCATED. CLEAN AND RELAMP FIXTURES AS REQUIRED.
4.	WILL BE REMODERT LOCATED AWAY FROM INTRACE COLUMNS, WECHANICAL AND PLUMBING AREAS ARE. TO BE REMORKED AS REQUIRED TO CUER OFWARL AREAS ARE. REFER TO MEP DOCUMENTS FOR LAMPING AND GENERAL LIGHTING NOTES.	co	WALL SCONCE	ESTILUZ	A1245- CUSTOM NICKEL FINISH WITH CUSTOM NICKEL FINISHED SIDES	R7 100W	LOCATED AT WORK CARRELS.	Δ.00	EXISTING DOWNLIGHT	SEE MEP DOCUMENTS	SEE MEP DOCUMENTS	SEE MEP DOCUMENTS	EXISTING FIXTURES TO BE RELOCATED. CLEAN AND RELAMP FIXTURES AS REQUIRED.
5. 6.	ALL FASCIAS, SOFFITS, BULKHEADS AND DRYWALL CELLINGS TO ALIGN WITH ADJACENT WALL SURFACE IN SAME PLANE, UNLESS NOTED OTHERWISE. GENERAL CONTRACTOR SHALL SUBMIT A DRAWING WHICH COORDINATES THE INSTALLATION OF ABOVE-CELLING ITEMS	D	UNDER SHELF LIGHT	LIGHTOLIER	TASKMASTER II 24 INCH LENGTH TCU20W	(1)20W 120V	MOUNT UNDER UPPER CABINETS AT WORK AREA AND OFFICE.	TO THE	MEDHANICA GRAVE	SEE MEP DOCUMENTS	SEE MEP DOCUMENTS	SPE WEB DOCUMENTS	SPECIFICATION AND
	(DUCTWORK, LIGHTS, SPRINKLESS, ETC.) PRIOR TO SUBMISSION OF SHOP DRAWINGS, IT SHALL BE THE RESPONSIBILITY OF THE CONTRACTOR TO IDENTIFY ANY CONFLICTS AT THE TIME THE COORDINATED DRAWING IS SUBMITTED. GENERAL CONTRACTOR SHALL YERRY THAT LIGHT FIXTURE SYZES SPECIFIED SHALL FIT WITHIN THE DESIGNATED.	E⊕	RECESSED ADJUSTABLE DOWNLIGHT DIMMABLE	CON-TECH	CTR1625-NK NICKEL FINISH	(1) 50W GE-TAL MR16 NARROW SPOT	LOCATED ABOVE COUNTERS.		MECHOSHADE	MECHOSHADE	T.B.D.	N/A	SEE MEP DOCUMENTS AND SPECIFICATIONS FI ADDITIONAL INFORMATION.
8.	RODUS. REFER TO MEP DOCUMENTS FOR INFORMATION PERTAINING TO FIRE SUPPRESSION AND FIRE ALARM EQUIPMENT. PROVIDE ALL FIRE ALARMS AND EMERGENCY LIGHTING TO MATCH BUILDING STANDARD. NEW FIRE ALARMS TO	F 💿	DECORATIVE PENDANT	AMERICAN GLASS LIGHT	COCO 22323-U W/WH. SANDBLASTED G/ASS SHADE	(3) 26W QUAD	LOCATED AT CONFERENCE ROOM		UNEAR DIFFUSER	SEE MEP DOCUMENTS	SEE MEP DOCUMENTS	SEE MEP DOCUMENTS	SEE MEP FOR LOCATION AND SPECIFICATION
9.	MATCH ADA. WITH REFERENCE TO CELLINGS, CONTRACTOR SHALL COORDINATE WITH ALL TRADES INVOLVED AND PREPARE COMPOSITE SHIPP DRIVANICS TO RISURE CLEARANCES FOR INCIDENS, DUCINS, CELLINGS, ETC. RECESSARY TO MOMENTARY THE SPECIFIED FRISH CLOSED RECORD RECORD TO REPORT TO THE PRISH FLOOR AS NOTED ON THE CRAWNING. CLARRY OF THE PRISH FLOOR AS NOTED ON THE CRAWNING. CLARRY OF THE PRISH FLOOR AS NOTED ON THE CRAWNING. CLARRY OF THE PRISH FLOOR AS NOTED ON THE CRAWNING. OF THE PRISH FLOOR AS NOTED ON THE CRAWNING. OF THE PRISH FLOOR AS NOTED ON THE CRAWNING. OF THE PRISH FLOOR AS NOTED ON THE CRAWNING. OF THE PRISH FLOOR AS NOTED ON THE PRISH FLOOR AS NOTED ON THE CRAWNING. OF THE PRISH FLOOR AS NOTED ON THE PRISH FLOOR AS	G	SIRIUS RAIL SYSTEM WITH PENDANTS DIMMABLE	CON-TECH LIGHTING	SL9500DS-PL 19-3/4" LENGTH SL900 1-F GLASS CONE FROSTED WHITE	(1) 50 W 120V	PENDANT ACCENT LIGHT AT RECEPTION DESK. WITH \$1,9001-F NANO GLASS 40° CONE W/FROSTED FINISH. PROVIDE CUSTOM CURVED RAIL AS INDICATED W/4 INCH LONG SUPPORT	(SP)	SPEAKER EXIT LIGHT	SEE MEP DOCUMENTS	SEE MEP DOCUMENTS	SEE MEP DOCUMENTS	SEE MEP FOR LOCATION AND SPECIFICATION SEE MEP FOR LOCATION
10.	REFER TO MEP DOCUMENTS FOR ALL SUPPLY AND RETURN DIFFUSER LOCATIONS					180	STEMS AS REQUIRED.	~~	EXII LIGHT	MER DOGUMENTS	MEP DOCUMENTS	MED DOCUMENT	
		но	FLUORESCENT DOWNLIGHT	KURT VERSEN	P926 SOFT GLOW CLEAR CONE WITH NARROW WHITE TRIM	(1) 32W TRIPLE TUBE LAMP	LOCATED AT RESTROOMS	A *	SPRINKLER		SEE MEP DOCUMENTS	SEE MEP DOCUMENTS	SEE MEP FOR LOCATION
K	ey notes	10	DECORATIVE SCONCE	BOYD	T-8 BATON 9752 POLISHED CHROME W SATIN CHROME ACCEN	(1) F17WT8RE MEDIUM BI-PIN		EL	EMERGENCY LIGHT	SEE	SEE MEP DOCUMENTS	SEE MEP DOCUMENTS	STE MER FOR LOCATION
(01)	INSTALL NEW MEDHANIZED SHADE SYSTEM BY MECH SHADE (OR EDUN.) SHADES TO EXTEND OVER 3 WINDOW MULLIONS, APPROXIMATELY 8'-O' WIDE. INSTALL PER MANIFACTURERS INSTRUCTION, BUILDS TO EXTEN FULL LURGHT OF WINDOW, APPROXIMATELY 9'-O'H. ALL DUMBSONS TO BE FEED VERRED. SHADE FARROT OR BE: EUROVEL 5306 SLIVER BRCH. REFER TO MEP. DOCUMENTS AND SPECIALIZATIONS FOR ADDITIONAL MORRHANION.	K	SIRIUS RAIL SYSTEM WITH PENDANTS DIMMABLE	CON-TECH LIGHTING	SL9500-PL 17-1/3" LENGTH SL900 1-F GLASS CONE FROSTED WHITE	(1) 50 W 120V	PENDANT ACCENT LIGHT AT BAR, WITH SL9001-F NANO GLASS 40" COME W/FROSTED FINISH. PROVIDE CUSTOM CURVED RAIL AS INDICATED W/4 INCH LONG SUPPORT STEMS AS REQUIRED.		ACCESS PANEL @ GWB CEILING	-	r.	-	PAINT TO MATCH EXISTING CEILING - P-2. INSTALL AS REQUIRED SEE MEP DOCUMENTS FOR REQUIRED LOCATIONS.
(02)	NEW LIGHT COVE TO MATCH EXISTING BUILDING CORRIDOR LIGHT COVE IN SHAPE AND SIZE. PROVIDE A SMODTH, NEAT, CONTINUOUS APPLARANCE WHITE: NEW LIGHT COVE MEETS EXISTING, PATCH AND REPRUE ALL, SIZECULES AS REQUIRED. FINISH TO MATCH EXISTING.	L	CUSTOM FLUORESCENT OVERLAP STRIP LIGHTING SYSTEM	SPECIALTY LIGHTIN INDUSTRIES INC.	G CUSTOM LENGTH T.B.D.	T-5 18W	LOCATED AT BAR						
(03)	REMOVE EXISTING GRILL. PATCH AND REPAIR EXISTING SOFFIT TO MATCH EXISTING.	M	2 X 2 FLUORESCENT ACRYLIC LENSE	LIGHTOLIER	XR2GVA2U4LE	T8 120V	LOCATED AT BAR SUPPORT				-		

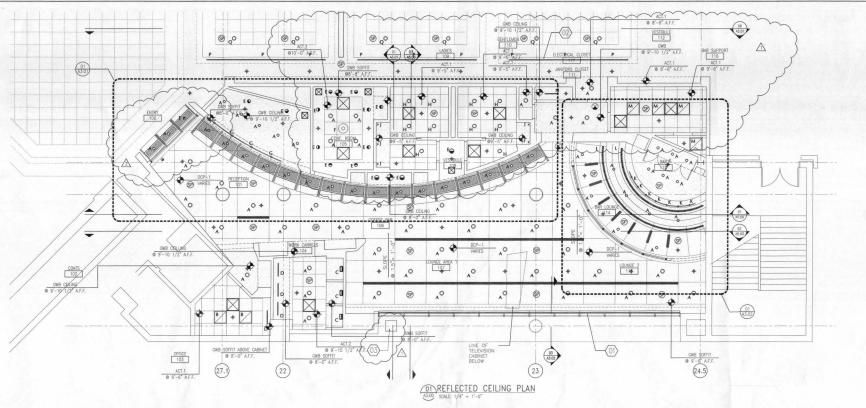NOTE 1: REFER TO ELECTRICAL DRAWINGS FOR EMERGENCY AND EXIT LIGHT LOCATIONS AND SPECIFICATIONS. NOTE 2: REFER TO SHEET A4.03 FOR FINISH SCHEDULE

U·S AIRWAYS

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ARCHITECT

PGAL

PIERCE COODWIN ALEXANDER & LINVILL 201 NORTH UNION STREET SUITE 500 ALEXANDRIA, VA 22314 (703) 836-0588 FAX (703) 836-8027

REGISTRATION



MEP ENGINEER

DESIGNER
PGAL
CHECKED BY: DRAWN BY:
KB CAL
ACCEPTED

SUBMITTED

PROJECT TIME

US AIRWAYS CLUB

PROJECT NUMBER

411 99078 00

PROJECT LOCATION

PALM BEACH INTERNATIONAL AIRPORT WEST PALM BEACH , FLORII

DRAWING TITLE

REFLECTED CEILING

PLAN

DRAWING SCALE

AS INDICATED

REVISION DATES


ADDENDUM 2 0629.00 ADDENDUM 1 0626.00 ISSUED FOR BID 06.14.00

ISSUED FOR BID 06.14.00

ISSUED FOR PERMIT 05.26.00

A3.00

NOTE 3: PROVIDE ALL LIGHTING FIXTURES AS LISTED ABOVE. IN CASE OF CONFLICT WITH MEP DOCUMENTS CONTACT ARCHITECT FOR CLARIFICATION. ARCHITECTURAL FIXTURE SPECIFICATION WILL SUPERCEDE MEP DOCUMENTS.

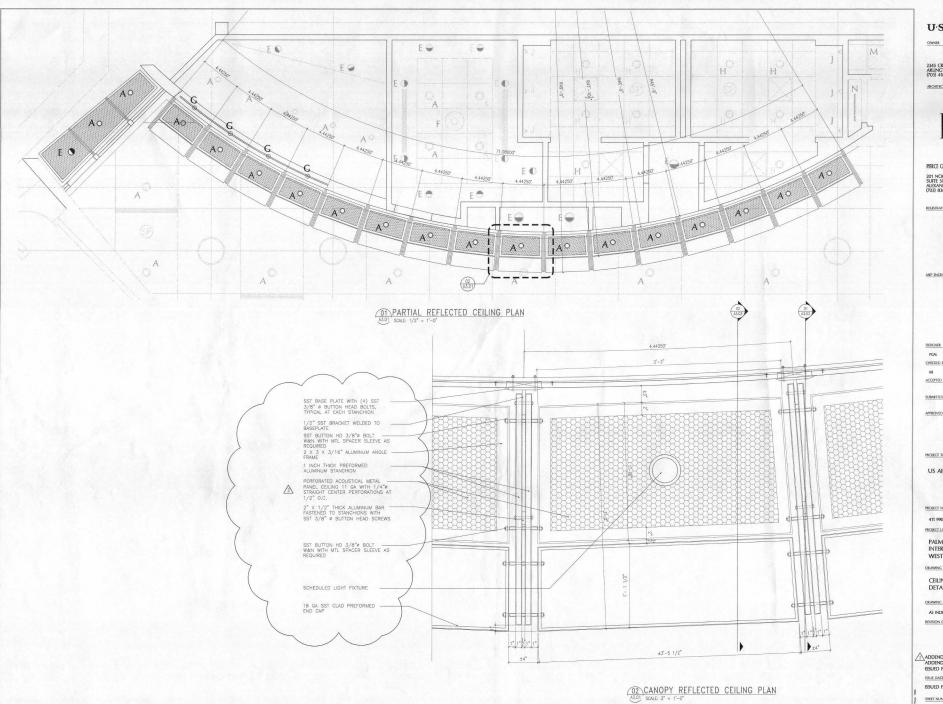



ARCHITECT

2345 CRYSTAL DRIVE ARLINCTON, VA 22227 (703) 418-5965 FAX (703) 418-7986

PIERCE GOODWIN ALEXANDER & LINVILLE 201 NORTH UNION STREET SUITE 500 ALEXANDRIA, VA 22314 (703) 836-0588 FAX (703) 836-8027

REGISTRATION



MEP ENGINEER

DESIGNER CHECKED BY: CAL

SUBMITTED

PROJECT TITLE

US AIRWAYS CLUB

PROJECT NUMBER 411 99078 00

PROJECT LOCATION

INTERNATIONAL AIRPORT WEST PALM BEACH , FLORIDA

DRAWING TITLE CEILING

DETAILS


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A3.01





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PIERCE GOODWIN ALEXANDER & LINVILI




WEST PALM BEACH, FLORII

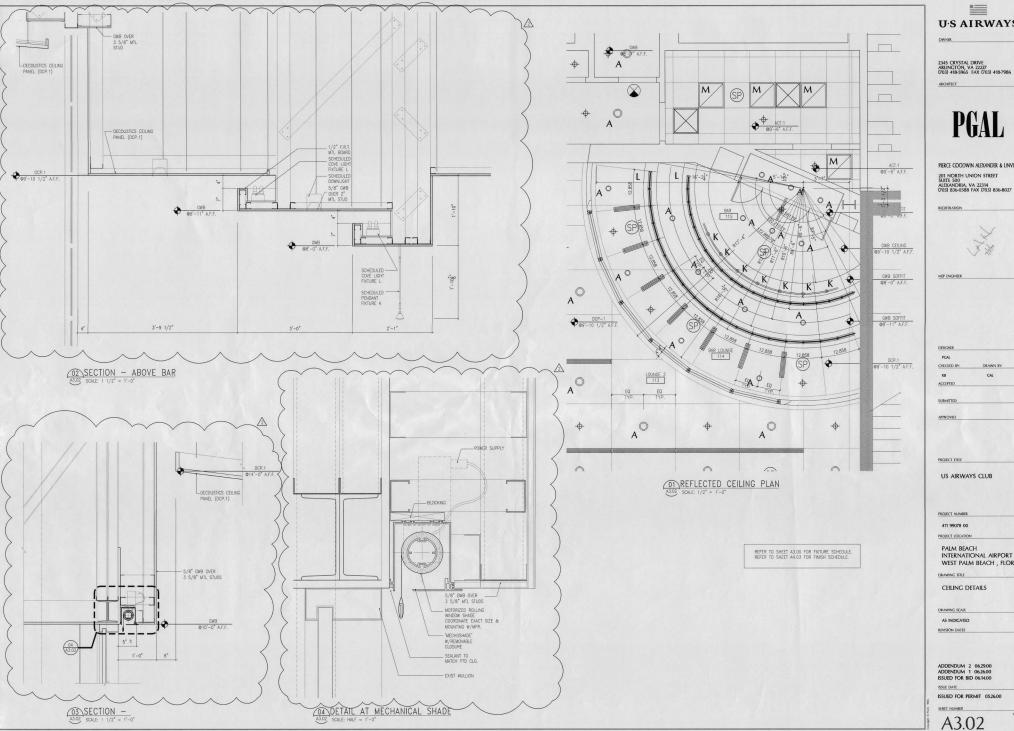


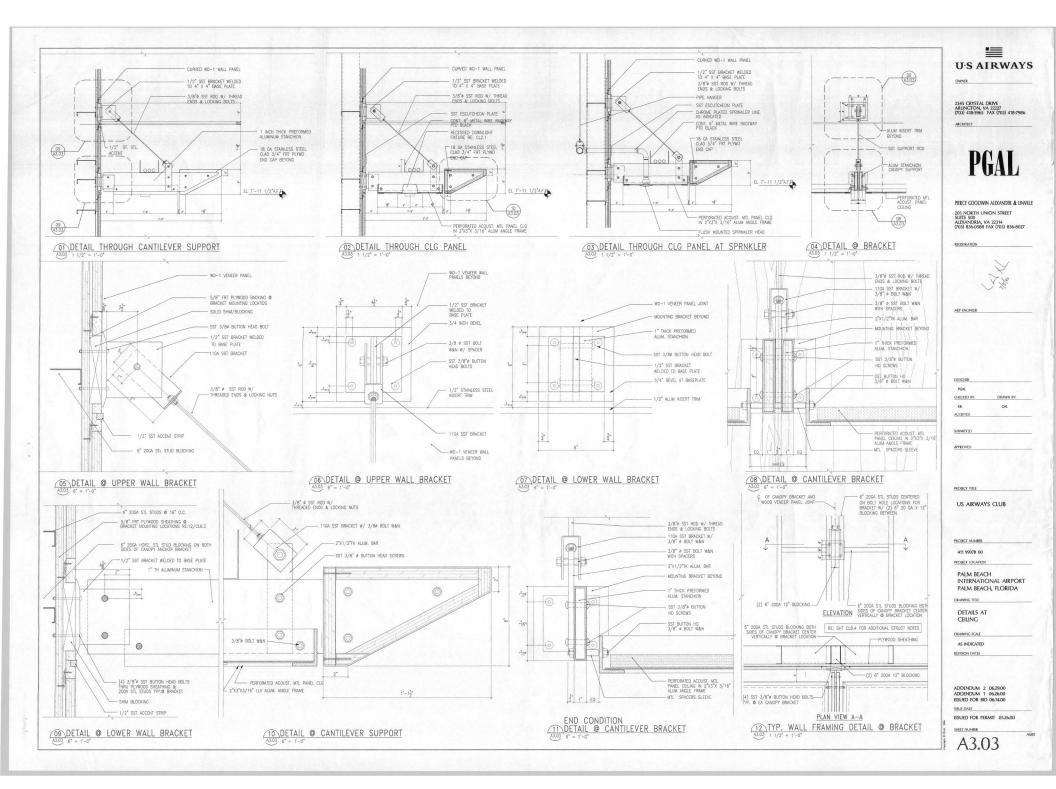

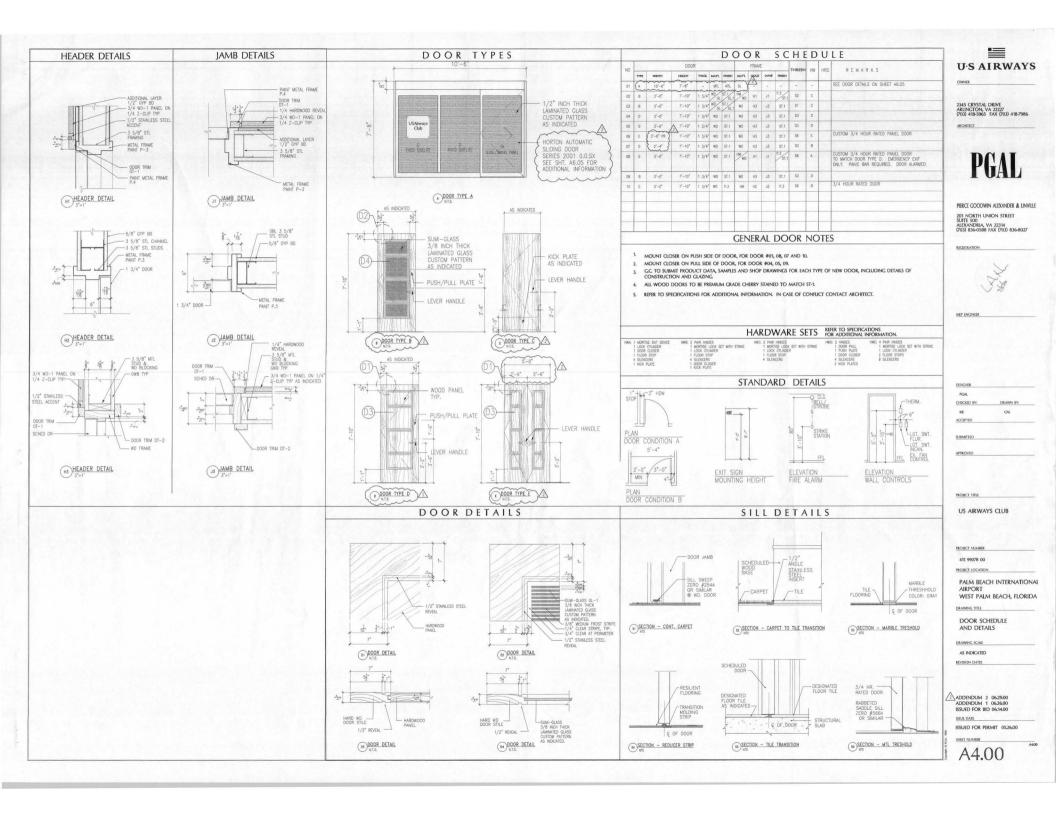
TYPICAL DETAILS

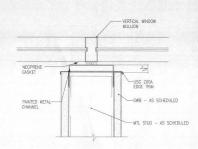

TYPICAL DETAIL AT WINDOW MULLION

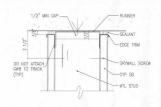


TYPICAL DETAIL AT RUNNER ATTACHMENT

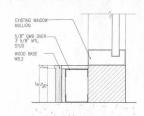

O3 TYPICAL DETAIL

PARTITION TYPES

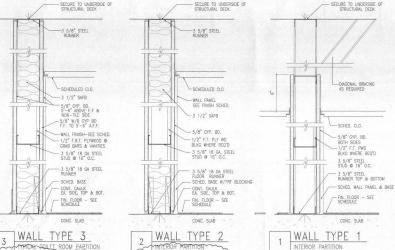


2A

Δ

TYPICAL TOLLET ROOM PARTITIO WALL TYPE 3A 1 HR RATED PARTITION AT RESTROO 18 GA 6 INCH STUDS MAINTAIN ENCLOSURE AT ALL PENATRATIONS WALL TYPE 3B

18 GA. 6 IN. STUD

WALL TYPE 3C 5/8 IN. W/R GWB AND TILE BOTH SIDES

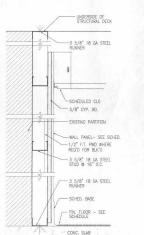

1 HR RATED - UL NO. U465 18 GA 6 INCH STUDS

WALL TYPE 2B 18 GA. 6 IN. STUD

5 WALL TYPE 5

WALL TYPE 4 TYPICAL TOILET ROOM CHASE

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MEP ENCINEER

CHECKED BY: DRAWN BY: CAL

APPROVED

ACCEPTED

SECURE TO UNDERSIDE OF STRUCTURAL DECK

-3 5/8" 18 GA STEEL RUNNER

__ 3 1/2" SAFB

SCHED CLG

3-0" ABOVE F.F. 5/8" W/R GYP BD 3'-0" FROM F.F TILE — SEE SCHEDULE 3 5/9"

5/8" GYP. BD. 3'-0" ABOVE F.F

3.5/6" 18 GA STEEL STUD © 16" O.C. 1/2" F.T. PWD © GRAB BARS & VANITIES

-SCHED. BASE

FIN. FLOOR

CONC. SLAB

-3 5/8" 18 GA STEEL RUNNER

PROJECT TITLE

US AIRWAYS CLUB

PROJECT NUMBER 411 9907800

PALMBEACH INTERNATIONAL WEST PALM BEACH, FLORIDA

DRAWING TITLE

PARTITION TYPES AND DETAILS


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A4.01





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MEP ENCINEER

US AIRWAYS CLUB

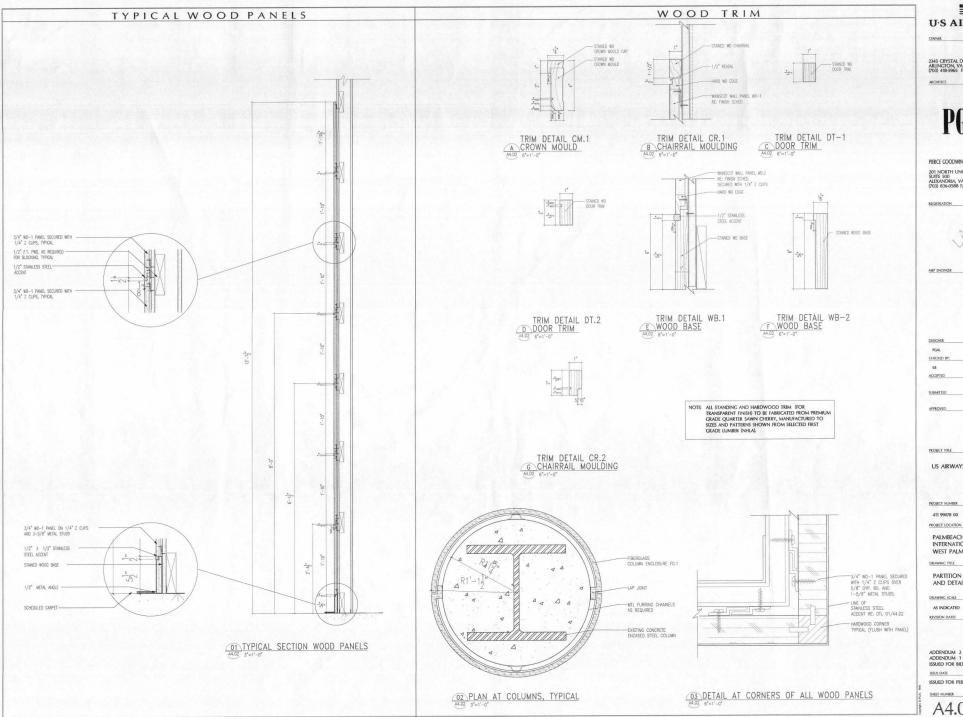PROJECT NUMBER

411 99078 00

PALMBEACH INTERNATIONAL AIRPORT WEST PALM BEACH, FLORIDA

PARTITION TYPES AND DETAILS

DRAWING SCALE

REVISION DATES

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A4.02

SYMBOL	FLOOR T	TLE
T.1	MANUFACTURER:	COLD SPRING
ENTRY RECEPTION	STYLE:	GRANITE HONED FINISH
COAT RM BAR LOUNGE	COLOR:	BLACK
	SIZE:	12X12 3/8" TH
	GROUT:	1/8 INCH GROUT JOINTS MANUFACTURER: MAPEI COLOR: BLACK #10
T.2	MANUFACTURER:	GRANITO PORCELLANATO PIEMMEGRES
RESTROOM FLOOR	STYLE:	ASTRI
	COLOR:	HA 204 DUBHE MATTE FINISH
	SIZE:	12X12 3/8° TH
	GROUT:	1/8 INCH GROUT JOINTS MANUFACTURER: MAPEL COLOR: CHARCOAL #47
T.3	MANUFACTURER:	GRANITO PORCELLANATO PIEMMEGRES
RESTROOM FLOOR	STYLE:	ASTRI
100	COLOR:	HAL 205 IZAR POLISHED FINISH
	SIZE:	POLISHED FINISH 4 X 4 3/8" TH
	GROUT:	3/8" TH 1/8 INCH GROUT JOINTS MANUFACTURER: MAPEI COLOR: CHARCOAL #47
T.4	MANUFACTURER:	
BAR	STYLE:	CERAMIC TILE
	COLOR:	ONYX UPS, FINISH
	SIZE:	12X12 #A880
	GROUT:	1/8 INCH GROUT JOINTS MANUFACTURER: MAPEL COLOR: BLACK #10
T.5	MANUFACTURER:	CROSSVILLE
	STYLE:	CERAMIC TILE
BAR SUPPORT	COLOR:	MERCURY UPS, FINISH #A825
	SIZE:	8x8
	GROUT:	1/8 INCH GROUT JOINTS MANUFACTURER: MAPEL COLOR: PEARL GRAY #19
T.6	MANUFACTURER:	GRANITO PORCELLANATO
RESTROOM	STYLE:	PIEMMEGRES
WALLS .	COLOR:	
	SIZE:	HAL 204 DUBHE POLISHED FINISH 12X12 3/8° TH
7	GROUT:	1/8 INCH GROUT JOINTS
		MANUFACTURER: MAPEI COLOR: ANTIQUE WHITE #25
SYMBOL	CARPET	DENTI CV
CPT.1	MANUFACTURER: STYLE:	BENTLEY 8YV4406300
DEFICE CONFERENCE RM BAR LOUNGE	COLOR:	PDS# 100707/020 CUSTOM COLOR LT GREY 204568/DK GREY
	BACKING:	204569/LT GREY 204570 MANUFACTURERS
	NOTES:	ATTACHED CUSHION "ReSOURCE " INSTALLERS ONLY
CPT.2	MANUFACTURER:	
COATS AND BAGS	STYLE:	WINDFALL
		WF5499 HYDRANGEA
		PER SPECIFICATIONS
		INSTALLED AT COAT
		STORAGE SHELF

WA	ALL B.	ASE
SYMBOL	VINYL W	ALL BASE
VB.1	MANUFACTURER:	ARMSTRONG
OFFICE		
	SIZE:	4" STRAIGHT BASE
1000	COLOR:	#71 MID GRAY
SYMBOL	TILE BAS	CDANITO DODOS LANATI
TB.1	MANUFACTORER:	GRANITO PORCELLANATI PIEMMEGRES
RESTROOMS	STYLE:	ASTRI
	COLOR:	HAL 205 IZAR POLISHED FINISH
	SIZE:	6 IN. HIGH X 12 IN. 1 3/8" TH
	GROUT:	3/8" TH 1/8 INCH GROUT JOIN
	GROUT:	MANUFACTURER: MAPE COLOR: CHARCOAL #47
70.0	MANUFACTURER:	CROSSVILLE
TB.2		
BAR SUPPORT	STYLE:	CERAMIC TILE
	COLOR:	MERCURY UPS, FINISH #AB25
	SIZE:	4 X 8
	GROUT:	1/8 INCH GROUT JOIN
		MANUFACTURER: MAPE COLOR: PEARL GRAY #
SYMBOL	WOOD	BASE
WB.1	MANUFACTURER: COLOR:	TO BE STAINED ST-1
	SIZE:	
	SIZE:	CUSTOM, REFER TO A4.0 FOR PROFILE
WB.2	MANUFACTURER:	
	COLOR:	TO BE STAINED ST-1
5.7	SIZE:	CUSTOM, REFER TO A4.0 FOR PROFILE
SYMBOL	STAINLES	
SSB.1	MANUFACTURER:	
	FINISH:	STAINLESS STEEL
	SIZE:	CUSTOM, REFER TO A4.0 FOR PROFILE
SYMBOL	FIBERGLA	ASS BASE
FGB-1	DESCRIPTION:	FIBERGLASS REINFORCE
7 1		BASE
	MANUFACTURER:	
	COLOR:	GELCOAT W/CUSTOM COLOR: 80% METALLIC FLEC FACTORY BAKED I COLOR TO MATCH ARCHITECTS SAMPLE 20% NON-METALLIC FACTORY APPLIED CUST COLOR TO MATCH ARCHITECTS SAMPLE DEED TO SECULPATION
		FLEC FACTORY BAKED I COLOR TO MATCH
		ARCHITECTS SAMPLE 20% NON-METALLIC
		COLOR TO MATCH
	NOTES:	REFER TO SPECIFICATIO SECTION 09233
WA	ALL FI	NISHES
SYMBOL	FABRIC V	WALL COVER
FWC.1	MANUFACTURER:	WOLF GORDON
LOUNGE	PATTERN: COLOR:	PINSTITCH PNS-4292-REGAL
LOUNGE CONFERENCE ROOM		#G1533972
	ITEM#;	G1937949
	MANUFACTURER: PATTERN:	DESIGN TEX HARDWEAR
FWC.2	PAHENN:	HARDWEAR KRYPTON TOO
COATS/BAGS	COLOR:	
	COLOR:	
COATS/BAGS	ITEM#:	6399-801
COATS/BAGS	ITEM#: VINYL WA	6399-801
COATS/BAGS SYMBOL VWC.1	ITEM#: VINYL WA	6399-801 ALL COVERING JM LYNNE
COATS/BAGS	ITEM#: VINYL WA	6399-801

VWC.2

RESTROOMS

MANUFACTURER:

PATTERN:

COLOR:

DESIGNTEX

DULCIMER

SYMBOL	PAINT	
P.1	MANUFACTURER:	DURON STERLING COIN
SOFFIT AREA	COLOR: ITEM#:	STERLING COIN 8782W
PARTITIONS	FINISH:	FLAT AT LOUNGE AREAS EGGSHELL AT RESTROOMS BAR SUPPORT AND
		BAR SUPPORT AND STORAGE AREAS
P.2	MANUFACTURER:	DURON
TYPICAL AT	COLOR: ITEM#:	SOLO WHITE-FLAT CW051W
GWB CEILINGS	FINISH:	FLAT AT ALL CEILINGS
P.3	MANUFACTURER:	DURON
DOOR AND DOOR TRIM	COLOR: ITEM#:	STERLING COIN- 8782W
	FINISH:	SEMIGLOSS AT ALL PAINT GRADE DOORS & FRAME!
P.4	MANUFACTURER:	
I visit	COLOR:	CUSTOM
DOOR AND DOOR TRIM	ITEM#:	CUSTOM
	FINISH:	TO MATCH WOOD STAIN COLOR ST.1
SYMBOL	FIBERGLAS	
FG.1		CED PLASTIC
PG.1	DESCRIPTION:	FIBERGLASS REINFORCED POLYESTER COLUMN ENCLOSURE
	MANUFACTURER:	EDON FIBERGLASS OR APPROVED EQUAL
	COLOR:	GELCOAT W/CUSTOM COLOR: 80% METALLIC FLEC FACTORY BAKED ON COLOR TO MATCH ARCHITECTS SAMPLE 20% NON-METALLIC FACTORY APPLIED CUSTON COLOR TO MATCH ARCHITECTS SAMPLE ARCHITECTS A
		COLOR TO MATCH ARCHITECTS SAMPLE
		FACTORY APPLIED CUSTON
	HOTES	ARCHITECTS SAMPLE REFER TO SPECIFICATIONS
	NOTES:	SECTION 09233
FG.2	DESCRIPTION:	FIBERGLASS REINFORCED PANEL WITH 1/2 INCH REVEALS
	MANUFACTURER:	EDON FIBERGLASS
	COLOR:	OR APPROVED EQUAL
	5.0	GELCOAT W/CUSTOM COLOR: 80% METALLIC FLEC FACTORY BAKED ON
		COLOR TO MATCH ARCHITECTS SAMPLE 20% NON-METALLIC
		20% NON-METALLIC FACTORY APPLIED CUSTON COLOR TO MATCH
		ARCHITECTS SAMPLE
	NOTES:	REFER TO SPECIFICATIONS SECTION 09233
SYMBOL		FABRIC PANEL
AFP.1	MANUFACTURER: TYPE:	NOVAWALL 1/2" SYSTEM SQUAR
AT WORK	III-C.	1/2" SYSTEM SQUAR W/ ACOUSTICAL FIBERGLASS CORE
CARRELS	FABRIC COVER:	TEXTUS GROUP IONIC # 1168.107 PACIFIC
NAII	LLWC	
SYMBOL	PLASTIC MANUFACTURER:	FORMICA FORMICA
PLAM.1		
AT	COLOD (CINICI)	
	COLOR/FINISH:	FOG, MATTE
AT BAR SUPPORT	ітем∯:	# 961−58
AT BAR SUPPORT PLAM,2	ITEM∯: MANUFACTURER:	#961-58 FORMICA
AT BAR SUPPORT PLAM,2 AT INTERIOR OF	ітем∯:	#961-58 FORMICA
AT BAR SUPPORT PLAM,2	ITEM∯: MANUFACTURER:	#961-58 FORMICA
AT BAR SUPPORT PLAM,2 AT INTERIOR OF WOOD VENEER	ITEM#: MANUFACTURER: COLOR/FINISH:	#961-58 FORMICA BLACK, MATTE #909-58
PLAM.2 AT INTERIOR OF WOOD VENEER MILWORK CABINETS	ITEM#: MANUFACTURER: COLOR/FINISH: ITEM#: MANUFACTURER:	#961-58 FORMICA BLACK, MATTE #909-58

ROOM		FL	OOR		WA	LLS	720	CEI	LING	REMARKS
NO	SPACE NAME	ROOR	BASE	WEST	NORTH	EAST	SOUTH	MATL	HEIGHT	
00	ENTRY	T.1	WB.1	-	-	GL.1	-	-	-	REFER TO SHEET A6.05 FOR ADDITIONAL INFORMATION
01	RECEPTION	T.I	WB.1	GL1	WĐ.1	-	FG.1	DCP.1	VARIES	ENTRY
02	COATS/BAGS	1.1	WB.2	FG.2	FWC.2	FWC.2	WD.1	GWB	9'-10 1/2"	
03	OFFICE	CPT.1	VB.1	FWC.1	FWC.1	FWC.1	FWC.1	ACT.1	9'-6"	
04	WORK CARRELS	CPT.1	WB.1	WD.1	WD.1	AFP.1	WD.1	GWB ACT.2	8'-0" 9'-10 1/2"	
05	CONFERENCE ROOM	CPT.1	WB.2	PWC.1	FWC.1	FWC.1	FWC.1	ACT.2	10'-0"	
06	COFFEE BAR	CPT.1	WB.1		W0.1	-	4	GWB	8'-0"	VIDA INTERNATION
07	LOUNGE AREA 1	CPT.1	WB.1	WD.1	W0.1	FWC.1	CURTAIN WALL	DCP.1	VARIES	
08	VESTIBULE	CPT.1	WB.1	WD.1	WD.1	WD.1	/=	GWB	8'-0"	
09	LADIES RESTROOM	12/3	TB.1	VWC.2/ T.6	VWC.2/ T.6	VWC.2/ T.6	VWC.2/T.6	ACT.1	9'-5"	
10	GENTLEMEN RESROOM	12/3	TB.1	VWC.2/ T.6	VWC.2/ T.6	VWC.2/ 1.6	VWC.2/ T.6	ACT.1	9'-5"	
11	JANITORS CLOSET	T.5	TB.2	VWC.1/ T.5	VWC.1/T.5	VWC.1/7.5	VWC.1/T.5	ACT.1	8'-0"	
12	VESTIBULE	CPT.1	WB.1	WD.1	WD.1	WD.1	WD.1	GWB	9'-10 1/2"	
13	LOUNGE 2	CPT.1	WB.1 WB.2	WD.1	WD.1	FWC.1	CURTAIN WALL	DCP.1	VARIES	
14	BAR LOUNGE	T.2/3	WB.1	GL.1	WD.1	FWC.1	GL.1	DCP.1 GWB	9'-10 1/2"	
15	BAR	T.4	WB.1	-	WD.1	FWC.1	-	GWB	8'-0"	
16	BAR SUPPORT	T.5	TB.2	VWC.1	VWC.1	VWC.1	VWC.1	ACT.1	9'-6"	
17	ELEC CLOSET	T.5	TB.2	P.1	P.1	P.1	P.1	ACT.1	9'-6"	
18	STORAGE CLOSET	T.5	TB.2	P.1	P.1	P.1	P.1	ACT.1	9'-6"	
19										
					1					
					100					



2345 CRYSTAL DRIVE ARLINGTON, VA 22227 (703) 418-5965 FAX (703) 418-7986 ARCHITECT

PIERCE GOODWIN ALEXANDER & LINVILLE 201 NORTH UNION STREET SUITE 500 ALEXANDRIA, VA 22314 (703) 836-0588 FAX (703) 836-8027

REGISTRATION



MEP ENCINEER

DESIGNER CHECKED BY: ACCEPTED SUBMITTED APPROVED

PROJECT TITLE

US AIRWAYS CLUB

PROJECT NUMBER 411 99078 00 PROJECT LOCATION

PALM BEACH INTERNATIONAL AIRPORT WEST PALM BEACH, FLORIDA DRAWING TITLE

FINISH SCHEDULES

AS INDICATED REVISION DATES

ADDENDUM 2 06.29.00 ADDENDUM 1 06.26.00 ISSUED FOR BID 06.14.00 ISSUE DATE

ISSUED FOR PERMIT 05.26.00 SHEET NUMBER

A4.03

NOTES: -			117	ELEC CLOSET
1000000	VENIFER	-	118	STORAGE CLO
			119	
COLOR: P	PREMIUM GRADE QUARTER SAY CHERRY VENEER PANEL TO BE ENTERED AND BOOK MATCHE ACKING VENEER SPECIES: OUND TO BE STAINED ST.1 1/4" THICK	WN E ID.		
S A	OLID HARDWOOD 7/8" THICK T ALL CORNERS.	E		
STAIN (COLOR			
NOTES: F	EFER TO SPECIFICATIONS.			
		.S		
722210112000				
262500	WHITE			
ITEM#:	#1912 ULTIMA VERY FINE TEXTUR	E		
NOTES:				
MANUFACTURE	R: ARMSTRONG			
STYLE:	24"X24"X3/4"			
COLOR:	PLATINUM			
	#557			
ITEM∯:	CHAMFERED CIRRU	S		
ITEM∯: NOTES:		INE		
NOTES:	CHAMFERED CIRRU USE WITH SUPRAFI 9/16" EXPOSED T	INE EE		
NOTES:	CHAMFERED CIRRU USE WITH SUPPAP 9/16" EXPOSED T SYSTEM	INE EE		
NOTES:	CHAMFERED CIRRU USE WITH SUPPAP 9/16" EXPOSED T SYSTEM	INE EE		
NOTES: DECOUS MANUFACTURE	CHAMFERED CIRRU USE WITH SUPRAF 9/16" EXPOSED T SYSTEM 6. CEILING PANE R: DECOUSTICS	EL.		
NOTES: DECOUS MANUFACTURE SIZE:	CHAMFERED CIRRU USE WITH SUPPARI 9/16" EXPOSED T SYSTEM CEILING PANE DECOUSTICS PER DRAWINGS CUSTOM GRAY TO MATCH	EL.		
	MANUFACTURE OOLOR: P OOLOR: P S SIZE: 3 NOTES: E S NOTES: II LINC ACOUS. MANUFACTURE SYZE: COLOR: ITEM#: NOTES: II MANUFACTURE STRIP MANUFACTURE STRIP MANUFACTURE STRIP MANUFACTURE STRIP MANUFACTURE STRIP	CEMIERED AND BOOK MATCHE BACKNOW CYNERS SEZON SZEZ: 3/4" HICK STANKED ST.1 SZEZ: 3/4" HICK STANKED ST.1 NOTES: EDONG OF ALL PARKES TO B SOLID HARDWOOD 7/8" THICK ARETER TO SPECIFICATIONS STAIN COLOR COLOR: TO MATCH ARCHITECTS OUTION SAMPLE MANUFACTURER: ARMSTROMG SZEZ: 24"24"3/3" COLOR: WHITE IFEM#: #1912 ULTIMA VERY FIRE TEXTURE MOTES: USE WITE SUPPORT NOTES: USE WITE SUPPORT STETUM MANUFACTURER: ARMSTROMO STYLE: 24"24"24"3/4" MANUFACTURER: ARMSTROMO STYLE: 24"24"3/4" MANUFACTURER: ARMSTROMO STYLE: 24"24"3/4" MANUFACTURER: ARMSTROMO STYLE: 24"24"3/4"	MANUFACTURER: CUSTOM COLOR: PREMIUM BROBE QUARTER SAWN COLOR: PREMIUM BROBE QUARTER SAWN CHEER SAWN BOOK MATCHED. BACKNOW CYNERS STREETS. SIZE: 3/4" HICK STAWNED ST.1 SIZE: 3/4" HICK STAWNED ST.1 NOTES: EDONO OF ALL PARSES TO BE SOLD HARDWOOD 7/8" THICK AT ALL CONDURS. STAIN COLOR COLOR: TO MATCH ARCHITECTS CUSTOM SAWNER COLOR: TO MATCH ARCHITECTS OUTION SAWNER MANUFACTURER: ARMSTROMG SIZE: 24"24"X3/4" COLOR: WITH IFEM#: #1912 ULTIMA VERY FIRE TEXTURE MOTES: USE WITH SUPPARABLE MOTES: USE WITH SUPPARABLE MOTES: 91912 ULTIMA VERY FIRE TEXTURE MOTES: USE WITH SUPPARABLE MOTES: USE WITH SUPPARABLE MANUFACTURER: ARMSTROMG SIZE: 24"24"X3/4" COLOR: WITH IFEM#: #1912 ULTIMA VERY FIRE TEXTURE MOTES: USE WITH SUPPARABLE MANUFACTURER: ARMSTROMG STYLE: 24"24"X3/4"	MOOD VENEER MANUFACTURER: CUSTOM OOLOS: PREMIUM GRADE QUARTER SAWN CHERRY VENERE PARKE. TO BE CONTRETED AND BOOK MAD SECTION SOUND TO BE STANKED ST. I SOUND THE STANKED ST. I SOUND THE STANKED ST. I SOUND TO BE STANKED ST. I SOUND TO BE STANKED ST. I SOUND THE STANKED ST. I SOUND SAWNIE OOLOR: TO MATCH ARCHITECTS CUSTOM SAWNIE OOLOR: REFER TO SPECIFICATIONS. LING MAT. ACOUS. CEILING PANELS MANUFACTURER: ARMSTRONG SZE: 24°24°34'34' COUGH: #1912 ULTIMA VERY THE EXCURE NOTES: USE WITH SUPPRANCE 9/16" DOPOSED TEE SISTEM MANUFACTURER: ARMSTRONG STYLE: 24°24'34'4' MANUFACTURER: ARMSTRONG STYLE: 24°24'34'4' MANUFACTURER: ARMSTRONG STYLE: 24°24'34'4' MANUFACTURER: ARMSTRONG STYLE: 24°24'34'4'

MILLWORK

SYMBOL SOLID SURFACE

COLOR/FINISH: SIERRA DUSK THICKNESS AS INDICATED ON DRAWINGS

COLOR/FINISH: PLATINUM MAGNUM COUNTER W/ INTEGRAL BOWL BOWL FINISH: PEARL GRAY

SYMBOL GRANITE COUNTERS

MANUFACTURER: INTERNATIONAL GRANITE AND MARBLE CORP. BLACK GALAXY

CONTACT: 1-800-552-5558

SSM.1 MANUFACTURER: CORIAN

SIZE:

SYMBOL LAMINATE GLASS

SIZE: -NOTES: -

MANUFACTURER: SUMIGLASS


COLOR: CUSTOM PATTERN AS INDICATED
ON DRAWINGS.
COMPOSED OF 3/8" HORIZONTAL
STRIPES — MEDIUM FROST/FR410
STRIPES — MEDIUM FROST — FR41

SSM:2

RESTROOMS

GR.1

RAL NOTE: SEE PROJECT MANUAL FOR ADDITIONAL PRODUCT INFOMATION

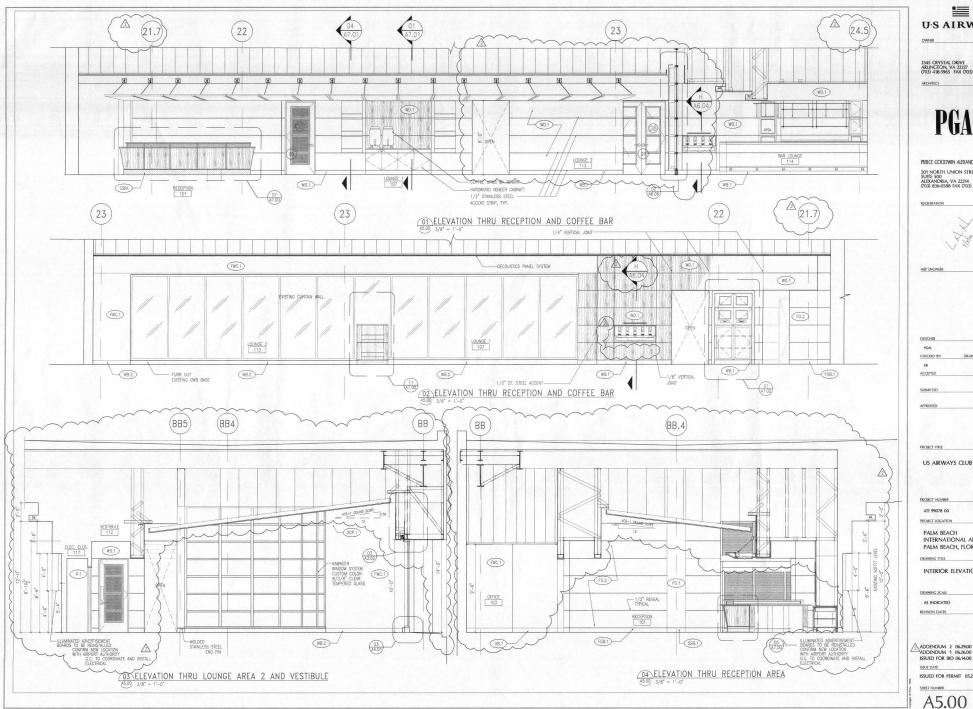

2345 CRYSTAL DRIVE ARUNCTON, VA 22227 (703) 418-5965 FAX (703) 418-7986

PGAL

PIERCE GOODWIN ALEXANDER & LINVILLE 201 NORTH UNION STREET SUITE 500 ALEXANDRIA, VA 22314 (703) 836-0588 FAX (703) 836-8027





INTERNATIONAL AIRPORT PALM BEACH, FLORIDA


INTERIOR ELEVATIONS

ADDENDUM 2 06.29.00 ADDENDUM 1 06.26.00 ISSUED FOR BID 06.14.00

ISSUED FOR PERMIT 05.26.00

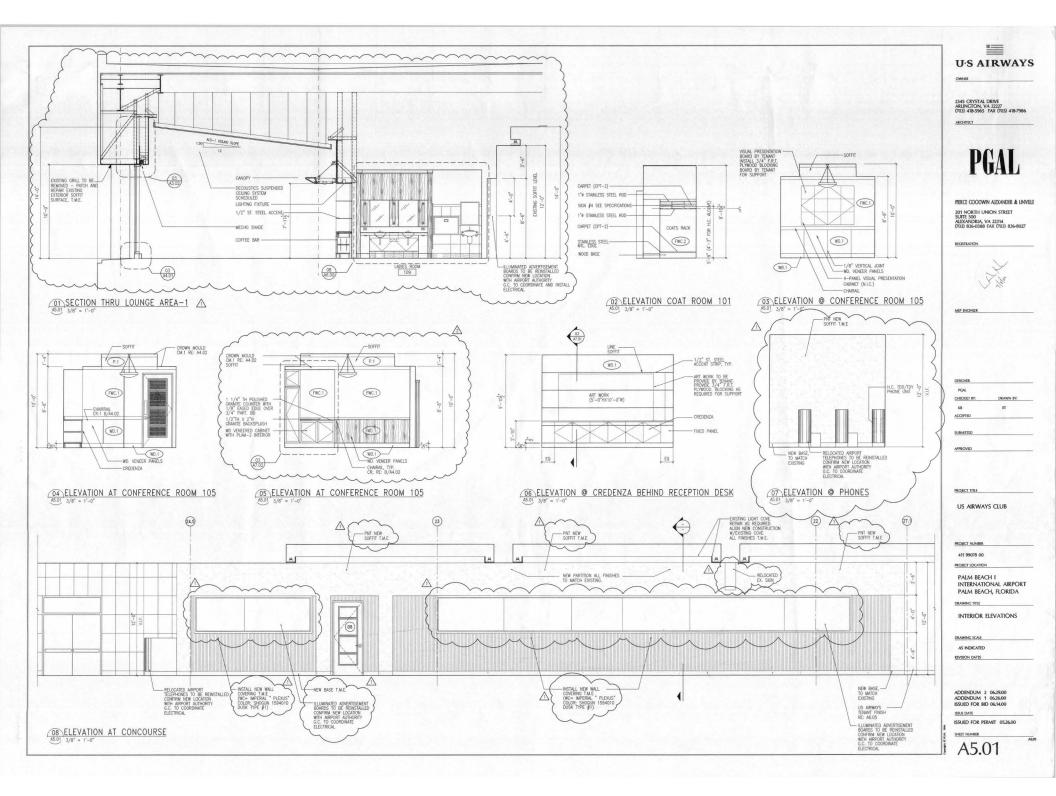

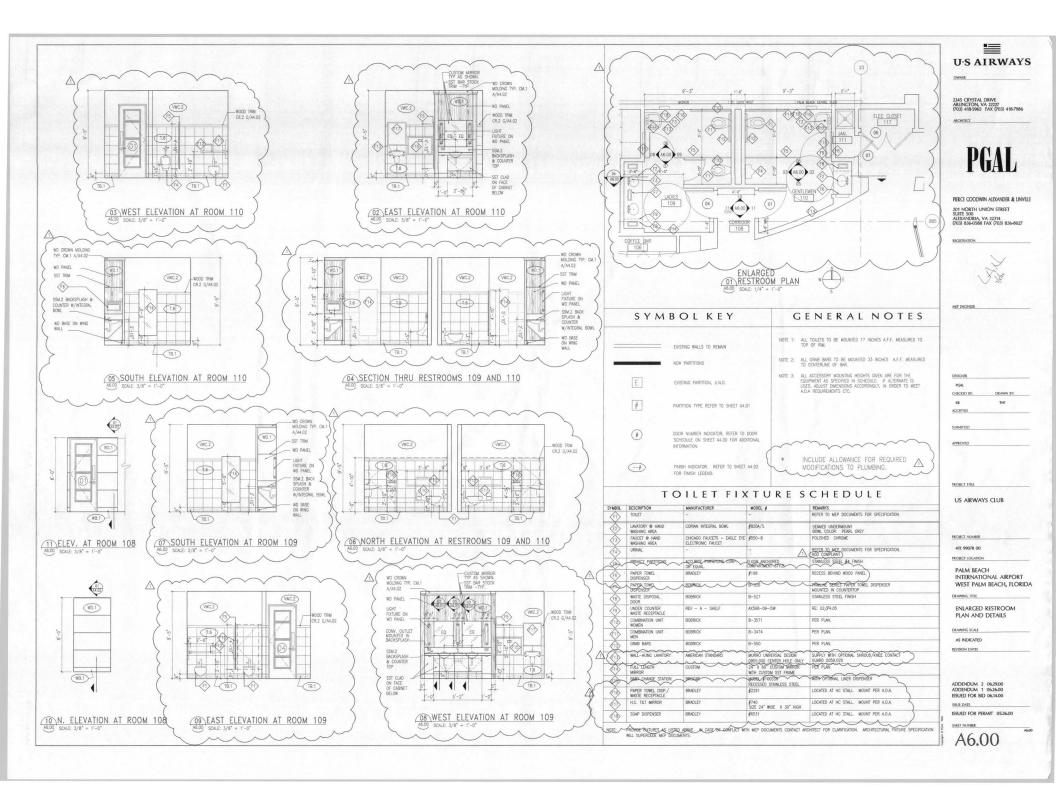

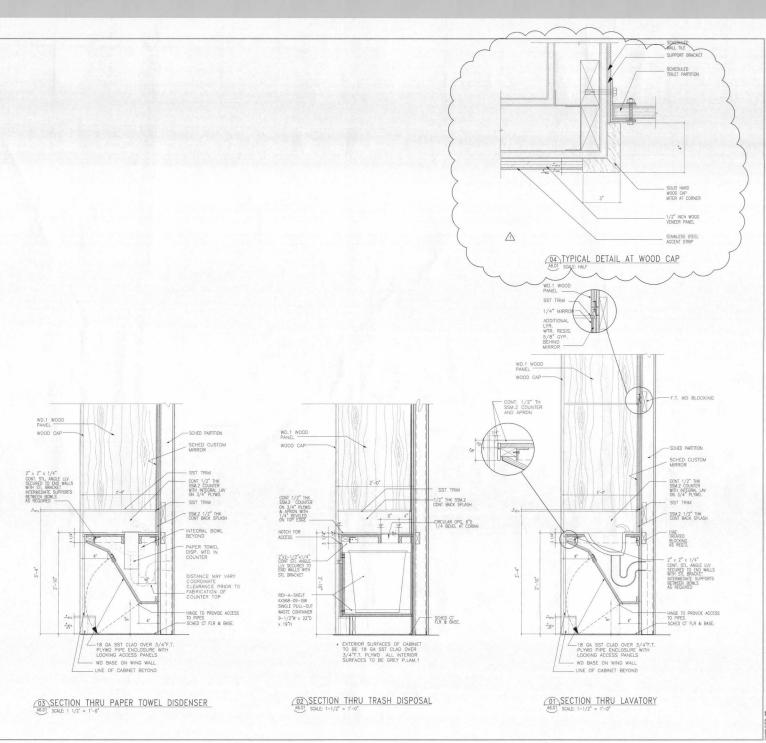

OWNER

2345 CRYSTAL DRIVE ARLINGTON, VA 22227 (703) 418-5965 FAX (703) 418-7986

PGAL

PIERCE COODWIN ALEXANDER & LINVILLE 201 NORTH UNION STREET SUITE 500 ALEXANDRIA, VA 22314 (703) 836-0588 FAX (703) 836-8027

RECISTRATION



MEP INCINIER

| DESCRIE
| PCAL |
| CHECKED BY: | DRAWN BY: |
| KB | TNF |
| ACCEPTED |

SUBMITTED

APPROVED

PROJECT TITLE

US AIRWAYS CLUB

PROJECT NUMBER
411 99078 00
PROJECT LOCATION


PALM BEACH INTERNATIONAL AIRPORT WEST PALM BEACH, FLORIDA


RESTROOM DETAILS

AS INDICATED
REVISION DATES

ADDENDUM 2 0629.00 ADDENDUM 1 0626.00 ISSUED FOR BID 06.14.00

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PROJECT TITLE US AIRWAYS CLUB

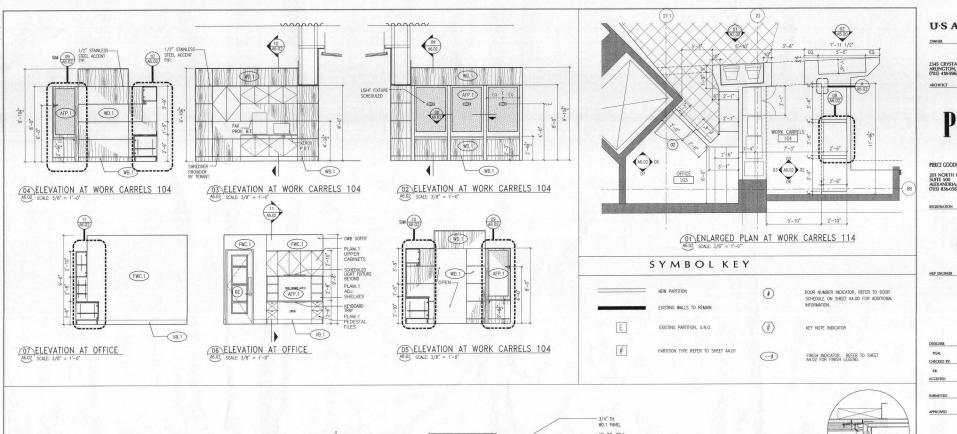PROJECT NUMBER 411 99038 00

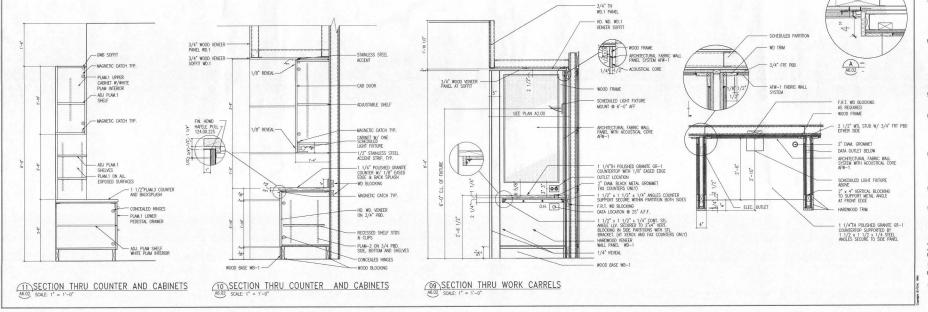PROJECT LOCATION PALM BEACH INTERNATIONAL AIRPORT WEST PALM BEACH, FLORIDA


ENLARGED PLAN AT WORK CARRELS & DETAILS


AS INDICATED

ADDENDUM 2 0629.00 ADDENDUM 1 0626.00 ISSUED FOR BID 06.14.00

ISSUE DATE ISSUED FOR PERMIT 05.26.00

SHEET NUMBER

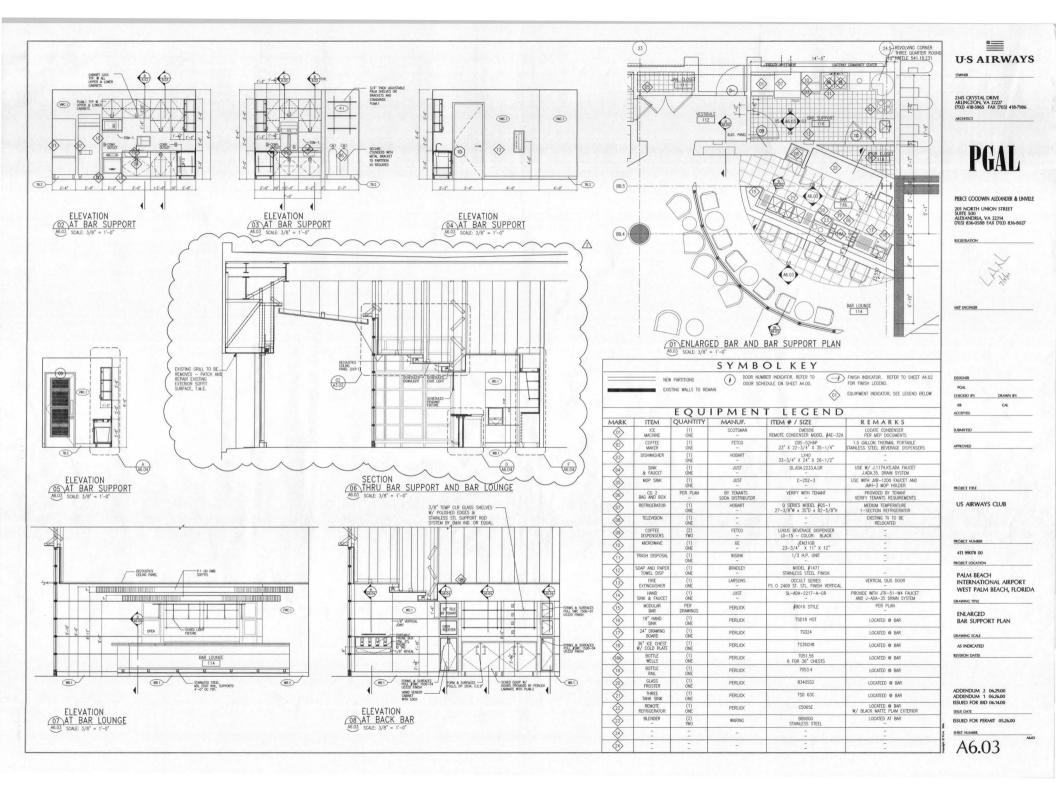

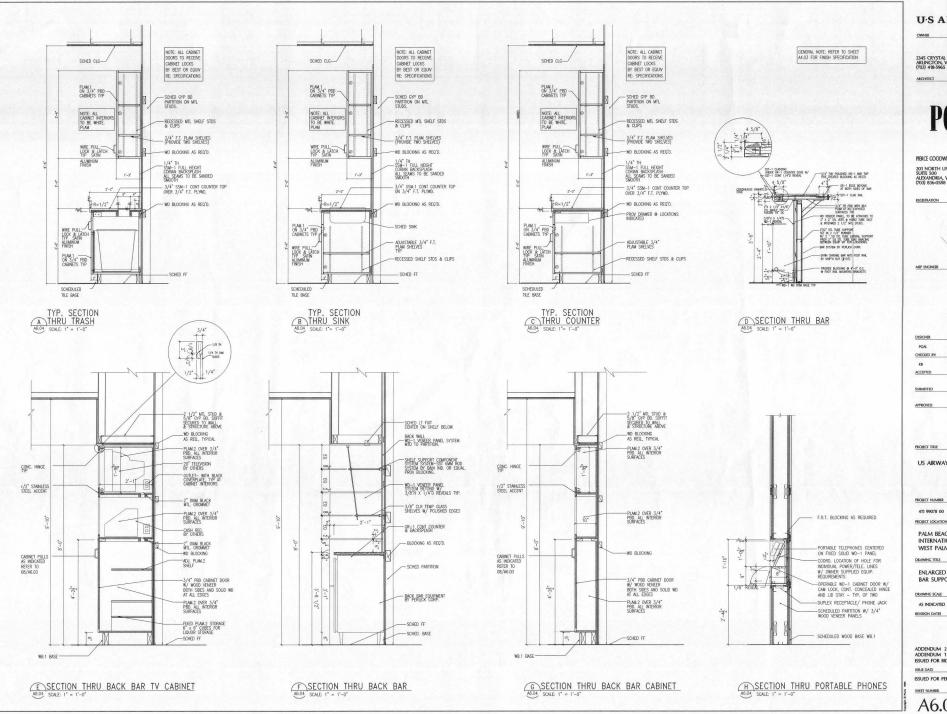

2345 CRYSTAL DRIVE ARLINGTON, VA 22227 (703) 418-5965 FAX (703) 418-7986

ARCHITECT

PIERCE GOODWIN ALEXANDER & LINVILLE 201 NORTH UNION STREET SUITE 500 ALEXANDRIA, VA 22314 (703) 836-0588 FAX (703) 836-8027

RECISTRATION



MEP ENCINEER

DESIGNE CHECKED BY: ACCEPTED

US AIRWAYS CLUB

PROJECT NUMBER 411 99078 00

PALM BEACH INTERNATIONAL AIRPORT WEST PALM BEACH, FLORIDA


ENLARGED BAR SUPPORT PLAN

DRAWING SCALE AS INDICATED REVISION DATES

ADDENDUM 2 06.29.00 ADDENDUM 1 06.26.00 ISSUED FOR BID 06.14.00

ISSUE DATE ISSUED FOR PERMIT 05.26.00

SHEET NUMBER

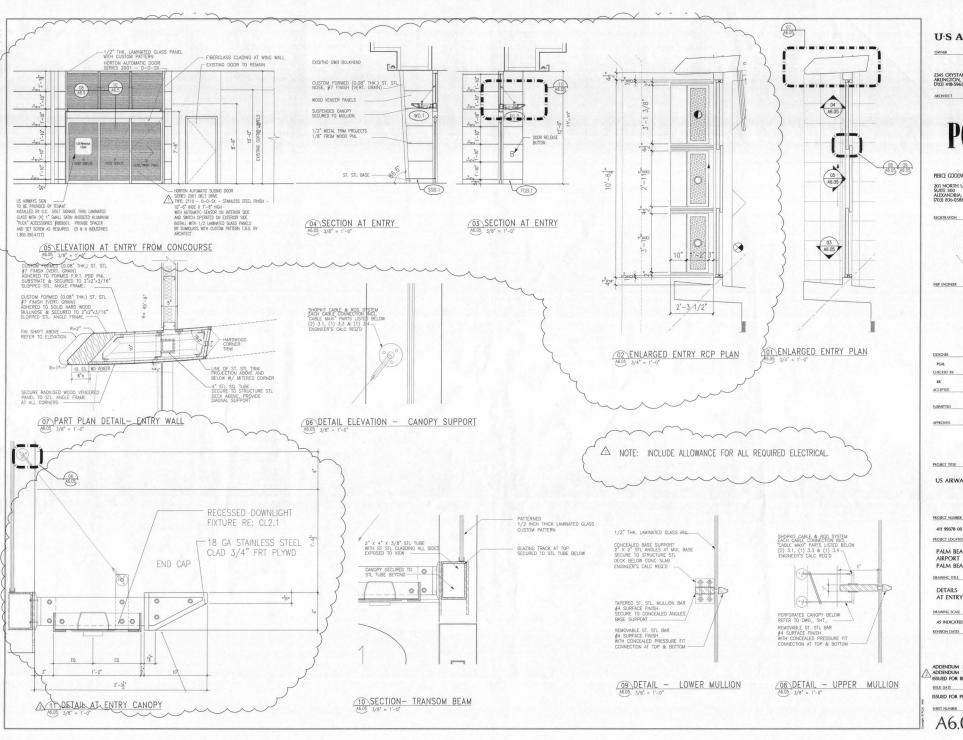

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PIERCE COODWIN ALEXANDER & LINVIII 201 NORTH UNION STREET SUITE 500 ALEXANDRIA, VA 22314 (703) 836-0588 FAX (703) 836-8027



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US AIRWAYS CLUB

PROJECT NUMBER


PROJECT LOCATION PALM BEACH INTERNATION

PALM BEACH, FLORIDA

AS INDICATED

ADDENDUM 2 0629.00 ADDENDUM 1 0626.00 ISSUED FOR BID 06.14.00

ISSUED FOR PERMIT 0526.00

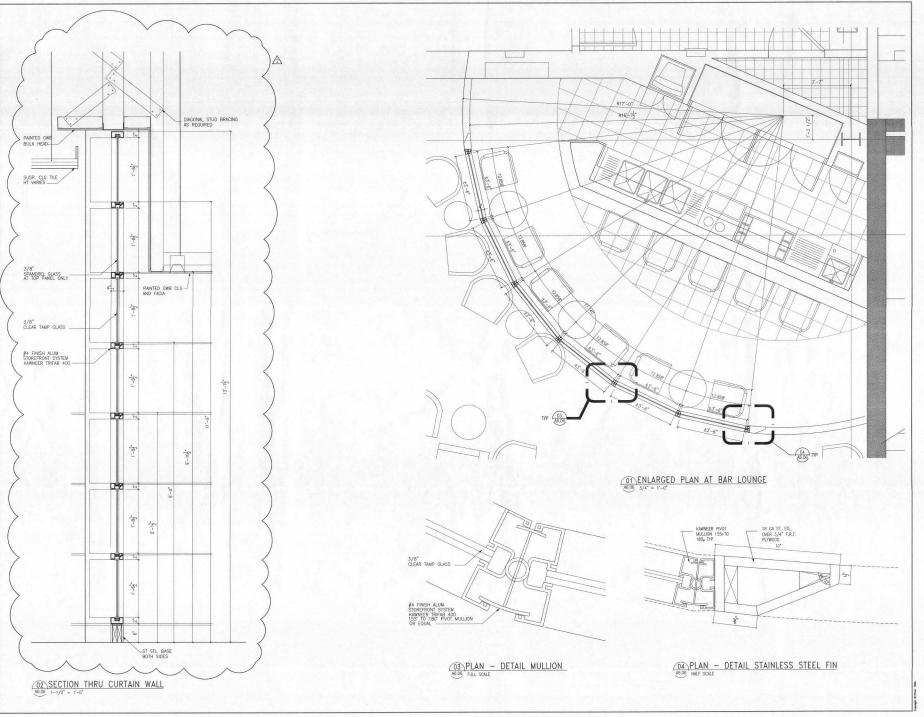



2345 CRYSTAL DRIVE ARLINGTON, VA 22227 (703) 418-5965 FAX (703) 418-7986 ARCHITECT

PGAL

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RECISTRATION



DRAWN BY:
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US AIRWAYS CLUB

PROJECT NUMBER

411 99078 00 PROJECT LOCATION


PALM BEACH INTERNATIONAL AIRPORT PALM BEACH, FLORIDA

DETAILS AT BAR LOUNGE CURTAIN WALL


DRAWING SCALE AS INDICATED REVISION DATES


ADDENDUM 2 06.29.00 ADDENDUM 1 06.26.00 ISSUED FOR BID 06.14.00

ISSUE DATE ISSUED FOR PERMIT 05.26.00

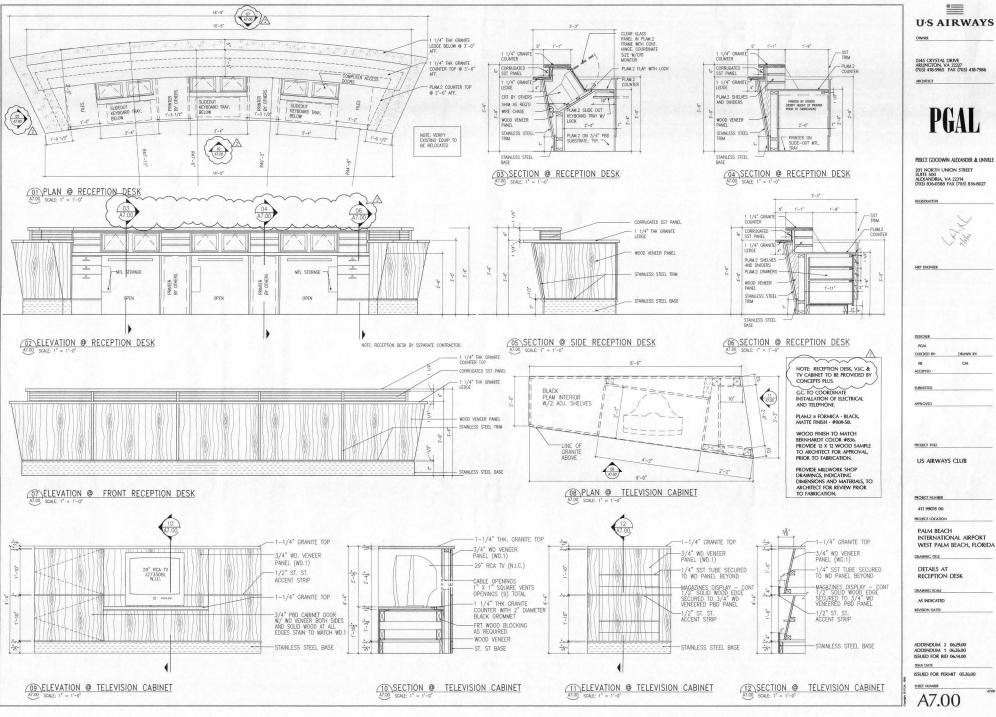

PIERCE GOODWIN ALEXANDER & LINVILLE

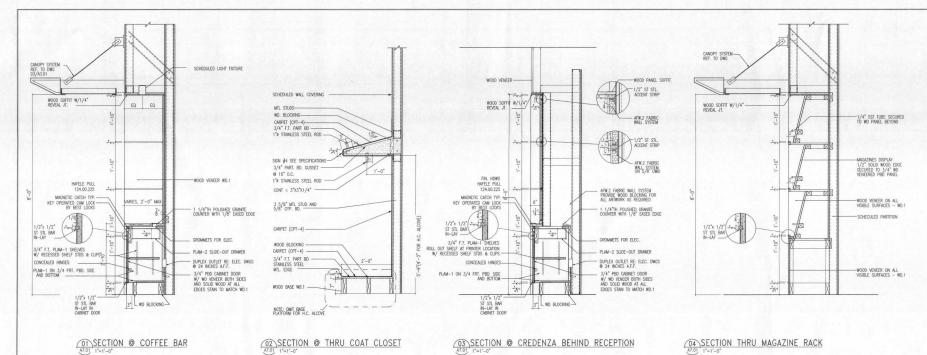

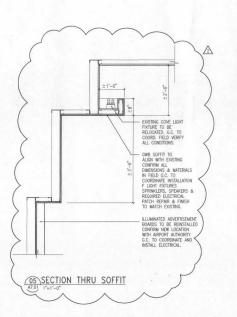

O3 SECTION @ CREDENZA BEHIND RECEPTION 04 SECTION THRU MAGAZINE RACK



2345 CRYSTAL DRIVE ARLINGTON, VA 22227 (703) 418-5965 FAX (703) 418-7986

ARCHITECT

PIERCE GOODWIN ALEXANDER & LINVILLE 201 NORTH UNION STREET SUITE 500 ALEXANDRIA, VA 22314 (703) 836-0588 FAX (703) 836-8027

RECISTRATION



MEP ENCINEER

CHECKED BY:	DRAWN BY:
KB	CAL
ACCEPTED	
SUBMITTED	
APPROVED	N. 160

US AIRWAYS CLUB

PROJECT NUMBER 411 99078 00

PROJECT LOCATION

INTERNATIONAL AIRPORT PALM BEACH, FLORIDA

DRAWING TITLE DETAILS

DRAWING SCALE


AS INDICATED REVISION DATES

ADDENDUM 2 06.29.00 ADDENDUM 1 06.26.00 ISSUED FOR BID 06.14.00

ISSUED FOR PERMIT 05.26.00

SHEET NUMBER

A7.01

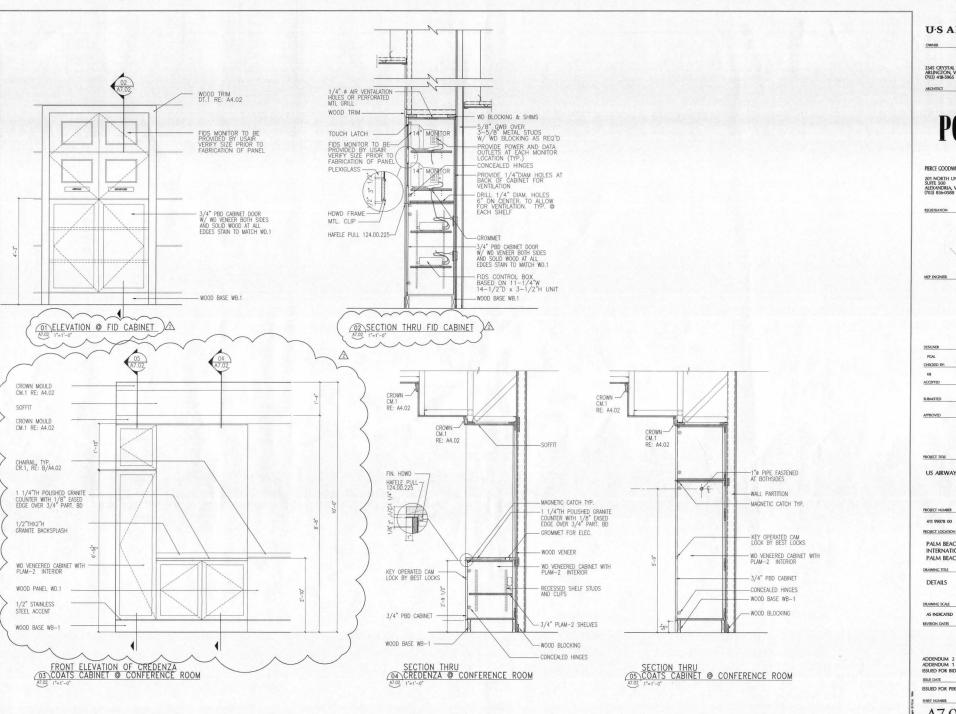



2345 CRYSTAL DRIVE ARLINGTON, VA 22227 (703) 418-5965 FAX (703) 418-7986

PIERCE COODWIN ALEXANDER & LINVILLE 201 NORTH UNION STREET SUITE 500 ALEXANDRIA, VA 22314 (703) 836-0588 FAX (703) 836-8027

REGISTRATION



MEP ENGINEER

DESIGNER

APPROVED

US AIRWAYS CLUB

411 99078 00

PALM BEACH INTERNATIONAL AIRPORT PALM BEACH, FLORIDA

DRAWING TITLE

DRAWING SCALE

REVISION DATES


ADDENDUM 2 06.29,00 ADDENDUM 1 06.26.00 ISSUED FOR BID 06.14.00

ISSUE DATE

ISSUED FOR PERMIT 05.26.00

A7.02



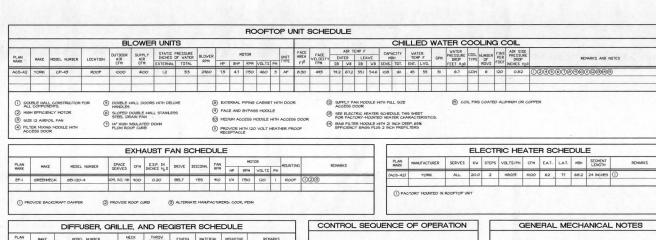

PLAN MARK	MAKE	MODEL NUMBER	NECK SIZE	THROW PATTERN	FINISH	MATERIAL	MOUNTING	REMARKS
CD-I	TITUS	250-AA, TYPE 3	8×8	54	OFF-WHITE	ALIMINIM	LAY-IN	02 0
CD-2	TITUS	250-AA, TYPE 3	10 x 10	54	OFF-WHITE	ALLMINUM	LAY-IN	02 4
CD-3	TITUS	250-AA, TYPE 3	14 × 14	54	OFF-WHITE	ALUMINUM	LAY-IN	02 4
CD-4	TITUS	250-AA, TYPE I	12 × 8	L2C	OFF-WHITE	ALUMINUM	SURFACE	0
CD-5	TITUS	250-AA, TYPE I	18 × 8	L2C	OFF-WHITE	ALUMINUM	SURFACE	0
LD-I	TITUS	ML-31, 2 SLOT	3.25 x 24	ADJUST.	OFF-WHITE	ALUMINUM	CONCEALED	0 3 6
LD-2	TITUS	ML-31, 2 SLOT	3.25 × 60	ADJUST.	OFF-WHITE	ALUMINUM	CONCEALED	0 3 6
Rø-I	TITUS	50F, TYPE 3	8×8	RETURN	OFF-WHITE	ALUMINUM	LAY-IN	02
R6-2	TITUS	50F, TYPE I	12 × 8	RETURN	OFF-WHITE	ALUMINUM	SURFACE	0
R6-3	TITU5	50F, TYPE I	18 × 18	RETURN	OFF-WHITE	ALUMINUM	SURFACE	9
E6-I	тітиз	50F, TYPE 3	10 x 10	EXHAUST	OFF-WHITE	ALUMINUM	LAY-IN	02
EG-2	тітиз	50F, TYPE 3	12 × 12	EXHAUST	OFF-WHITE	ALUMINUM	LAY-IN	00
TG-I	TITUS	50F, TYPE B	8×8	TRANSFER	OFF-WHITE	ALUMINUM	LAY-IN	2 9
T6-2	TITUS	50F, TYPE I	D×D	TRANSFER	OFF-WHITE	ALLMINUM	SURFACE	

TRANSITION TO MATCH CONNECTING DUCT. FURNISH FOR MOUNTING IN 24 x 24 CEILING GRID.	INSULATE BACK OF METAL.	WITH INSULATED OPTIONAL PLENUM

LAN	MAKE	SERIES	SERVES	GPM	SIZE	RATID	METER ΔP	LOSS	SERVICE	REMARKS
PM-I	GERAND	V5	ACS-42	31	1-1/2*	632	18	1.8	CHILLED HATER	02

PLAN MARK	MAKE	MODEL NUMBER	GPM	C _v	SIZE	SERVES	ACTUATOR	P.D. PSIG	REMARKS
CV-I	HONEYWELL	VSOIIN	31	18.7	1-1/4*	AC5-42	PNEUMATIC	2.7	0233
_			+						

THE EXISTING HONEYWELL FACILITY MANAGEMENT SYSTEM (FMS) SHALL PROVIDE FOR GLOBAL CONTROL AND MONITORING OF THE EQUIPMENT AS SPECIFIED HERBIN BELOW, AND AS REQUIRED TO PROVIDE A COMPLETELY FUNCTIONAL, AND OPERATIONAL SYSTEM.

FAN CONTROL: THE AIR HANDLING UNIT FAN IS STARTED HAEN THE HAND-OFF-AUTO SHITCH IS PLACED IN THE "HAND" POSITION, OR BY THE PMS HAEN IN THE "AUTO" POSITION.

TEMPERATURE CONTROL: THE TEMPERATURE CONTROL SCHEME SHALL BE ACTIVATED UPON PROOF OF PAN PLOY. IN THE "OFF" CONDITION THE COOLING CONTROL VALVE SHALL BE FULLY CLOSED.

COCCINE HONG AN ANEXAGEN THE COLLEN HAS TEMPERATIVE COLLING HONG AN ANEXAGEN THE COLLING HAS TEMPERATIVE CONTINUE. AN ANEXAGEN THE COLLING HAS THE CONTINUE. WALVE AND MANTHANT THE COCLING COLLING HAS THE PREMIATION OF POINT OF DEPOSITS. A DUDGETS. A DUDGETS. THE FACE AND SAFE SERVICE AND VARY THE LEAVING AGRETY AND TEMPERATIVE OF HAMINAN THE HAMIN SPACE OF THE PREMIATION COLLING SET POINT OF TOPSATOR ADJUSTABLE.

ALARNS, AN ALARM CONDITION SHALL BE INITIATED HIER THE COLLING COIL LEAVING AIR TRYPERATURE IS 2 DEGREES F (ADJUSTABLE) JACKET THE STEP THAT AND ALL BE ALL AND ALL AND ALL AND ALL BE ALL BE ALL AND ALL AN

ROOF MOUNTED EXHAUST FAN

THE FAN IS STARTED WIEN THE HAND-OFF-AUTO SHITCH IS PLACED IN THE "HAND" POSITION, OR BY THE PMS WIEN IN THE "AUTO" POSITION.

- ALL SUPPLY AND RETURN AIR DUCTS SHALL BE EXTERNALLY INSULATED HITH DUCT WRAP, EXCEPT WE'RE DUCTS ARE LINED FOR NOISE ATTENUATION.
- CHILLED WATER PIPING SHALL BE WELDED, SCHEDULE 40 BLACK STEEL WITH DIELECTRIC FITTINGS AT DISSIMILAR METALS. BRAZED COPPER MAY BE USED WITHIN THE ROOFFOP ANY HANDLING UNIT PIPING ENCLOSURE.
- PROVIDE (/2° BALL VALVE MANUAL AIR VENTS AT ALL HIGH POINTS IN THE PIPING SYSTEM AND AT THE CHILLED MATER COIL, AND 3/4° BALL VALVE DRAINS AT THE LON POINTS.

- PROVIDE SINGLE THICKNESS METAL TURNING VANES IN ALL SQUARE ELBOHS FOR SUPPLY AIR DUCTS ONLY. WERE INEQUAL SQUARE ELBOHS ARE SHOWN, TURNING VANES INTO TRAILING ECOE EXTENSIONS SHALL BE USED.
- DOCUMENTS ARE SCIENATIC IN MATRIX AND DOT INDICATE EVERY BIND, ELBOY, OR OFFIRST REQUIRED IN DICTINOX AND PIPMS. FIELD VIRRIFY ALL DICTINOX STORES AND ELFOYMORS PICK OF PARRICATIONISM PLAYER. PROVIDE MODIFICATIONS PIECE FEDILIZED FOR COORDINATION IN BASE CONTRACT PRICE AT NO ADDITIONAL COST.
- REFER TO PLANS FOR ADDITIONAL NOTES.
- IO. CONDENSATE PIPING SHALL BE COPPER.
- ALL EXISTING PIPING, DUCT AND EQUIPMENT LOCATIONS ARE BASED ON EXISTING CONSTRUCTION DOCUMENTS AND HAVE NOT BEEN FIELD VERIFIED.

- ACCOSTICAL DUCT LINES SHALL BE INFO HICK TO SIZE

 ACCOSTICAL DUCT LINES SHALL BE INFO HICK BOST AND THE ASSTREAM SWEAZE SHALL BE RESTREAM SHALL BE ASSTREAM SWEAZE SHALL BE RESTREAM SHILL BE ACCOSTICAL TO THE ASSTREAM SWEAZE SHALL BE RESTREAM SHALL BE ADDRESSED TO THE SHEET

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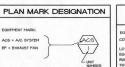
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	AND GRILLE GNATION
ZUPMENT MARK, CELLING SUPPLY DIFFUSER LINEAR DIFFUSER EXHAUST GRILLE RETURN GRILLE TRANSFER GRILLE	UNIT NUMBER CD-X XX CFM AIR QUANTITY

SHEET NO	DESCRIPTION
M-1	SCHEDULES, NOTES AND LEGEND
M-2	DEMOLITION AND NEW WORK FLOOR PLANS
M-3	DETAILS

U·S AIRWAYS

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MEP ENGINEER

JLSD 🧆 1800 Australian Ave. South, Suite 30 West Palm Beach, Florida 33409 (561) 689-2303

FAX 689-2302 CERT. No. 6059 WWW. jlsd.com

MDH CHECKED BY: DRAWN BY: MDD FD ACCEPTED

U.S. AIRWAYS

CLUB

PROJECT NUMBER 100095

PROJECT LOCATION INTERNATIONAL AIRPORT W.P.B. FL.

DRAWING TITLE SCHEDULES, NOTES AND LEGEND


DRAWING SCALE NONE

REVISION DATES

ADDENDUM 2 06.29.00
REVISED PER AIRPORT
OPERATIONS COMMENTS
ISSUED FOR BID 06.14.00

ISSUE DATE ISSUED FOR PERMIT 05-26-00

SHEET NUMBER M-1

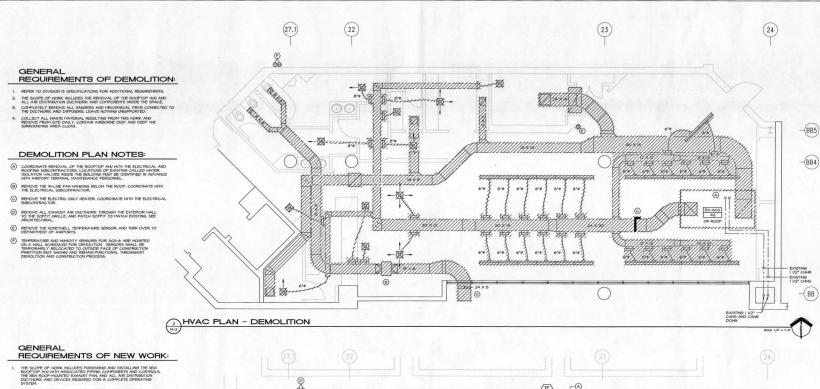


- STEEL SUPPORTING THE ROOF, NOTE THAT THE NEW UNIT IS ROTATED ISO DEGREES FROM THE EXISTING.
- AN AS-BULT DRAMB, HAS NOT BEEN PIELD VERIFIED, AND IS DIAGRAPHAT IN NATURE, VERIFY LOCATIONS ABOVE THE EXISTING CELLING.
- RATE SCHEDULED FOR THE EXISTING ROOFFOP UNIT, PIPING HORK IS LIMITED TO THE VICINITY OF THE ROOFFOP UNIT.

 5. SELECTION AND INSTALLATION OF DIFFUSER COMPONENTS FOR THE DECOUS-
- ALL ROOFING WORK SHALL BE PERFORMED BY A CERTIFIED, APPROVED CONTRACTOR TO MAINTAIN THE ROOF HARRANTY, SEE ARCHITECTURAL.
- PROVIDE DUCT ACCESS DOORS WHERE INDICATED TO ACCOMMODATE AIRPORT TERMINAL MAINTENANCE'S DUCT CLEANING PRACTICE.

NEW WORK PLAN NOTES:

- ACOUSTICALLY LINE THE 12 INCH SQUARE DUCT DROP FROM THE EXHAUST FAN.
- MODIFY CHILLED MATER PIPING TO MATCH THE PIPE ENCLOSURE IN THE NEW AND.
 ACCUSTICALLY LINE THE RESTANGULAR RETURN AIR AND SUPPLY AIR DISTURBER LINES EXTENT SHOULD REPER LINES AND SUPPLY AIR DISTURBER LINES.
- SHEET M-I. DUCT SIZES SHOWN ARE INSIDE CLEAR DIMENSIONS.

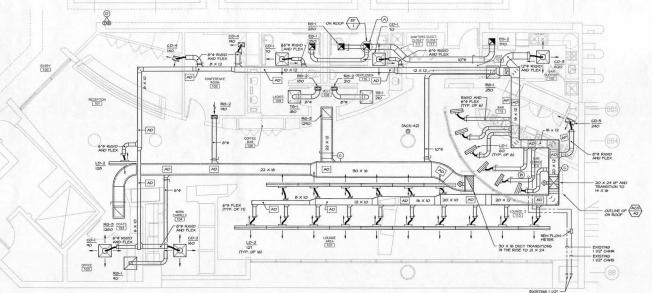

HVAC PLAN - NEW WORK



U·S AIRWAYS

OWNER

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ARCHITECT

Architecture
interior Architecture
PGAL
Engineering

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DETRATION



MEP ENGINEER

JLSD

ohnson, Levinson, Slider, Davila, Inc

C O N S U L T I N G
E N G I N E E R S

Of Australian Ave South Suite 3

1800 Australian Ave. South, Suite 301 West Palm Beach, Florida 33409 (561) 689-2303 FAX 689-2302 CERT. No. 6059 WWW. jlsd.com

MPJ

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CHECKED BY: DRAWN BY:

MDD

ACCEPTED

SUBMITTED

SOSMITTED

PROJECT TITLE

U.S. AIRWAYS CLUB

PROJECT NUMBER

100095

PROJECT LOCATION

P.B.I.A. INTERNATIONAL AIRPORT

DEMOLITION AND NEW WORK FLOOR PLANS

DRAWING SCALE


W.P.B. FL.


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ISSUED FOR PERMIT 05-26-00

M-2



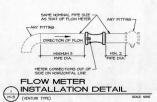


- (I) MANUAL COIL VENT, 1/4" BALL VALVE.
- 3 Y-TYPE STRAINER, BRONZE CONSTRUCTION, STAINLESS STEEL 20 MESH SCREEN-MLESSCO 351.
- (4) THERMOMETER, 4" SCALE ADJISTABLE ANGLE, RANGE 0-100 DEGREES F WITH 3/4 INCH THERMOMELL.
- ⑤ GAGE COCK, I/4° BALL VALVE.
- (6) NOT USED
- (7) 1/2" BALL VALVE WITH HOSE END CONNECTION.
- MANUAL AIR VENT. 1/4" BALL VALVE, LOCATE AT PIPING HIGH POINT
- (9) LOCATE FLANGES / UNIONS IMMEDIATELY ABOVE COIL PULL SPACE TO ALLOW FOR COIL PULL WITH MINIMAN REMOVAL OF PIPING.
- THO-HAY CONTROL VALVE, SEE SCHEDULE
- (I) SAME AS ITEM #2, EXCEPT WITH ADJUSTABLE MEMORY STOP
- (2) FLOW VENTURI SHOWN IN RETURN, SEE SCHEDULE FOR SIZE.
- (3) UNION
- @ REDUCER WHERE REQUIRED.
- (5) DIELECTRIC FITTINGS AT CONNECTION TO COIL

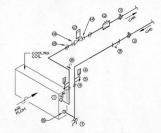2 AHU COOLING COIL PIPING SCHEMATIC


PIPING SCHEMATIC NOTES

- PIPING SHALL BE ARRANGED TO PROVIDE UNOBSTRUCTED ACCESS TO FILTER SECTION, FAN SECTION, AND COIL SECTION.
- 2. PROVIDE EXTENDED VALVE STEMS IN ORDER FOR HANDLES TO CLEAR PIPE INSULATION
- 3. CONTROL VALVE ACTUATOR SHALL BE INSTALLED IN AN UPRIGHT POSITION

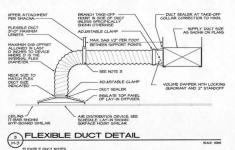

FLEXIBLE DUCT NOTES

- I. FLEXIBLE DUCTS SHALL BE ONE-PIECE AND SHALL NOT BE SPLICED TOGETHER
- EXTEND FLEXIBLE DUCT INSULATION TO DUCT/DIFFUSER PANEL INSULATION AND SEAL WITH MASTIC.
- MINIMUM I' HIDE 22 GAUSE GALVANIZED STRAP HANSER WITH HEMMED EDGES PER SMACNA FISURE 3-IO.
- FLEXIBLE AIR DUCT SHALL BE PULLY EXTENDED AND NOT COMPRESSED WITH ELBOW RADIUS NO LESS THAN R/D = 1,0.
- 5. ROUND RIGID DUCT TAKE-OFF SIMILAR.

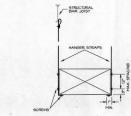


DUCT HANGER DETAIL

SCALE: NONE


- I. USE TRAPEZE HANGERS FOR DUCTS WIDER THAN 54 MAXIMIM SPACING BETHEEN HANGER LOCATIONS SHALL BE 8'-0' PER PAIR.

DUCT HANGER NOTES

3. STRAPS SHALL BE MINIMIM IT X 22 GASE GALVANIZED STEEL, SEE SMACNA TABLE 4-L

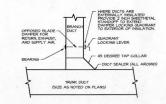


SBRANCH DUCT TAKE-OFF DETAIL

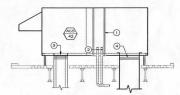

6 ROOF TOP AIR HANDLER UNIT DETAIL

ROOF TOP AIR HANDLER UNIT DETAIL NOTES

- (I) EXTERNAL PIPING CABINET
- 2) CHAS & CHAR TO AH COIL, SEE COOLING COIL PIPING SCHEMATIC
- (3) UNIT RETURN AIR OPENING
- (4) FLEXIBLE CONNECTION

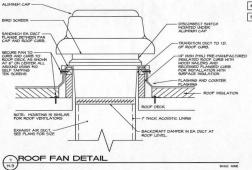

© CHILLED WATER SINGLE ZONE AIR HANDLING UNIT


9

THO STAGES OF DUCT HEAT

POINT POINT DESCRIPTION POINT POINT DESCRIPTION 1 6 CHILLED WATER VALVE EF START/STOP 2 AHU FAN STATUS 7 F& B DAMPER ACTUATOR 3 FIRST STAGE DUCT HEAT OA DAMPERS OPEN/CLOSE 4 SECOND STAGE DUCT HEAT 9 COLD DECK TEMPERATURE 5 SPACE TEMPERATURE SENSOR

1 6

EXHAUST FAN

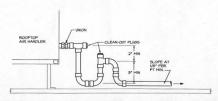

(1) ROOFTOP AH CONDENSATE DRAIN DETAIL

ROOFTOP AH CONDENSATE DRAIN NOTES

- CONDENSATE DRAIN SHALL BE PIPED FULL SIZE OF UNIT CONNECTION
- CONTINUE DRAIN ACROSS ROOF TO NEAREST ROOF DRAIN TO MATCH EXISTING INSTALLATION.

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POWER HIRING TO STARTER BY DIVISION IS

2

SPACE TEMPERATURE T



MEP ENGINEER



DESIGNER MDH

CHECKED BY: DRAWN BY: MDD FD ACCEPTED

SUBMITTED

PROJECT TITLE U.S. AIRWAYS

PROJECT NUMBER 100095

CLUB

PROJECT LOCATION

INTERNATIONAL AIRPORT W.P.B. FL.

DRAWING TITLE DETAILS


DRAWING SCALE

REVISION DATES

ADDENDUM 2 0629.00
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ISSUE DATE ISSUED FOR PERMIT 05-26-00

SHEET NUMBER M-3

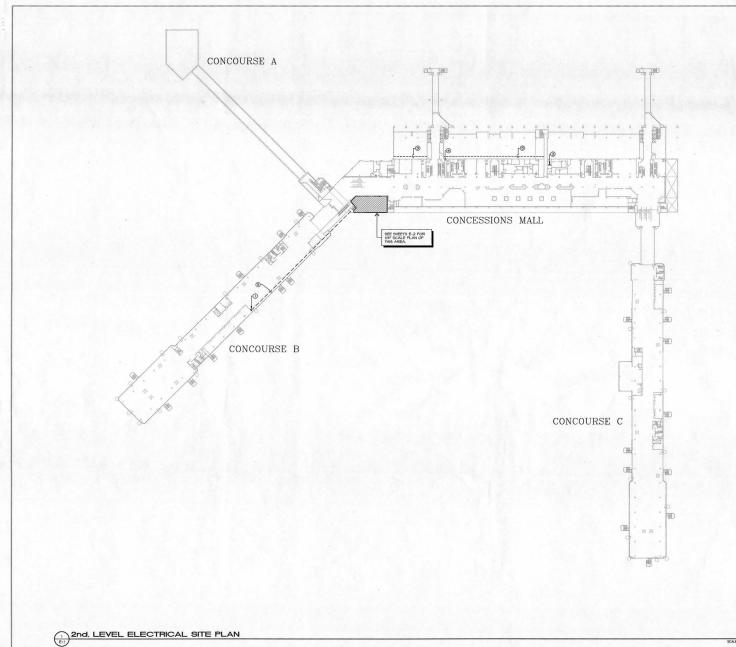

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CHECKED BY: JJP ACCEPTED

SUBMITTED

PROJECT TITLE

U.S. AIRWAYS CLUB

PROJECT NUMBER 100095

> PROJECT LOCATION P.B.I.A.

INTERNATIONAL AIRPORT W.P.B. FL.

DRAWING TITLE

SECOND LEVEL ELECTRICAL SITE PLAN

REVISION DATES

ADDENDUM 2 06.29.00
REVISED PER AIRPORT
OPERATIONS COMMENTS
ISSUED FOR BID 06.14.00

ISSUE DATE

ISSUED FOR PERMIT 05-26-00 SHEET NUMBER


E-1


DRAWING INDEX DESCRIPTION
ELECTRICAL SITE PLAN
ELECTRICAL PLAN
NOTES, LEGEND AND SCHEDUL


EXISTING PANEL EASTERN #4" ON THE GROUND FLOOR.

2 EXISTING MAIN FIRE ALARM CONTROL PANEL. EXISTING COMMUNICATION CABLE TRAY. EXISTING MINIPLEX SECURITY ALARM PANEL LOCATED IN THIS ROOM.


PLAN NOTES

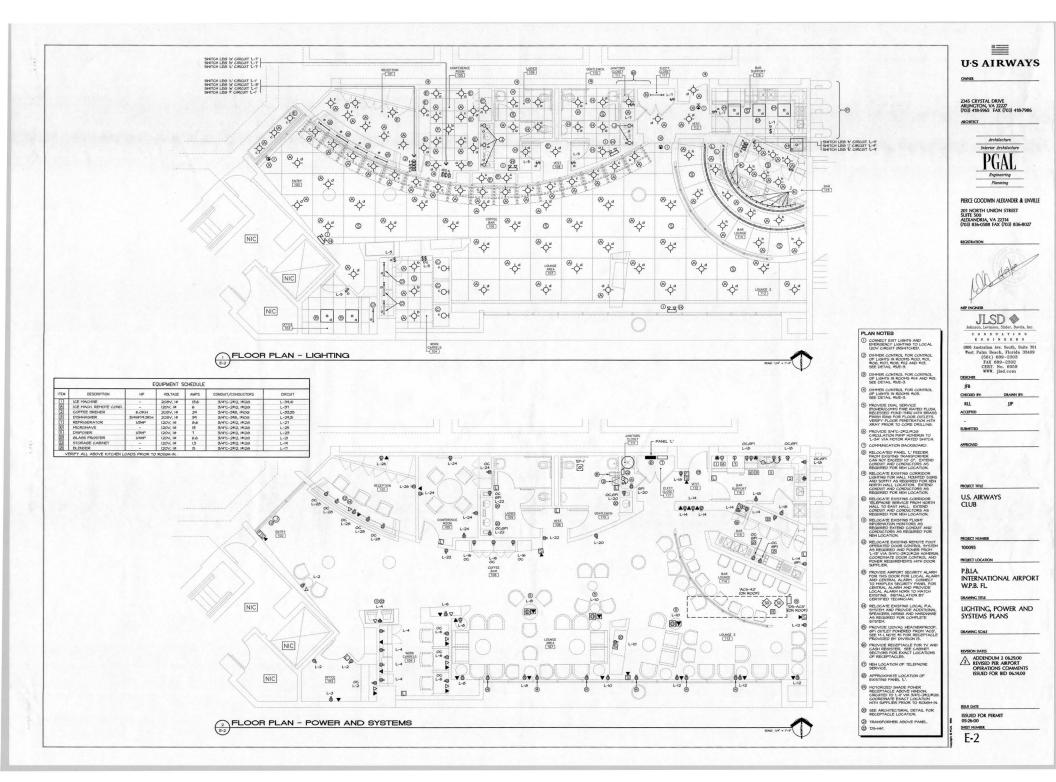

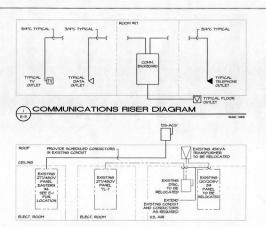


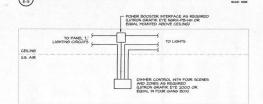

POWER RISER DIAGRAM

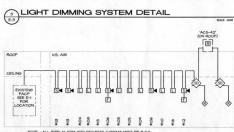

	NOTE: ALL FIRE ALARM AND SECURITY CONDUIT MUST BE R.G.S.	
	FIRE ALARM RISER	
E-3/	ALL DEVICES SHALL BE COMPATIBLE WITH EXISTING CONTROL PANEL AND INSTALLED BY CERTIFIED TECHNICIAN.	SCALE: NO

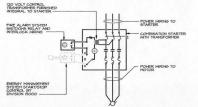

N	
MOTOR STARTER INTERLOCK SCHE	MATIC
E-3	SCALE NONE

SITE CONSTRUCTION NOTES:

THE CONTRACT DOUBLESS MAY NOT RETILED ALL DESITING SERVICES OR SIGN THEM IN THE EMACT OR DESITING LOCATIONS AND OFFICE RELEGIA SERVICE. AN SERVICE HAT IS BITISHETHED THE CONTRACTOR PHINE OR CONTRACT DOUBLESS OF THE DESIGNATION LITTLE ABOVE OR BELOW GRADE, HETTER SIGNA OR NOT SERVICE ON ON THE CONTRACT DOUBLESS. APPROVED BY THE ARCHITECT OR BEGINNESS. OF THE CONTRACT DOUBLESS, APPROVED BY THE ARCHITECT OR BEGINNESS REVIEW OF THE CONTRACT, ALL SERVINESS WHALE SERVINESS.

TX.	MANUFACTURER	CATALOG NUMBER	LAMPS	TYPE OF FIXTURE	REC	SUR	SUS	VOLTS	NOTES
(A)	CON-TECH	CTRI602N-P-BLK	50W MRI6 HIDE FLOOD	DOWNLIGHT	•			120V	NOTE #
B	LIGHTOLIER	VRA264LP3200C	5-F9ITAUI	2×2 TROFFER 4 CELL LOWER	•			120V	NOTE #
0	ESTILUZ	A-1245	аютз	HALL SCONCE	•			120V	NOTE #
0	LIGHTOLIER	TCU2OW-EL	I-FITTO	UNDERSHELF 24 UB*	•			120V	NOTE #I
€	CON-TECH	CTRI625-NK	50H MRI6 NARROH SPOT	DOWNLIGHT	•			120V	NOTE #
Ð	coco	22323-U	3-PL26DTT	UPLIGHT			•	1200	NOTE #1,2
0	CON-TECH	5L,4500DS-PL 14 3/4	50H MRI6	RAIL SYSTEM DOWNLIGHT	•			1200	NOTE #
8	CON-TECH	5L4500-PL 17 1/3	50H MRI6	RAIL SYSTEM DOWNLIGHT	•			120V	NOTE #
Ð	KURT VERSEN	P426	1-92W TRIPLE TUBE	DOWNLISHT	•			1200	NOTE #
0	вото	9752/SATIN CHROME	I-FITTO	DECORATIVE SCONCE	•			120V	NOTE #
0	SPECIALTY LIGHT BELFER	200VT-5 2855-FX2-I8ID	FIBBX 8" O.C.	COVE LIGHT	•			1200	NOTE #1,2,3
0	LIGHTOLIER	XR26VA2U4LE	2-F32T8U6	2x2 TROFFER	•			120V	NOTE #
N	COLUMBIA	CH4-192-EB8120	I-F52T8	FLUOR, STRIP		•		120V	NOTE #I
0	DUALLITE	LZ-2	INCLUDED	BATTERY PACK		•		120V	
8	DUALLITE	LXSRME	LED	EXIT LIGHT		•		120V	

				EXHAU	ST FAN SCHE	DULE			
NO.	HP/WATTS	VOLTAGE	LOCATION	CIR NO.	CONDUIT & WIRE	MOUNTING	DISCONNECT	INTERLOCK	REMARKS
EP-1	1/4	120V/14	RESTROOMS	L-15	3/4"C-2#12J#12@	IN-LINE	BY MECH	AC5-42	-

GENERAL ELECTRICAL NOTES

- ALL ELECTRICAL HORK SHALL COMPLY HITH NATIONAL ELECTRICAL CODE, THE NATIONAL FIRE CODES, THE AMERICANS HITH DISABILITIES ACT, AND ALL APPLICABLE LOCAL CODES AND ORDINANCES.
- THE CONTRACTOR SHALL THOROUGHLY REVIEW THE PROJECT TO ENSURE THAT ALL WORK SHALL MEET OR EXCEED THE ABOVE REQUIREMENTS. ANY ALLEGED DISCREPANCIES SHALL BE BROUGHT TO THE ENSINEER'S ATTENTION PRIOR TO BID.
- THE CONTRACTOR IS DIRECTED TO OBTAIN COPIES OF ALL RELATED PLANS, SPECIFICATIONS, SHOP DRAWINGS AND ADDRIGUM TO COORDINATE THE RELATED HORK AND SCHEDULING.

- HEGHANICAL AND ELECTRICAL EXIMPENT HAVE BEEN LOCATED AND ARRANGED TO MININEZ THE INTERFERENCES OF EXIMPENT AND STRICTURE. THE CONTRACTOR SHALL THE COUNTRY FAMILIARIZE HINGELY HITH THE HORK TO AND RIGHTLE REPORT OF THE FAMILIARIZE HINGELY HITH THE HORK TO AND RIGHTLE REPORTER HOW TO FROM THE CONTRACTOR OF THE COMPANION AND THE COMPANION AND THE COMPANION. THE COMPANION THE COMPANION, THE COMPANION REQUIRED TO RECOVER THE COMPANION THAT COMPANION THE COMPANION.
- ALL PANELBOARDS SHALL BE PROVIDED WITH A TYPENRITTEN SCHEDULE SHOWING CIRCUIT NUMBERS AND A COMPLETE DESCRIPTION OF EACH CIRCUIT.
- MINIMUM TRADE SIZE CONDUIT PERMITTED SHALL BE 3/4 INCH UNLESS NOTED OTHERWISE.
- ALL CONDUCTOR METAL SHALL BE COPPER WITH 600 VOLT INSULATION TYPE THIN. (MINIMUM SIZE SHALL BE #12AH6..) CONTRACTOR SHALL ADJUST MIRE AND CONDUIT SIZES IF OTHER INSULATION TYPES ARE USED.

- ALL CONDUIT RUNS SHALL BE CONCEALED UNLESS SPECIFICALLY NOTED OTHERWISE.
- THE FIXTURE SCHEDULE IS FOR REFERENCE ONLY. MODEL NAMBERS LISTED MAY NOT INCLIDE ALL REGURED OPTIONS. REFER TO SPECIFICATIONS FOR ADDITIONAL INFORMATION. EQUIA. FIXTURES OF OTHER MANIFACTURES MAY BE SUBSTITUTED AS EQUIAL. BY LUBSTITUTIONS ARE SUBJECT TO APPROVAL AS EQUIAL BY THE EMSINEER.
- ALL EXIT LIGHTS SHALL BE PROVIDED WITH BATTERY BACKUP AND UNIVERSAL MOUNTING BRACKETS. THE CONTRACTOR SHALL VERIFY ALL DIRECTIONAL ARROWS PRIOR TO ORDERING FIXTURES.
- THE CONTRACTOR SHALL RIRNISH THE AIR CONDITIONING SUBCONTRACTOR AND THE CEILING SUBCONTRACTOR COPIES OF APPROVED LIGHT FIXTURE SHOP DRAWINGS.
- ALL RECESSED LIGHTING FIXTURES IN FIRE RATED CEILINGS SHALL BE TENTED TO COMPLY WITH THE APPLICABLE CEILING RATING. THE CONTRACTOR SHALL VERIFY REQUIREMENTS.
- COMMINICATION CONDUITS ARE TO BE LONG RADIUS TYPE AND SHALL CONTAIN PULL HIRES. PROVIDE PLATES FOR ALL CUTLETS.
- 14. ALL SPECIAL PURPOSE OUTLETS SHALL BE PROVIDED TO MATCH EQUIPMENT TO BE SUPPLIED.
- THE PLANS INDICATE THE DESIRED ARRANGEMENT AND GENERAL LOCATIONS OF LIGHT FIXTURES. THE ARCHITECTURAL PLANS INDICATE ADDITIONAL DATA AS TO THE FINAL FIXTURE PLACEMENT.
- 21. ALL PANELBOARDS, SHITCHES AND CIRCUIT BREAKERS SHALL BE ITE, SQUARE D. GE, OR CUTLER HANNER.
- 22. ALL CONDUITS SHALL HAVE A SEPARATE GREEN GROUND CONDUCTOR INSTALLED FOR GROUNDING.
- 23. THE CONTRACTOR SHALL VERIFY CEILING TYPES AND INSTALLATION REQUIREMENTS PRIOR TO ORDERING LIGHT FIXTURES.
- ALL DISCONDECT SKITCHES SHALL BE THE HEAVY DUTY TYPE WITH BUSSMAN TIME DELAY, DUAL ELEMENT AND CURRENT LIMITING FUSES.
- 26. ALL EMPTY CONDUITS SHALL CONTAIN JET LINE #232 POLYOFIN 200 LB. TEST.
- ALL WORK SHOWN ON THE ELECTRICAL PLANS SHALL BE PERFORMED BY THE CONTRACTOR INLESS NOTED OTHERWISE.
- 28. ALL EXIT FIXTURES SHALL BE CONNECTED TO THE BUILDING LIGHTING PANEL UNSWITCHED.
- 24. ALL SURGE PROTECTED OUTLETS SHALL BE EQUAL TO HUBBELL #5352 IS.
- EQUIPMENT INSTALLED MITHIN CONCEALED SPACES SHALL HAVE REASONABLE ACCESS PARELS PROVIDED NEARBY FOR INSPECTION, TESTING AND SERVICE CONSIDERATIONS.
- 32. REFER TO SPECIFICATIONS FOR MORE INFORMATION.

Ri	US A	IPS.						BUS				200	T B	JS A	MPS
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		-	DOOR #156	0	3	15	39		40	20	3	DOOR #55	1		
	-		DUCK TOO		-	- 52	AI		42	20	15		1	-	
- 0	ATED	VOI.	TAGE: 2TT/48OV	3 PHA	SE. 4	MPF	71	-	1 44	FFF	0.15 (4)BOTTOM: ()TOP FROM: .	_	_	-
			()100 (•)225 ()400		SC, 4	MINE.	_	_	_			AR ()IS ()IS NOT PROVIDE	n.	_	-
- /) MAIN	HIGS	MLA	_	_	_			US IS ()FULL ()HALF SIZE		_	-
-			XES=()12 ()20 ()			2146.7	_		_			R LATCH () IS () IS NOT F		ven.	_
			D IS ()FUSED ()BOLT			DEAVE	n TVD	c	_			OR ()IS ()IS NOT PROVIDE		ALU .	_
			ERS ARE RATED TO INTER						Line					HEAR	en
-	-	L'Arci	ENS ARE MAILED TO MILE	mor i	STION	Circo	011	O III C				of pure unit I live in	-		-
_															_
LOC	OITAC	N: RC	DOM #IIT			PANE	LBO	ARD :	SCH	DULE		EXISTING PANI	EL L		
_	JS A			_	_	_	_		_	_	_		T 0	JS A	100
		C	LOAD		POLES	AMPS	CIRC	BUS A R C	CIRC	AMPS	POLES	LOAD			C
A	8	C	LIGHTING	0	-	20		ABC	-	_		RECEPTACLES (1	A	В	C
	-	-		0	1	20	1	TI	2	20	1	RECEPTACLES ()	6	-	-
13	13		LIGHTING	U	1	20	3	1	4	20	1		1	6	
13	-	10	LIGHTING		1	20	5	1 1	6	20	1	RECEPTACLES (I)			6
	-	10													
9		10	LIGHTING	000	1	20		•		20			6	-	-
	ю		LIGHTING	0	1	20	9		10	20	i	RECEPTACLES (6	
q		8	LIGHTING MOTORIZED SHADE	0	1	20	9		10	20	1	RECEPTACLES (1)		6	6
			LIGHTING	0	1 1 1	20	9		10	20		RECEPTACLES (6	

BL	IS AN	APS	LOAD			AMPS		BUS			POLES	LOAD	8	US A	MPS
A	В	C	LOAD		POLES	AMPS	CIRC	ABC	UKU.	AMPS	POLES	LUAD	A	B	C
13			LIGHTING	0	1	20	1	• 1 1	2	20	- 1	RECEPTACLES	D 6		т
	13		LIGHTING	(1)	1	20	3	+++	4	20	- 1	RECEPTACLES (5	6	
		10	LIGHTING	0	1	20	5	I →	6	20	1	RECEPTACLES	1		1 6
q			LIGHTING	(1)	1	20	7	•	8	20	1	RECEPTACLES () 6		
	10		LIGHTING	0	1	20	9	+ +	10	20	- 1	RECEPTACLES	(I)	6	Т
		8	MOTORIZED SHADE	0	-	20	11	l ♦	12	20	1	RECEPTACLES (5		1
6			SLIDIING DOOR	0	1	20	13	+	14	20	1	RECEPTACLES	1 6		П
	6		EF-1'	(1)	1	20	15	H • 1	16	20	1	RECEPTACLES (5	6	Т
		15	BLENDER	2 (1)	1	20	17	 	18	20	1	RECEPTACLES	0		1
2			STORAGE CABINET	22(1)	-	20	19	•	20	20	1	RECEPTACLES () 6		П
	7		GLASS FROSTER	20 (1)	1	20	21	H++	22	20	- 1	RECEPTACLES	0	6	Т
	1	7	DISPOSER	III(I)	1	20	23	 	24	20	- 1	RECEPTACLES (51		1
13			MICROHAVE	(D) (M	1	20	25	 	26	20	- 1	RECEPTACLES	0 6		
	q		REFRIGERATOR	10	1	20	27	l++⊢	28	20	1	RECEPTACLES ()	6	
		34	DISHWASHER	3 3	2	50	29	 	30	40	2	HATER HEATER	3		12
34	2007			-	-		31	•	32		-		24		
	29		COFFEE BREVER	2 3	2	40	33	1	34	20	1	CIRC. PUMP	3	3	
	-	29			-	-13-	35	l⊢l •	36	20	1	SPARE (١.
6			ICE MACH, RE. COND.	(A) (I)	1	20	37	•	38	20	1.	SPARE	3 -		Т
	14		ICE MACHINE	110	2	20	39	1	40	20	1	SPARE (0	-	Т
		14			-		41	H •	42	20	1	SPARE	3)		1
R	ATED	VOLT	TAGE: 120/208V	3 PHA	SE, 4	MRE				FEE) IS ()BOTTOM: ()TOP FROM:	TL-I'		
R	ATING	IS ()100 (e)225 ()400	AMPS		2				GRO	UND BA	AR ()IS ()IS NOT PROV	DED		
()MA	IN B	REAKER ISO AMPS () MAIN	LUGS (ONLY				NEU	TRAL B	US IS ()FULL ()HALF SI	3		
BI	RANC	H PO	LES= ()12 ()20 (30 (0)	42					KEY	ED DOO	R LATCH ()IS ()IS NOT	PROVI	DED	
P	ANELE	BOAR	D IS ()FUSED (•)BOL	T IN CIR	CUIT B	REAKE	R TYP	E		HING	DO DO	OR ()IS ()IS NOT PROV	DED		

Α	NELBO.	A	RD N	OTES:	
0	EXISTING	c	IRCUIT	BREAKER	To

- REUSED. MODIFY LOAD AND SCHEDULE AS INDIGATED.

- S NEW CIRCUIT BREAKER TO MATCH
- DISCONNECT SWITCH SCHEDULE VOLTAGE LOCATION 60A/2P/40ADEF 208V/III ROOM HIII L-30,32 3/4*C-2*8),*IOS 460V/39 AC5-42 EASTERN #4-32,34,36 3/4*C-3*8),*IOS

LOAD CALCULATION	
	PANEL L
LIGHTING (DIV. LOAD PER NEC 220-3)	6.4 K)
RECEPTACLES (DIV. LOAD PER NEC 220-13)	10.1 KJ
MISC. EQUIPMENT	7.0 KJ
KITCHEN EQUIPMENT	16.0 KJ
A/C EQUIPMENT	0.0 KJ
TOTAL KW	40.0 KJ
TOTAL AMPS @ 120/208V	III AMPS
TOTAL AMPS 8277/480V	48 AMPS

	ELECTRICAL S	YMBOL	LEGEND
•	FLUORESCENT LIGHTING FIXTURE (SEE FIXTURE SCHEDULE)	8	FIRE ALARM SHUT DOWN RELAY (SEE DETAIL 7/E-3)
_	FLUORESCENT STRIP FIXTURE (SEE FIXTURE SCHEDULE)	0	PUBLIC ADDRESS/INTERCOM SPEAKER-CEILING
Ю	INCAN, OR H.I.D. LIGHTING FIXTURE (WALL BRACKET) SEE FIXT, SCHEDULE	4	DATA OUTLET TELEPHONE OUTLET
¢	INCAN. OR FLUORESCENT LIGHTING FIXTURE (DOWN LIGHT) SEE FIXT. SCHEDULE	₫	FLOOR TELEPHONE OUTLET SMOKE DETECTOR REMOTE INDICATOR/RESET
\$	S.P.S.T. TOGGLE SWITCH +42"AFF UNLESS NOTED OTHERWISE	SM	FIRE ALARM SPEAKER/STROBE
b	LIGHTING DIMMER 1000W UNLESS NOTED OTHERWISE	(C)	FIRE ALARM STROBE LIGHT ONLY FIRE ALARM PULL STATION
4.6	SWITCHING SEQUENCE	•	3 WIRE 10 OR 4 WIRE 30 SPECIAL PURPOSE OUTLET (SUFFIX INDICATES AMPS)
D	FLOOR RECEPTACLE GROUND TYPE DUPLEX RECEPTACLE 120V-20A. +18*AFF LINIESS NOTED OTHERWISE	2	EXHAUST FAN
we on	GROUND TYPE DUPLEX RECEPTACLE 120V-20A. WITH INTEGRAL GROUND FAULT INTERRUPT PROTECTION	⊠,	COMBINATION MOTOR STARTER SEE SCHEDULE FOR RATING
7	AND WEATHER PROOF COVER. TRANSFORMER - SEE SCHEDULE FOR RATING	ㅁ	DISCONNECT SWITCH SEE SCHEDULE FOR RATING
Δ	120/208V PANELBOARD	SST	STAINLESS STEEL
	277/480V PANELBOARD	1	DUCT MOUNTED SMOKE DETECTOR (PHOTO ELECTRIC TYPE)



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JFB

CHECKED BY: DRAWN BY: PII JJP ACCEPTED

CLUB

PROJECT NUMBER 100095

PROJECT LOCATION INTERNATIONAL AIRPORT

W.P.B. FL.

NOTES, RISERS AND SCHEDULES

DRAWING SCALE

REVISION DATES ADDENDUM 2 06.29.00
REVISED PER AIRPORT
OPERATIONS COMMENT
ISSUED FOR BID 06.14.00

ISSUE DATE ISSUED FOR PERMIT 05-26-00

SHEET NUMBER E-3

FIRE PROTECTION NOTES

- INSTALL SYSTEM IN ACCORDANCE WITH NFPA-13 AND THE REQUIREMENTS OF THE LOCAL AUTHORITY HAVING JURISDICTION. MATERIALS SHALL BE FM/UL LISTED FOR USE IN FIRE PROTECTION SYSTEMS, UNLESS OTHERWISE NOTED.
- HANGER LOCATIONS SHALL BE COORDINATED WITH THE BUILDING STRUCTURE. SUPPORT PIPING IN ACCORDANCE WITH NFPA-13, PROVIDE ALL MISCELLANEOUS STEEL FRAMING AS REQUIRED TO SUPPORT PIPING FROM STRUCTURE. HANGERS AND ROD SHALL HAVE A GALVANIZED OR FLATED FINISH.
- PROVIDE CHROME ESCUTCHEONS WHERE PIPING PENETRATES WALLS IN EXPOSED AREAS.
- 4. SPRINKLERS SHALL BE FROM A SINGLE MANUFACTURER AS FOLLOWS:
 - A. IN FINISHED CEILINGS, VIKING QUICK RESPONSE MODEL B-2 CONCEALED PENDENT TYPE, 1/2" ORFICE, K-5.5; POLISHED CHROME COVER, 155 DEGREE HEAD, UL LISTED.

ALTERNATE HEAD MANUFACTURERS: GRINNELL, CENTRAL, STAR OR RELIABLE.

- LAYOUT SHOWN IS DIAGRAMMATIC IN NATURE. THE INSTALLING CONTRACTOR IS SOLELY RESPONSIBLE TO COORDINATE EXACT HEAD LAYOUT WITH THE WORK OF OTHER TRADES TO AVOID OBSTRUCTIONS TO SPRINKLER DISCHARGE PATTERNS IN ACCORDINATE WITH INFRA-13.
- TEST SYSTEMS IN ACCORDANCE WITH NFPA-13 AND THE REQUIREMENTS OF THE AHJ, PREPARE "CONTRACTORS MATERIAL AND TEST CERTIFICATE" AS PRESCRIBED BY NFPA-13.
- PROVIDE SPRINKLER HEAD CABINETS WITH SPARE SPRINKLER HEADS OF EACH TYPE USED ON THE PROJECT, QUANTITY PER NFPA-13.
- 10. LABEL DRAIN PIPING, SHUT-OFF VALVES, AND SIMILAR COMPONENTS.
- SUBMIT FITTINGS PRODUCT DATA FOR ALL MATERIALS, INCLUDING PIPING FITTINGS, VALVES, HEADS, SUPPORTS AND SIGNS.
- LOADING FOR UPPER ATTACHMENTS SHALL BE BASED UPON THE MANUFACTURERS ALLOWABLE LOAD CAPACITIES. THE LOAD SHALL BE BASED UPON THE PIPE WEIGHT WITH WATER PLUS A 250 LB CONCENTRATED LOAD AT EACH HANGER PER NFPA-13.

	LEGEND
	EXISTING FIRE PROTECTION PIPING
	NEW FIRE PROTECTION PIPING
	PENDANT SPRINKLER HEAD
R.	RELOCATED SPRINKLER HEAD
0	REDUCER
RN	RISER NIPPLE
AHJ	AUTHORITY HAVING JURISDICTION
	UNION JOINT
•	NEW TO EXISTING
	END CAP
-od-	TEE - BRANCH OUT OF TOP
- → -	TEE - BRANCH OUT OF BOTTOM
* 7	


	DRAWING INDEX
SHEET	DESCRIPTION
FP-1	LEGEND, DETAILS, NOTES
FP-2	FIRE PROTECTION PLANS

WORK SCOPE


WORK INVOLVES RELOCATION OF EXISTING HEADS AND INSTALLATION OF NEW REPLACIENT HEADS FOR A PREVIOUSLY SPRINKLERED TENANT SPACE. NUMBER OF HEADS ON A BRANCH LINE IS CONSISTENT WITH THE EXISTING DESIGN. — NO HYDRAULIC IMPACT ON THE EXISTING SYSTEM.

GENERAL PROJECT NOTES

- ALL CONTRACTORS SHALL VISIT THE PROJECT SITE TO FAMILIARIZE THEMSELVES WITH SITE CONDITIONS
 PRIOR TO BIDDING.
- ALL BUILDING SYSTEMS (I.E., WAITER, SANTERY, FRE ALARM, ELECTRIC, ETC.) SHALL REMAIN IN OPERATION
 THROUGHOUT CONSTRUCTION. ALL NECESSARY INTERRUPTIONS FOR CONNECTION OF THEW WORK SHALL
 PERFORMAN OFTER NORMAL ISSUESS HOURS AND APPROVED BY THE BUILDING OWNER SY HOURS IN ADVANCE.
 JULESS SPECIFICALLY WOTED OTHERWISE, HERBIN, INSTALL ALL MATERIAL/PRODUCTS FOR THIS PROJECT
 IN STRICT ACCORDANCE WITH THE MAMPACTURERS LITEST PUBLISSES SPECIFICATION/SPECIMENDATIONS.
- CONTRACTOR SHALL NOT ALTER, LOAD OR PENETRATE THE STRUCTURE IN ANY MANNER WHICH MAY COMPROMISE ITS INTEGRATY.
- EVERY EFFORT HAS BEEN MADE TO ACCURATELY DEPICT EXISTING AND NEW CONDITIONS. HOWEVER, THE CONTRACTOR SHALL FIELD MEASURE ALL DISTANCES AND CLEARANCES PRIOR TO COMMENCEMENT OF WORK OR ORDERING OF MATERIALS. CONTRACTOR SHALL NOT SCALL DRAWINGS.
- 6. PERFORM ALL WORK IN STRICT ACCORDANCE WITH ALL STATE AND LOCAL CODES/ORDINANCES.

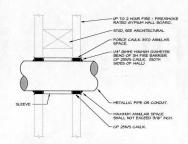

THROUGH GYPSUM WALL BOARD

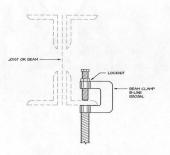


STEEL STRUCTURE

STITUS ATTACHMENT

STEEL STRUCTURE UPPER ATTACHMENT

BOTTOM ATTACHMENT SHOWN, USE B-LINE B3/033 FOR TOP FLANCE ATTACHMENT

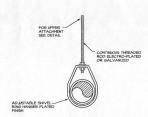

3 PIPE HANGER DETAIL

FP-1 HANGER SHALL BE UL LISTED GRINNEL FIGURE 64 SOME HOME
OR SIMILAR BY B-LINE OR MICHGAN.

U·S AIRWAYS

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FD

MDH CHECKED BY:

MDD ACCEPTED

SUBMITTED

PROJECT TITLE U.S. AIRWAYS

PROJECT NUMBER

CLUB

100095 PROJECT LOCATION

P.B.I.A. INTERNATIONAL AIRPORT W.P.B. FL.

DRAWING TITLE

NOTES AND DETAILS

DRAWING SCALE


ADDENDUM 2 06.29.00
APPLICATIONS COMMENTS
ISSUED FOR BID 06.14.00

ISSUE DATE ISSUED FOR PERMIT 05-26-00

SHEET NUMBE FP-1




- (2) ELIMINATE SECOND ROW OF PENDENT SPRINKLERS IN THE CONCOURSE.

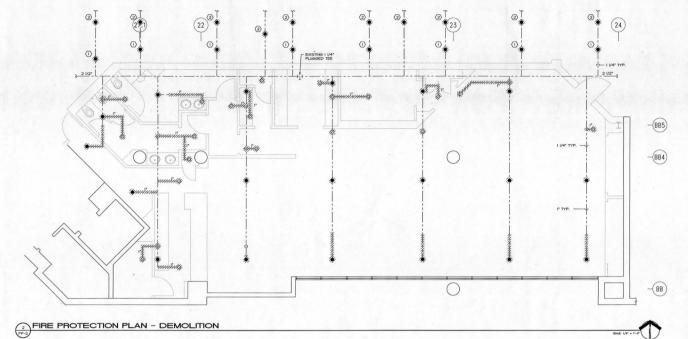

PLAN NOTES

- RELOCATED ROW OF CONCOURSE SPRINKLERS.
 CONNECT TO EXISTING I I/4 INCH PLUSGED TEE FOR NEH I INCH SPRINKLER HEAD DROP. FIELD VERIFY LOCATION OF TEE.
- (C) INSTALL I 1/4 INCH BRANCH CONNECTION AND TEE AT EXISTING CROSS MAIN.
- FRESTOP PIPE AT PENETRATION OF CONCOURSE HALL.

 BAFFLE REQUIRED IF SPRINCLER IN LOWER CEILING CAN BE REACHED BY SPRAY FROM SPRINCLER IN HOHER CEILING.
- (F) MAINTAIN 6'-0"+ SPACING BETHEEN SPRINKLER HEADS.

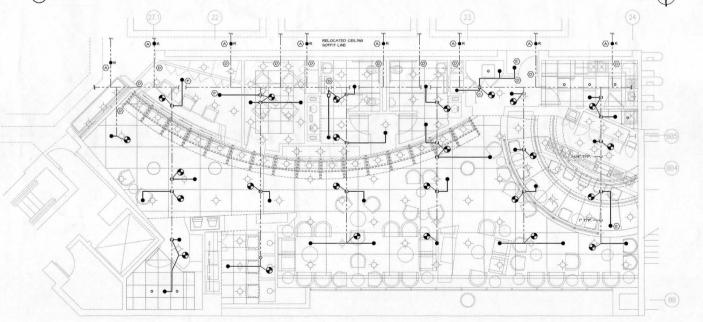

FIRE PROTECTION - NEW WORK



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ACCEPTED

PROJECT TITLE

U.S. AIRWAYS CLUB

PROJECT NUMBER

100095

W.P.B. FL.

INTERNATIONAL AIRPORT

DEMOLITION AND NEW WORK FLOOR PLANS

DRAWING SCALE

ADDENDUM 2 06,29,00
REVISED PER AIRPORT
OPERATIONS COMMENTS
ISSUED FOR BID 06,14,00

ISSUE DATE ISSUED FOR PERMIT 05-26-00

SHEET NUMBER FP-2

RNL	LEGEND RAIN MATER LEADER
	770000000000000000000000000000000000000
PDI	PLUMBING DRAINAGE INSTITUTE
AVTR	ACID VENT THRU ROOF
VTR	VENT THRU ROOF
HC	WATER CLOSET
UR	URINAL
LAV	LAVATORY
99	SERVICE SINK
ENC	ELECTRIC WATER COOLER
HH	MATER HEATER
SH	SHOWER
5	SINK
FD	FLOOR DRAIN
	COLD HATER (CH)
	HOT HATER (HH)
	SOIL OR HASTE (BURIED)
	VENT LINE
	UNION JOINT
	FLANGE JOINT
7	"Y" STRAINER
0-0-	TEE - UP, BRANCH OUT OF TOP
-OO-	TEE - DOWN, BRANCH OUT OF BOTTOM
-0	ELBOW - UP
	ELBOW - DOWN
-0-	RISE OR DROP
TO 🔓 📵 -	FLOOR DRAIN & TRAP (TYPE AS NOTED,
->4-	GATE VALVE
-be)	BALL VALVE
-ri-	CHECK VALVE
1	

MARK	DESCRIPTION	MANUFACTURER	MODEL	FITTINGS OR VALVES	SUPPLIES	TRAP	CARRIER	ACCESSORIES	COLD	HOT	WASTE	VENT	REMARKS
P-I	WALL MOUNTED WATER CLOSET	AMERICAN STANDARD	AFWALL 2257.103 1.5 GPF	SLOAN ROYAL 111	-	1	ZURN Z-1204 SERIES	CHURCH #9500C SEAT	1-1/4*	-	2,	2*	MOUNT AT HANDICAP HEIGHT
P-2	WALL MOUNTED WATER CLOSET	AMERICAN STANDARD	AFWALL 2257.103 1.5 GPF	SLOAN ROYAL 111	1		ZURN Z-1204 SERIES	CHURCH #9500C SEAT	1-1/4"	-	2,	2"	MOUNT AT STANDARD HEIGHT
P-3	WALL MOUNTED URINAL	AMERICAN STANDARD	ALLBROOK 6540.017 1 GPF	SLOAN ROYAL 180-1	1		-		1-1/4"	-	2*	1-1/2"	
P-4	COUNTERTOP MOUNTED LAVATORY	CORIAN	820 A/S	CHICAGO 552 ELECTRONIC FAUCET W/ #119 MIX. VALVE	McGUIRE #158LK	McGUIRE #8872 P−TRAP	1	0059.020 SHROUD/KNEE GUARD	1/2"	1/2"	1-1/2*	1-1/2"	1 1 1 1
P-5	MOP SINK MOLDED STONE	FIAT	MSB-2424	#830-AA	1/2" COPPER	2" DWV P-TRAP	-	#832-AA HOSE AND BRACKET #889-CC S. S. MOP HANGER	1/2"	1/2"	2"	1 1/2"	MSG-2424 S.S. WALL GUARDS
P-6	HANDICAP WALL MOUNTED LAVATORY	AMERICAN STANDARD	MURRO 0955.000 VITREOUS CHINA	CHICAGO #857E3VP-669	McGUIRE #2167LK W/C.P. NIPPLES	McGUIRE #8872 W/CLEANOUT	WALL BRACKET	McGUIRE # 155-WC GRID DRAIN	1/2"	-	1-1/2*	1 1/2*	PROVIDE TRUEBRO #101 LAV-GUAR KIT W/ #105 ACCESSORY IN WHIT
		-											

NOTES:

1. REFER TO PLANS AND SPECIFICATIONS FOR ADDITIONAL REQUIREMENTS FOR FIXTURES AND EQUIPMENT FURNISHED UNDER OTHER DIVISIONS OF HORK,

PLUMBING NOTES:

- I. ALL WORK AND MATERIALS SHALL COMPLY WITH THE STANDARD PLUMBING CODE.
- THE POTABLE WATER PORTION OF THE PLIMBING SYSTEM SHALL BE DISINFECTED IN ACCORDANCE WITH THE STANDARD PLIMBING CODE.
- TESTING PRIOR TO CONCEALMENT:

 A. HATER SYSTEM TEST AT 125 PSI FOR 12 HOURS.
 B. SANTARY SEWER TEST AT 5 PSI FOR 12 HOURS.
- CONFIRM SIZE LOCATION AND ELEVATION OF ALL EXISTING UTILITIES PRIOR TO INSTALLING ANY PIPE. ALL DISCREPANCIES SHALL BE ERCUGHT TO THE ATTENTIO OF THE ARCHITECT.
- PROVIDE 3/4" AIR CHAMBERS AT ALL PLUMBING FIXTURES.
- CONFLICT BETWEEN AND SPECIFICATIONS, THE DRAWINGS SHALL TAKE PRECEDE
- PROVIDE TRAP PRIPERS FOR ALL FLOOR DRAINS. PRIPER SHALL BE CONNECTE TO THE DISCHARGE PIPE OF A FLUSH VALVE ON A K.C. IF FLUSH VALVE IS NOT AVAILABLE CONNECT TO THE TAILPIECE OF A LAVATORY.
- PROVIDE A SHUT OFF VALVE IN HOT AND COLD WATER LINES SUPPLYING FIXTURE AT EACH SEPARATE SPACE.
- PROVIDE A GALVANIZED DRAIN PAN UNDER HATER HEATER WITH A I* DRAIN LINE TERMINATING OUTSIDE.
- IO. DRAHINGS ARE DIAGRAMMATIC AND ALL FITTINGS AND OFFSETS ARE NOT INDICATED, ANY REGUIRED MATERIAL FOR OFFSETS AND COORDINATION WITH
- II. CONTRACTOR IS DIRECTED TO OBTAIN COPIES OF ALL RELATED PLANS SPECIFICATIONS, SHOP DRAHINGS AND ADDENO'S TO COORDINATE THE HORK.
- CONFIRM LOCATION AND ELEVATION OF ALL CROSSING LINES PRIOR TO INSTALLING ANY PIPE. ALL DISCREPANCIES SHALL BE BROUGHT TO THE ATTENTION OF THE ARCHITECT.
- IS. THE CONTRACTOR SHALL BIPLOY A LICENSED JOURNEYMEN PLIMBER ON THE JOB THROUGHOUT THE ENTIRE PERIOD OF CONSTRUCTION.
- LOCATION OF ALL CONDENSATE DRAINS SHALL BE COORDINATED WITH THE HVAC CONTRACTOR, DRAINS SHALL NOT BE LOCATED INDER THE AIR HANDLERS.


		STORAGE	RECOVERY		GAS		ELEC	TRICAL	WATER	
DESIGNATION	MFGR./MODEL	CAP. (GAL.)	CAPACITY	TYPE	PIPE	INPUT MBTUH	KW	VOLT/ PHASE	CONN.	ACCESSORIES
A	A. O. SMITH DEN-66	66	35.1 G.P.H. © 70° RISE	-	-	-	6.0	208/	3/4"	P & T RELIEF VALVE ADJUSTABLE MOUNTING SHELF

NOTES : L. ALTERNATE MYGERS, LOCHEVAR, STATE, APPROVED EQUAL, REFER TO SPECIFICATION SECTION IS 400 FOR ADDITIONAL REQUIREMENTS.

2. RECOVERY CAPACITIES ARE BASED ON IOON RECOVERY EMPLOYERY.

3. CRICULATING PAPP FOR NATE MATER ATTER (3) SALL BE A DIS MOVEL ILR-188 MITH 3/4" PLANSES, IZOV, 10

MARK	SELECTION	BASED ON	SIZE	PIPE	TOP	ACCESSORIES	REMARKS
MARK	MAKE	MODEL	SILE	CONNECTION	MATERIAL	AUCESSUNIES	nemnna
FD	J.R.SMITH	2010-8	6*	3*	NICKLE BRONZE	PRIMER TAP	-
FS	J.R.SMITH	3140-Y-PB	12"	3-	NICKEL BRONZE	3/4 GRATE	DEEP SEAL TRAP MIN. 4" SEAL (

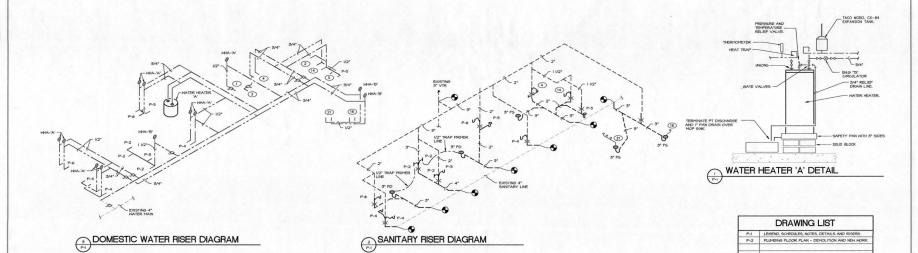



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AKCHIRCT



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CHECKED BY: DRAWN BY:

RRB MPJ

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PROJECT TITLE

U.S. AIRWAYS CLUB

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P.B.I.A.
INTERNATIONAL AIRPORT
W.P.B. FL.

DRAWING TITLE
LEGEND, SCHEDULES,
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DRAWING SCALE
AS NOTED

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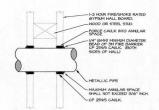
ISSUE DATE

ISSUED FOR PERMIT 05-26-00 SHEET NUMBER

P-1




- REMOVE ALL EXISTING PLIMBING PIXTURES AND ASSOCIATED PIPING, REMOVE PIPING BACK TO CONSECTION AT HANN AND CAP, REMOVE ALL UNISED PIPING SO THAT THERE IS NO MORE.
- 2 REMOVE ALL EXISTING FLOOR DRAINS AND CAP BRANCH NO MORE THEN 2 FEET FROM MAIN, PATCH FLOOR TO MAINTAIN 2-HOUR RATING, SEE ARCHITECTURAL FOR OTHER PATCH BROUBERMENTS.
- REMOVE ALL PIPING ASSOCIATED WITH THE BAR EQUIPMENT AND CAP AS NOTED IN NOTE I.




FIRESTOP DETAIL

U. SYSTEM #141 - MANUFACTURERS REQUIREMENTS GOVERN.

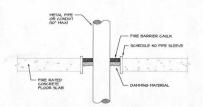

FLOOR PENETRATION DETAIL UL SYSTEM NO. CALBOOI (FORMALLY M49) - TYPICAL FOR ALL FLOOR PENETRATIONS SCALE NO.

EM	DESCRIPTION	CW	HW	WASTE	VENT	GAS	REMARKS
1)	ICE MACHINE	V2*	-	I' IN		-	0
2	COFEE BREWER	V2*	-				
3)	DISHMASHER	V2*	V2*	5/4°H		-	2
4)	COUNTER SINK 2-COMP	1/2*	V2*	1 1/2"		-	
5)	MOP SINK	V2*	V2*	3.	1 1/2*		
4	COUNTER SINK I-COMP	V2*	V2*	1 1/2*	1 1/2*	- 2	
5)	MODULAR BAR	-		-	-		
6	HAND SINK	1/2*	V2*	1 U2*	11/2*	-	
7)	DRAIN BOARD	-	-	1" 114		-	0
8	ICE CHEST	-	-	PH			0
21)	3-COMP SINK	1/2*	V2*	2° IH		-	0

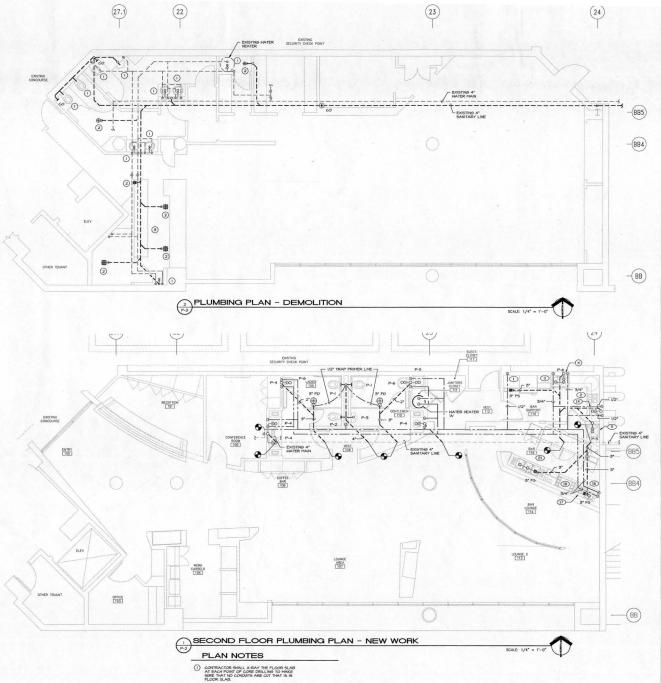

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PGAL
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Planning

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Mak Owel

MEP ENGINEER

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APPROVED

U.S. AIRWAYS

CLUB

PROJECT NUMBER

PROJECT LOCATION

P.B.I.A. INTERNATIONAL AIRPORT W.P.B. FL

DEMOLITION AND NEW WORK PLUMBING FLOOR PLANS

1/4" = 1'-0"

DRAWING TITLE

ADDENDUM 2 06.29.00
ADDENDUM 2 06.29.00
REVISED PER AIRPORT
OPERATIONS COMMENTS
ISSUED FOR BID 06.14.00

ISSUE DATE
ISSUED FOR PERMIT
05-26-00

P-2